Department of Planning and Development

VARIANCE **APPLICATION**

Owner: Robert & Sally Griffin	KECEIVED	
Mailing Address: ⁷ 655 Lilly Lake Rd, Burlington, WI 53105	DEC 2 8 2023 Kenosha County Planning and Development	
Phone Number(s): 7738201002 (Robert)	ment	
To the Kenosha County Board of Adjustment:	nit by the Kenosha County Depar	

Please take notice that the undersigned was refused a Zoning Permit by the Kenosha County Department of Planning and Development for lands described below for the reason that the application failed to comply with the Kenosha County General Zoning and Shoreland/Floodplain Zoning Ordinance. owner or assigned agent herewith appeals said refusal and seeks a variance.

Parcel Number: 95-4-119-111-3140	Zoning District	Zoning District: R-4								
Property Address:7655 Lilly Lake Rd.	Shoreland: Ye	S								
Subdivision: SUMMERHAVEN	Lot(s): <u>34</u>	Block: N/A								
Current Use: RESIDENTIAL										
Proposal: RESIDENTIAL (NO CHANGE)										

REQUIRED BY ORDINANCE VARIANCE REQUESTED Non-conforming structures which are located less than fifty (50) Section: V. B. 12.28-7 0' Streetyard Setback percent of the minimum setback requirement from one or more of their yard setback requirements may be structurally enlarged or expanded so long as all four sides of the enlargement or expansion are located at least 50% of the minimum setback requirement. For a lateral expansion of a non-conforming principal structure Keep Existing Decks, Section: III. L. 12.18-10(b)2 _ located between 35 and 75 feet from the ordinary high-water Patio & Retaining Walls mark and which is less than 35 feet in height removal of all nonconforming accessory structures located in the shore setback area is required. Section: IV. C. 12.21-4 (g)3 _ All buildings shall be located at least 10 5' side yard setback feet from any side property line.

An Area Variance is authorization by the Kenosha County Board of Adjustments to vary one or more of the dimensional or physical requirements of the applicable zoning law, code or ordinance in connection with some proposed construction.

The burden will be on you as property owner to provide information upon which the board may base its decision. At the hearing, any party may appear in person or may be represented by an agent or attorney. You or your agent must convince the zoning board to make a ruling in your favor. The board must make its decision based only on the evidence submitted to it at the time of the hearing. Unless you or your agent is present, the board may not have sufficient evidence to rule in your favor and must then deny your application.

(1) Describe alternatives to your proposal such as other locations, designs and construction techniques.

Attach a site map showing alternatives you considered in each category below:
(A) Alternatives you considered that comply with existing standards. If you find such an alternative you can move forward with this option with a regular permit. If you reject compliant alternative provide the reasons you rejected them.
(B) Alternatives you considered that require a lesser variance. If you reject such alternatives, provide the reasons you rejected them.
(2) Will there be an unnecessary hardship to the property owner to strictly comply with the ordinance?

(2) Will there be an unnecessary hardship to the property owner to strictly comply with the ordinance?

Unnecessary hardship exists when compliance would unreasonably prevent the owner from using the property for a permitted purpose (leaving the property owner without any use that is permitted for the property) or would render conformity with such restrictions unnecessarily burdensome.

An applicant may not claim unnecessary hardship because of conditions which are self-imposed or created by a prior owner (for example, excavating a pond on a vacant lot and then arguing that there is no suitable location for a home or claiming that they need more outbuilding space than that permitted to store personal belongings). Courts have also determined that economic or financial hardship does not justify a variance. When determining whether unnecessary hardship exists, the property as a whole is considered rather than a portion of the parcel. The property owner bears the burden of proving unnecessary hardship.

VARIANCE APPLICATION

(3) Do unique physical characteristics of your property prevent compliance with the ordinance? If yes please explain.
Unique physical limitations of the property such as steep slopes or wetlands that are not generally shared by other properties must prevent compliance with the ordinance requirements. The circumstances of an applicant (growing family, need for a larger garage, etc.) are not a factor in deciding variances. Nearby ordinance violations, prior variances or lack of objections from neighbors do not provide a basis for granting a variance.
(4) What would be the effect on this property, the community or neighborhood and the public interest if the
(4) What would be the effect on this property, the community or neighborhood and the public interest if the variance was granted? How can these impacts be mitigated.
These interests are listed as objectives in the purpose statement of an ordinance and may include: drainage, visua impact, and fire safety and building code requirements.
The undersigned hereby attests that the above stated information is true and accurate and further gives permission to Planning & Development staff and Board of Adjustment members to view the premises, in relation to the Appeal request made herein, during reasonable daylight hours.
Owners Signature:
Agent: Signature:
Agents Address:
Phone Number(s):

19600 75th Street, Suite 185-3 Bristol, WI 53104-9772

Phone: (262) 857-1895 Fax: (262) 857-1920

ZONING PERMIT APPLICATION

havir Plan user	rou would rather apply for your zoning ping to travel to and from this office to suning & Development Online Portal at the account. Once your account is created the portal, you do not need to complete/sune	ubmit hardcopy do web address show you can login in un	cumentation and wn below, clickin der said credent	d physical paym ng on "Setup an <i>i</i>	ient, you ca Account" an	n do so by d creating a	visiting the new public
	<u>ht</u>	tps://permitting.ker	oshacounty.org/	<u>'eTrakit/</u> .			
1.	What is the Property Address (must incl	ude house number) <u>or</u> Tax Key Par	cel Number?			
2.	Who owns the subject property (property	y owner)?					
	Property Owner Name:						
	Property Owner Mailing Address:						
	Property Owner Phone Number:						
	Property Owner Email Address:						
3.	Who is applying for and will be signing for	or this permit (appli	icant)?				
	Applicant Name:						
	Applicant Mailing Address:						
	Applicant Phone Number:						
	Applicant Email Address:						
4.	Who is constructing the proposed struct	ures (contractor)?					
	Contractor Name:						
	Contractor Mailing Address:						
	Contractor Phone Number:						
	Contractor Email Address:						
5.	What is it you are proposing to construct You can apply for up to four separate str		rmit application.				
	STRUCTURE DESCRIPTION	TYPE OF CONSTRUCTION	SIZE (FENCE)	SIZE (BLDG.) (L' x W')	AREA (sq. feet)	HEIGHT (feet)	# OF STORIES
	DESCRIPTION	CONSTRUCTION	(L' @ H')	(L ^ VV)	(34. IEEI)	(IEEL)	STURIES

STRUCTURE DESCRIPTION	TYPE OF CONSTRUCTION	SIZE (FENCE) (L' @ H')	SIZE (BLDG.) (L' x W')	AREA (sq. feet)	HEIGHT (feet)	# OF STORIES

If you are proposing to construct a principal building such as a new residence or new commercial/industrial building, an addition thereto, or a detached accessory building greater than 150 sq. ft. in area, it is required that a professional surveyor be hired to complete a foundation survey of the property after the foundation is installed for the permitted building and submit said survey document to this office in order to prove that the proposed building has been constructed in the correct location and meets setback requirements.

This section is not applicable for sheds equal to or less than 150 sq. ft. in area or other accessory structures such as decks, fences and pools.

I anticipate that a foundation survey will be submitted to this office no later than (insert date).

We understand this deadline needs to be flexible due to reasons such as weather, construction delays, etc., however a due date later than 18 months from the date of permit issuance will not be accepted. If a foundation survey is not received by the anticipated due date, the property owner will receive an automated letter notifying them of past due status. If a mutually agreed revised due date is not set, and a foundation survey is not submitted, violation and enforcement will proceed.

7. Does your project involve the placement of any fill material on the subject property such as dirt, gravel, landscape timbers, rock, shoreline protection material, etc....?

If so, what type of material and how much?

- 8. If your property is served by a private onsite wastewater treatment system (POWTS) note that pursuant to Comm 83.25(2)(c), Wisconsin Administrative Code a County shall not issue a zoning permit for the addition to a structure that will modify the design wastewater flow or contaminant load or both to an existing (POWTS) unless the owner of the property:
 - 1. Possess a sanitary permit to either modify the existing PÓWTS or construct a PÓWTS to accommodate the modification in wastewater flow or contaminant load or both: or
 - 2. Provides documentation to verify that the existing POWTS is sufficient to accommodate the modification in wastewater flow or contaminant load or both.
 - 3. For the purpose of this ordinance, a modification in wastewater flow or contaminant load or both shall be defined as:
 - a. Commercial Facilities, public building and places of employment when there is a proposed change in occupancy of the structure; or the proposed modification affects either type or number of plumbing appliances, fixtures or devices discharging to the system.
 - b. Dwellings that have an increase or decrease in the number of bedrooms and/or additions, interior modifications, renovations or remodeling or any combination thereof that enlarges or impacts a dwelling's building area and/or floor area by 25% or greater. For purposes of this ordinance and this provision only, a modification in wastewater flow or contaminant load or both may result in; a change in roofline, the conversion of storage area to building area or floor area, re-wiring, re-insulating, re-constructing a foundation, enclosing open porches, decks or patios, replacing drywall, plaster or paneling, removal or construction of interior walls. A modification in wastewater flow or contaminant load or both does not result in the construction of open decks, patios or porches, garages, re-roofing, painting, wiring, re-siding, window replacement or the replacement of equipment or appliances.

If you have questions regarding this requirement, please contact the County Sanitarian at this office at 262-857-1910.

A bedroom is defined as a room used to sleep in, containing a closet for storage of clothing and a doorway with a door for privacy.

- 9. If your project requires improvements or alterations (such as the installation of a driveway apron) within a state highway right-of-way, then you must contact the <u>Wisconsin Department of Transpiration</u> (WISDOT) regarding allowances and permitting requirements for said improvements.
- 10. If your project requires improvements or alterations (such as the installation of a driveway apron) within a county trunk highway right-of-way, then you must contact the Kenosha County Division of Highways regarding allowances and permitting requirements for said improvements.
- 11. If your project requires improvements or alterations (such as the installation of a driveway apron) within a local town/village/city road right-of-way, then you must contact the <u>local municipality</u> regarding allowances and permitting requirements for said improvements.

IF ISSUED, THIS ZONING PERMIT IS ISSUED SUBJECT TO:

- 1. ANY FEDERAL, STATE OR LOCAL RESTRICTIONS AND/OR DEED RESTRICTIONS.
- 2. EACH APPLICANT FOR A ZONING PERMIT IS CHARGED WITH KNOWLEDGE OF THE MUNICIPAL ZONING ORDINANCE. COPIES OF THE TEXT OF THIS OR PORTIONS THEREOF AND COPIES OF THE OFFICIAL ZONING MAPS ARE AVAILABLE FOR SALE, COPYING OR INSPECTION UPON REQUEST. ANY STATEMENT MADE, SITE PLAN SUBMITTED, ASSURANCE GIVEN OR PERMIT ERRONEOUSLY ISSUED CONTRARY TO THIS ORDINANCE IS NULL AND VOID.
- 3. THIS PERMIT SHALL EXPIRE EIGHTEEN (18) MONTHS FROM DATE OF ISSUANCE.
- 4. ANY ADDITIONAL CONDITIONS WRITTEN BY THE ZONING ADMINISTRATOR ISSUING THE ZONING PERMIT.

NOTICE: YOU ARE RESPONSIBLE FOR COMPLYING WITH STATE AND FEDERAL LAWS CONCERNING CONSTRUCTION NEAR OR ON WETLANDS, LAKES, AND STREAMS. WETLANDS THAT ARE NOT ASSOCIATED WITH OPEN WATER CAN BE DIFFICULT TO IDENTIFY. FAILURE TO COMPLY MAY RESULT IN REMOVAL OR MODIFICATION OF CONSTRUCTION THAT VIOLATES THE LAW OR OTHER PENALTIES OR COSTS. FOR MORE INFORMATION, VISIT THE DEPARTMENT OF NATURAL RESOURCES WETLANDS IDENTIFICATION WEB PAGE http://dnr.wi.gov/topic/wetlands/locating.html OR CONTACT A DEPARTMENT OF NATURAL RESOURCES SERVICE CENTER (262) 884-2300.

AMBIT LAND SURVEYING 8120-312th Avenue Wheatland, WI. 53105-8934 Licensed Professionals in

both Illinois & Wisconsin

PLAT OF SURVEY

OF

PHONE: 262-537-4874

262-537-4221

EMAIL: ambitpls@gmail.com

FAX:

Lot 34 of LILY LAKE SUBDIVISION, a subdivision of part of the Northeast and Southeast Quarter of Section 11, Township 1 North, Range 19 East of the 4th Principal Meridian, lying and being in the Town of Wheatland, Kenosha County, Wisconsin.

PARCEL IDENTIFICATION NO.: 95-4-119-111-3140



BenchTie nail in west face of utility pole # E66-131156. ELEVATION = 785.29 feet, N.G.V.D. 1929 SITE BENCHMARK:

MISCONSIN ☆ MARK A BOLENDER S-1784 WHEATLAND LAND SURVEYOR

Fieldwork completed on and date of certification: $\underline{\text{December}}$ 12, 2005

I hereby certify that I have surveyed the above described property and the above plat is a true representation thereof and shows the size and location of the property, its exterior boundaries, the location and dimensions of all visible structures thereon, boundary fences, apparent easements and roadways and visible encroachments, if any.

This survey is made for the exclusive use of the present owners of the property, and also those who purchase, mortgage or guarantee the title thereto within ONE YEAR from the date hereof.


Dated at Wheatland, Wisconsin this 19th day of December

Mark A. Bolender

Wisconsin Professional Land Surveyor - 1784

SCALE: 1 inch = 30 feet

ORDERED BY: B. Griffin **JOB NO.:** 2 3 1 6 2

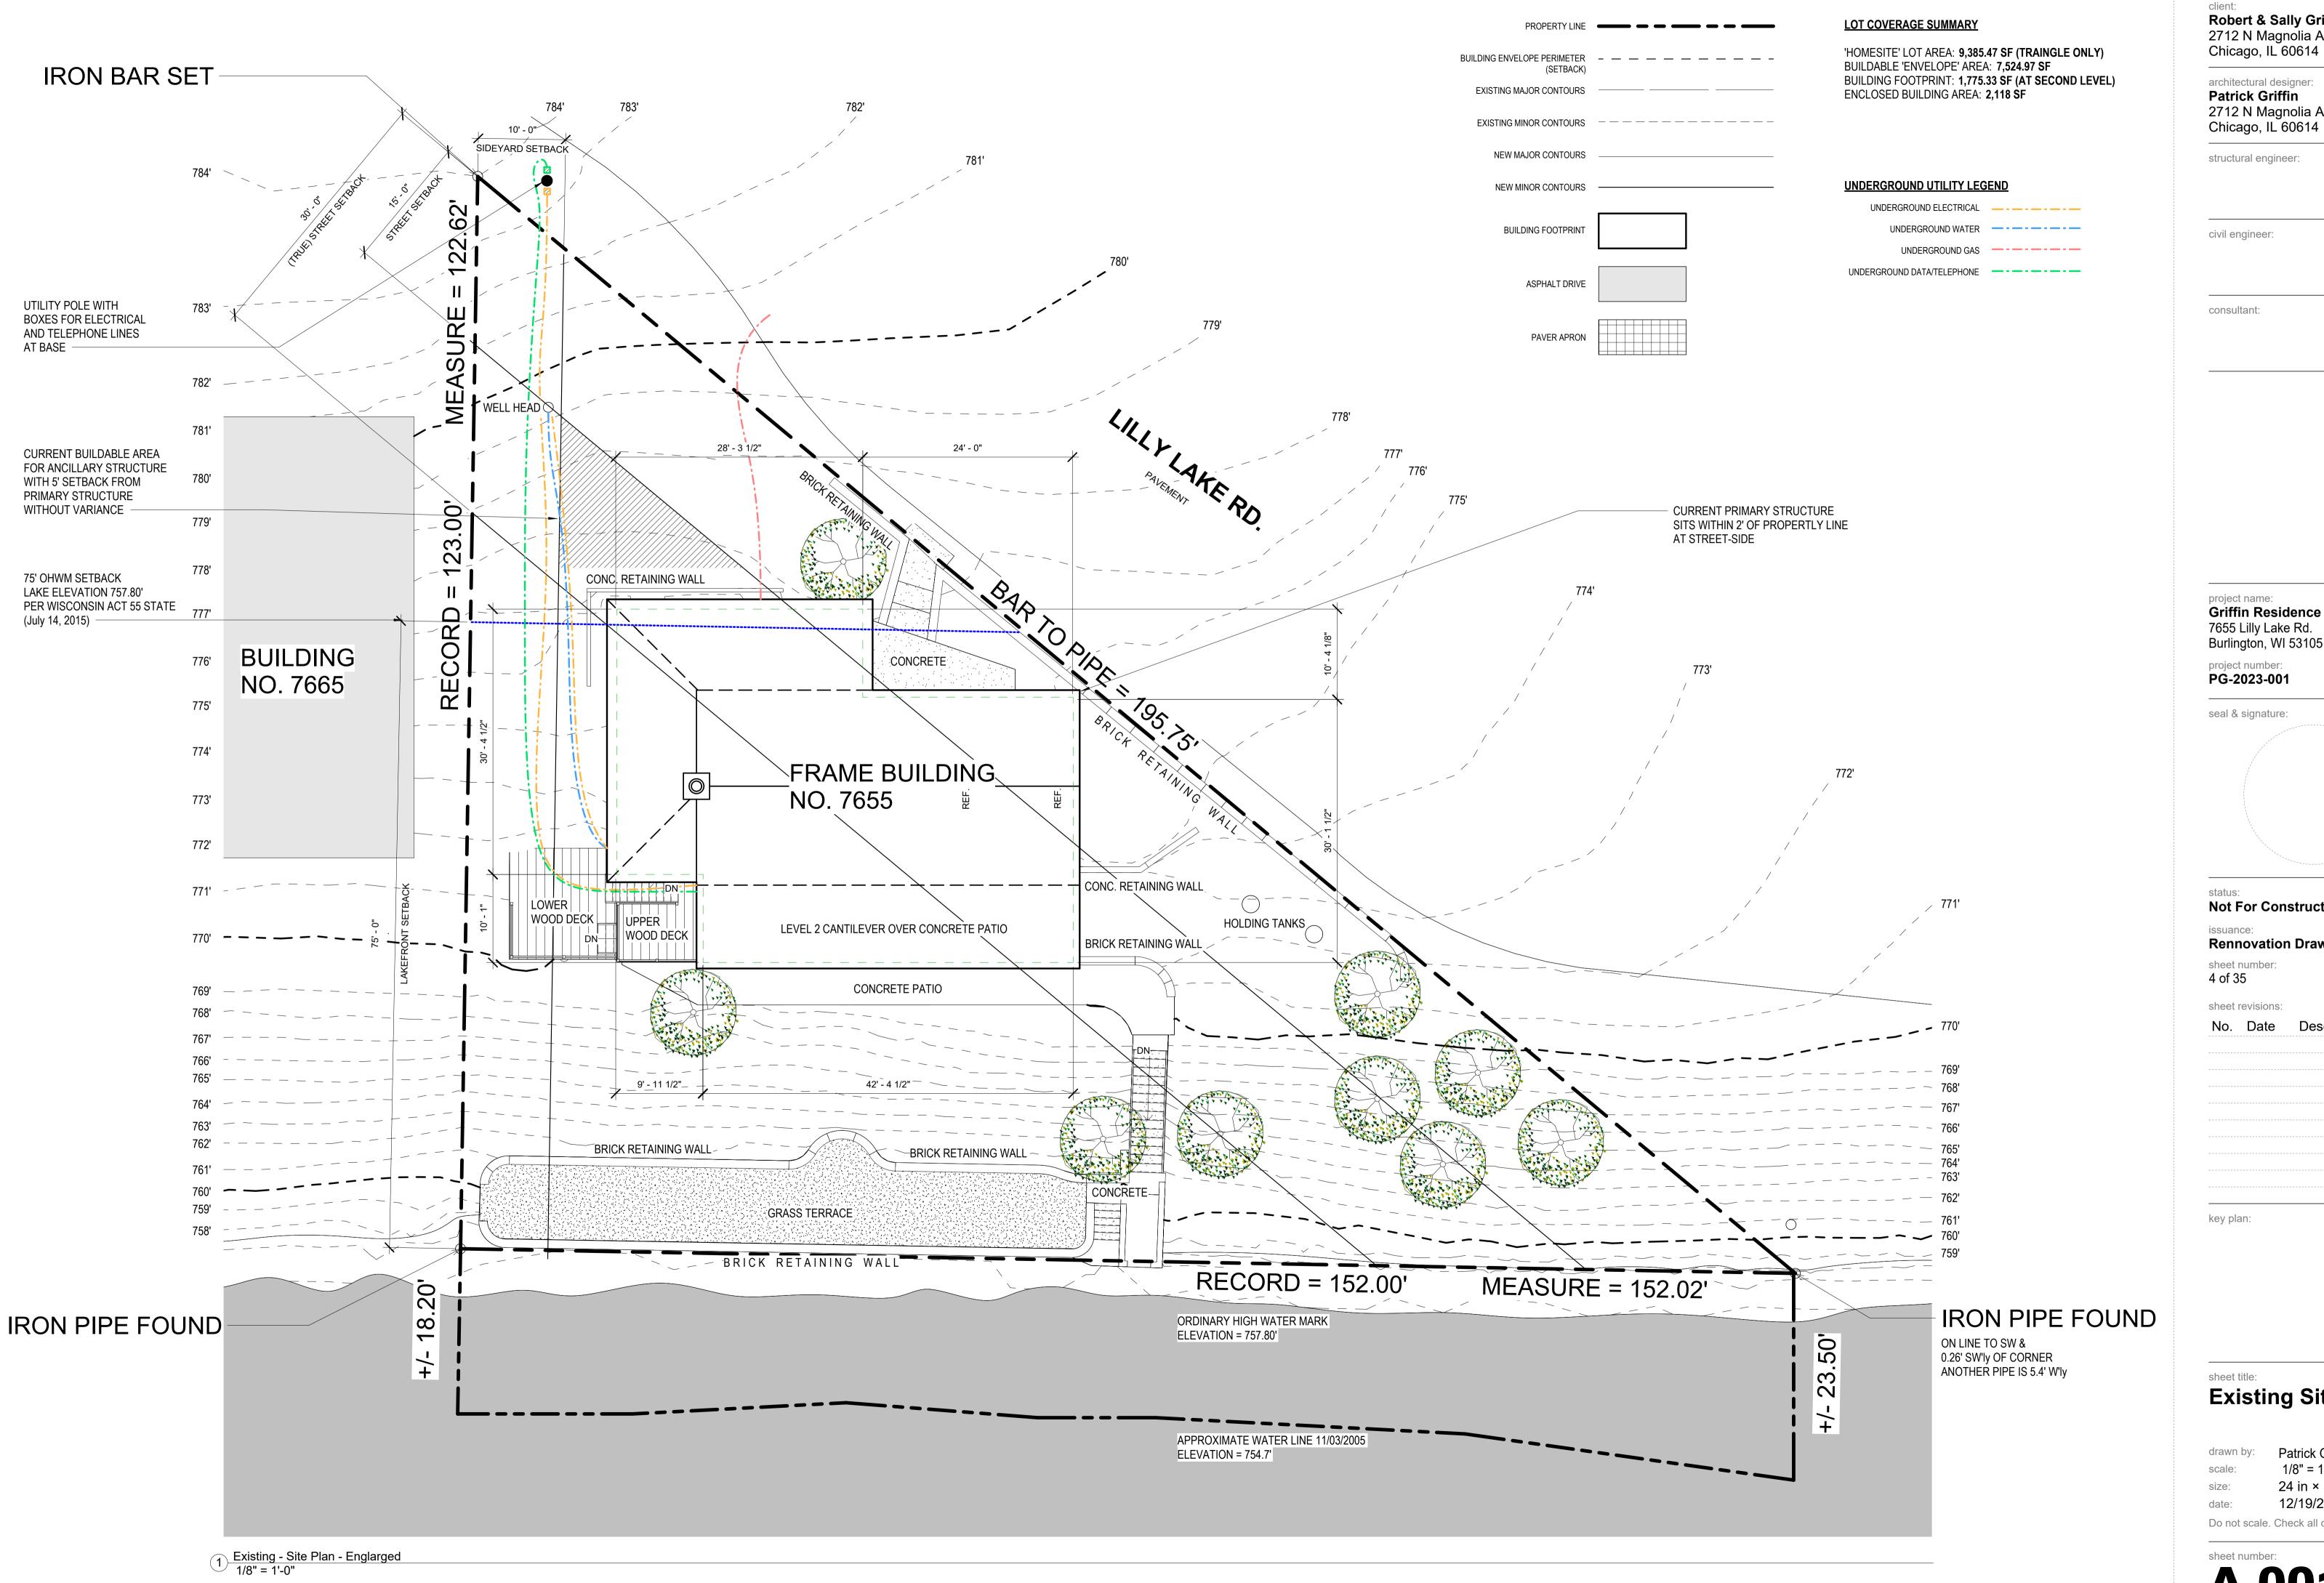

Robert & Sally Griffin 2712 N Magnolia Ave, Chicago, IL 60614

architectural designer:
Patrick Griffin 2712 N Magnolia Ave,

structural engineer:

civil engineer:

consultant:

project name:

Griffin Residence 7655 Lilly Lake Rd. Burlington, WI 53105

PG-2023-001

seal & signature:

Not For Construction

Rennovation Drawings V5

sheet number: 4 of 35

sheet revisions:


No. Date Description

Existing Site Plan

Patrick G 1/8" = 1'-0" 24 in × 36 in 12/19/2023 12:51:59 PM

Do not scale. Check all dimensions on site.

A-001.02

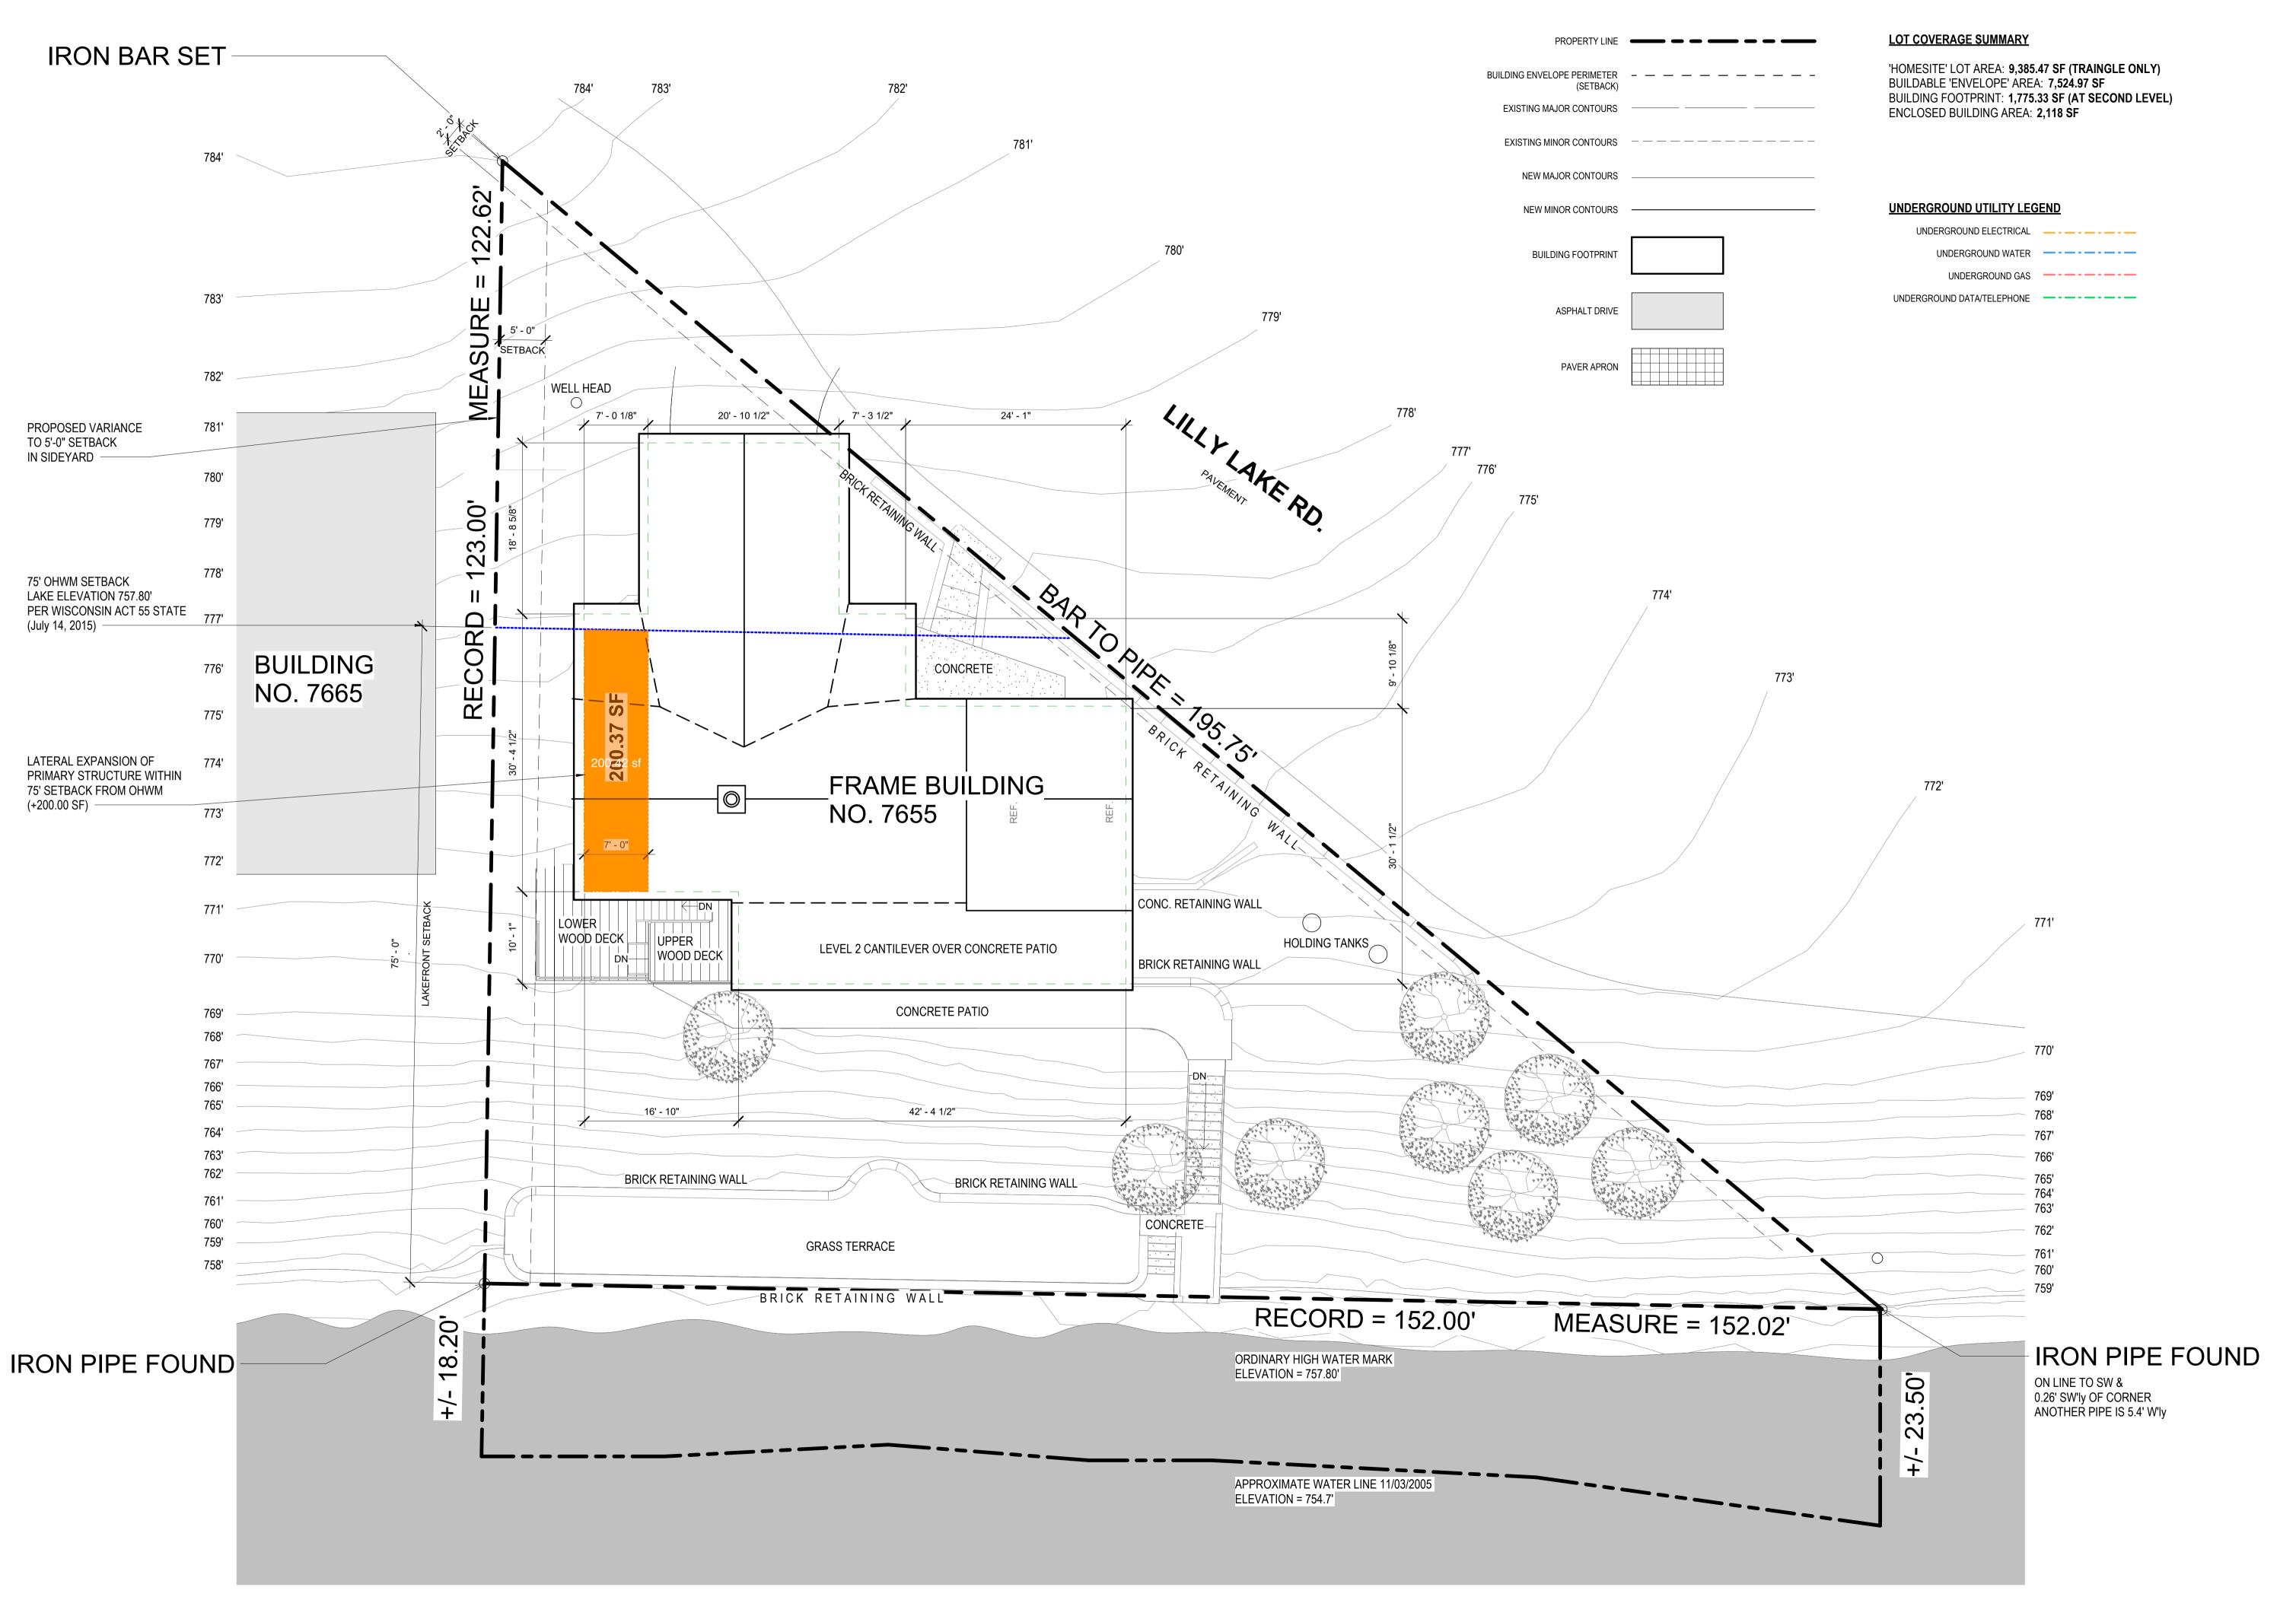

Robert & Sally Griffin 2712 N Magnolia Ave, Chicago, IL 60614 architectural designer: Patrick Griffin 2712 N Magnolia Ave, Chicago, IL 60614 structural engineer: civil engineer: consultant: project name: **Griffin Residence** 7655 Lilly Lake Rd. Burlington, WI 53105 project number: PG-2023-001 seal & signature: **Not For Construction** Rennovation Drawings V5 sheet number: 6 of 35

sheet revisions:

No. Date Description

key plan:


sheet title

Rennovated Site Plan


drawn by: Patrick G
scale: 1/8" = 1'-0"
size: 24 in × 36 in
date: 12/19/2023 12:52:03 PM

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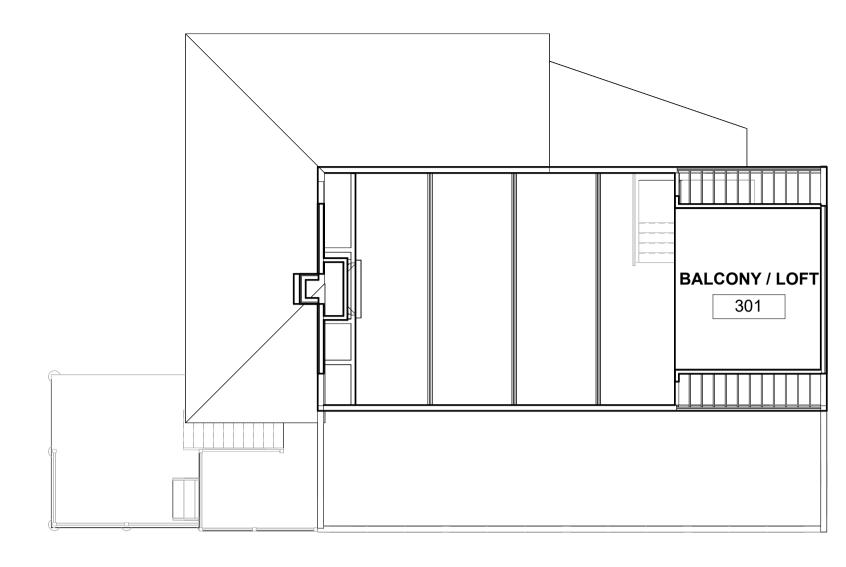
A-001.04

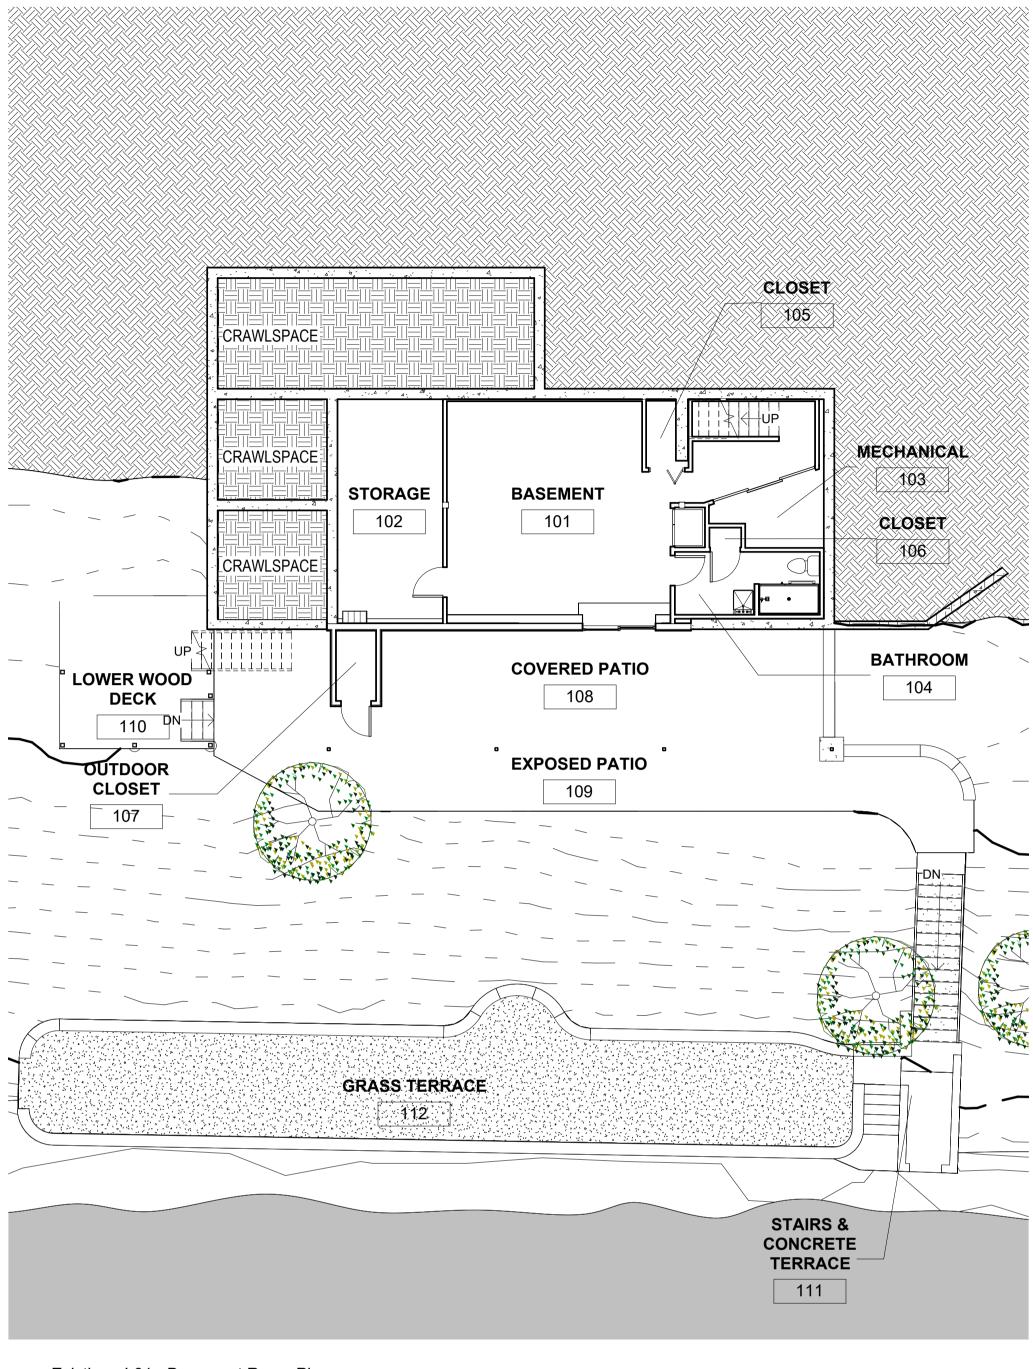

1 Existing - L01 - Basement Room Plan 1/8" = 1'-0"

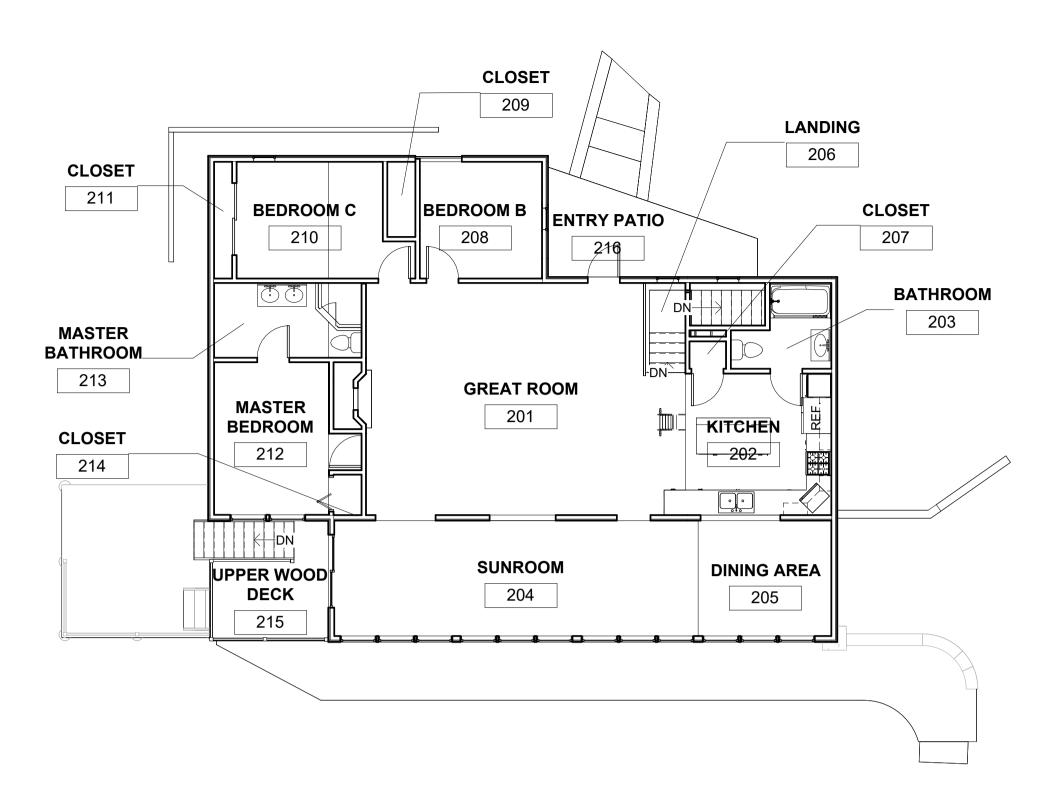

2 Existing - L02 - Main Floor Room Plan 1/8" = 1'-0"



3 Existing - L03 - Balcony Room Plan
1/8" = 1'-0"

EXTERIOR AREA SCHEDULE

NAME	NUMBER	AREA	PERIMETER	NOTES
OUTDOOR CLOSET	107	19 SF	18' - 4"	(BELOW OR ABOVE OTHER)
COVERED PATIO	108	386 SF	105' - 6"	(BELOW OR ABOVE OTHER)
UPPER WOOD DECK	215	100 SF	42' - 0"	(BELOW OR ABOVE OTHER)
(BELOW OR ABOVE OTHER): 3		506 SF		
EXPOSED PATIO	109	393 SF	162' - 9"	IMPERVIOUS SURFACE
LOWER WOOD DECK	110	159 SF	50' - 3"	IMPERVIOUS SURFACE
STAIRS & CONCRETE TERRACE	111	157 SF	73' - 11"	IMPERVIOUS SURFACE
ENTRY PATIO	216	148 SF	66' - 5"	IMPERVIOUS SURFACE
IMPERVIOUS SURFACE: 4		857 SF		
GRASS TERRACE	112	747 SF	158' - 0"	PURVEOUS SURFACE
PURVEOUS SURFACE: 1		747 SF		
GRAND TOTAL: 8		2109 SF		

LOT SURFACE COVERAGE

'HOMESITE' LOT AREA: 9,385.47 SF (TRAINGLE ONLY) BUILDABLE 'ENVELOPE' AREA: 7,524.97 SF

MAX. UMITIGATED IMPERVIOUS SURFACE AREA: (9,385.47x0.30) = 2,815.5 SF MAX. MITIGATED IMPERVIOUS SURFACE AREA: (9,384.47x0.40) = 3754.1 SF

EXISTING BUILDING FOOTPRINT: 1,775.33 SF (AT SECOND LEVEL) EXISTING IMPERVIOUS SURFACE AREA: 857 SF (OUTSIDE OF BUILDING FOOTPRINT)
EXISTING RETAINING WALL SURFACE AREA: 270 SF

GRAND TOTAL IMPERVIOUS SURFACES: 2901 SF

ROOM SCHEDULE

NAME	NUMBER	AREA	PERIMETER	NOTES
BASEMENT	101	393 SF	125' - 10"	
STORAGE	102	160 SF	54' - 1"	
MECHANICAL	103	43 SF	29' - 10"	
BATHROOM	104	62 SF	39' - 9"	
CLOSET	105	14 SF	18' - 3"	
CLOSET	106	4 SF	8' - 7"	
L01 - Basement: 6		677 SF		
GREAT ROOM	201	485 SF	94' - 7"	
KITCHEN	202	147 SF	51' - 4"	
BATHROOM	203	47 SF	31' - 0"	
SUNROOM	204	291 SF	79' - 9"	
DINING AREA	205	106 SF	41' - 5"	
LANDING	206	26 SF	21' - 11"	
CLOSET	207	7 SF	10' - 8"	
BEDROOM B	208	Not Enclosed	Not Enclosed	
CLOSET	209	15 SF	17' - 2"	
BEDROOM C	210	126 SF	49' - 2"	
CLOSET	211	15 SF	22' - 5"	
MASTER BEDROOM	212	130 SF	49' - 11"	
MASTER BATHROOM	213	76 SF	37' - 0"	
CLOSET	214	8 SF	11' - 5"	
L02 - Main Floor: 14		1478 SF		
BALCONY / LOFT	301	163 SF	51' - 2"	
L03 - Upper Floor: 1		163 SF		
GRAND TOTAL: 21		2319 SF		

Robert & Sally Griffin 2712 N Magnolia Ave, Chicago, IL 60614

architectural designer:
Patrick Griffin 2712 N Magnolia Ave, Chicago, IL 60614

structural engineer:


civil engineer:

consultant:

project name:

Griffin Residence 7655 Lilly Lake Rd. Burlington, WI 53105

project number: PG-2023-001

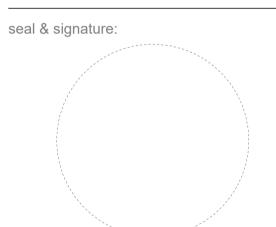

Not For Construction

Rennovation Drawings V5

sheet number: 7 of 35

sheet revisions:

No. Date

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Description

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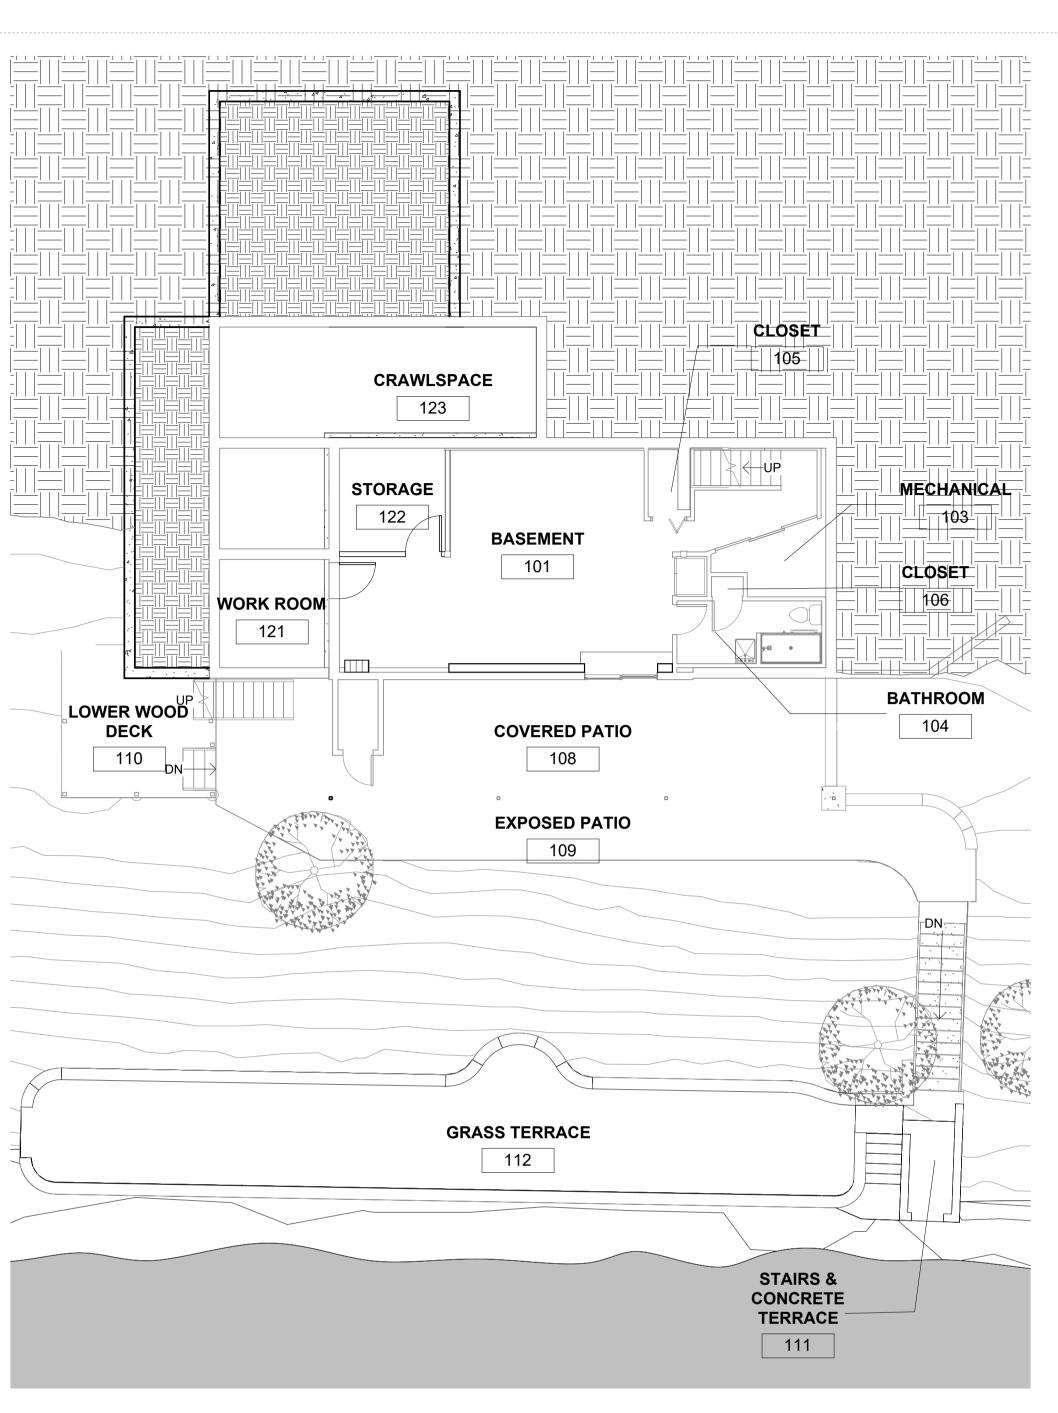
key plan:

Existing Area Calculations


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Do not scale. Check all dimensions on site.

A-002.01



Proposed - L01 - Basement Room Plan 1/8" = 1'-0"

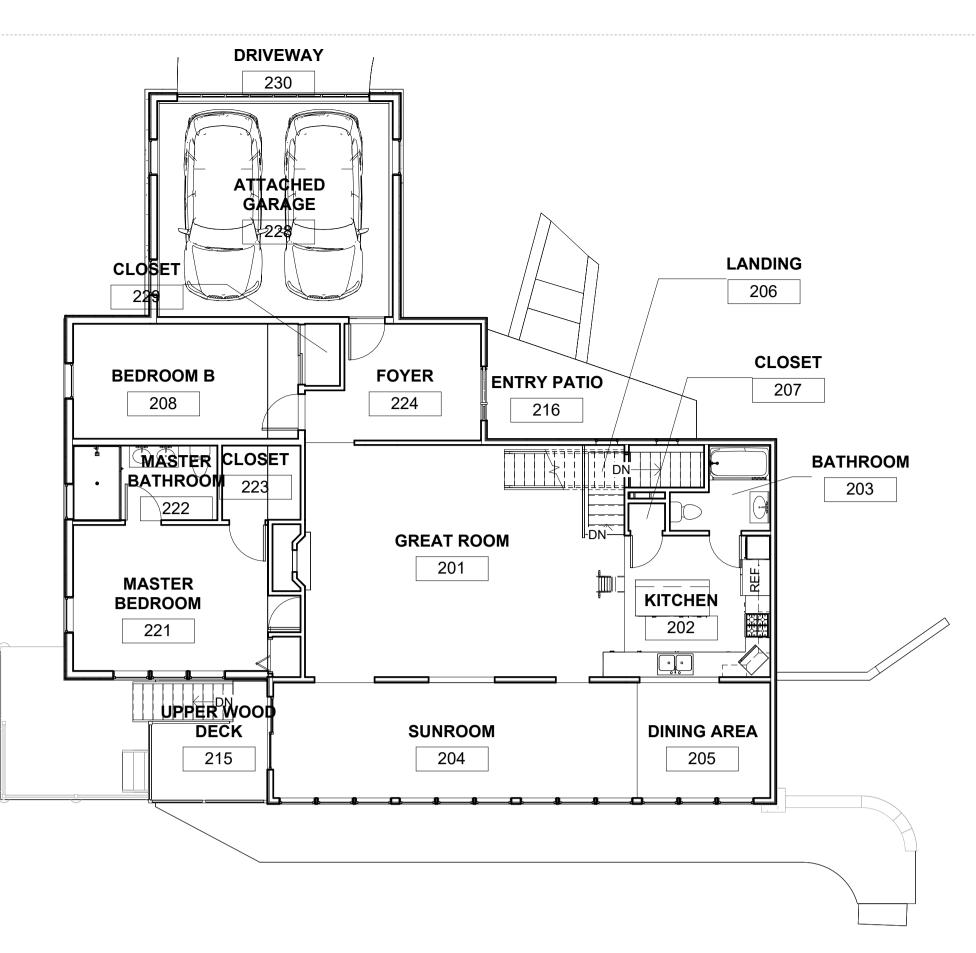

2 Proposed - L02 - Main Floor Room Plan 1/8" = 1'-0"

BALCONY/LOFT BEDROOM E 301 CLOSET E 304 BEDROOM F CLOSET F 303 303

3 Proposed - L03 - Balcony Room Plan 1/8" = 1'-0"

EXTERIOR AREA SCHEDULE (RENOVATED)

		'	L	,
NAME	NUMBER	AREA	PERIMETER	NOTES
COVERED PATIO	108	386 SF	105' - 6"	(BELOW OR ABOVE OTHER)
UPPER WOOD DECK	215	74 SF	39' - 8"	(BELOW OR ABOVE OTHER)
(BELOW OR ABOVE OTHER): 2		459 SF		
EXPOSED PATIO	109	393 SF	162' - 9"	IMPERVIOUS SURFACE
LOWER WOOD DECK	110	124 SF	45' - 0"	IMPERVIOUS SURFACE
STAIRS & CONCRETE TERRACE	111	157 SF	73' - 11"	IMPERVIOUS SURFACE
ENTRY PATIO	216	148 SF	66' - 5"	IMPERVIOUS SURFACE
IMPERVIOUS SURFACE: 4		822 SF		
GRASS TERRACE	112	747 SF	158' - 0"	PURVEOUS SURFACE
DRIVEWAY	230	314 SF	70' - 8"	PURVEOUS SURFACE
PURVEOUS SURFACE: 2		1061 SF		
GRAND TOTAL: 8		2343 SF		

LOT SURFACE COVERAGE

'HOMESITE' LOT AREA: 9,385.47 SF (TRAINGLE ONLY)
BUILDABLE 'ENVELOPE' AREA: 7,524.97 SF

MAX. UMITIGATED IMPERVIOUS SURFACE AREA: (9,385.47x0.30) = 2,815.5 SF MAX. MITIGATED IMPERVIOUS SURFACE AREA: (9,384.47x0.40) = 3754.1 SF

RENOVATED BUILDING FOOTPRINT: 2371.25 SF (AT SECOND LEVEL)
RENOVATED IMPERVIOUS SURFACE AREA: 849 SF (OUTSIDE OF BUILDING FOOTPRINT)
EXISTING RETAINING WALL SURFACE AREA: 270 SF

GRAND TOTAL IMPERVIOUS SURFACES: 3485 SF

WATER MITIGATION REQUIREMENT: 670

ROOM SCHEDULE (RENOVATED)

BASEMENT	101	476 SF	144' - 9"	
MECHANICAL	103	43 SF	29' - 10"	
BATHROOM	104	62 SF	39' - 9"	
CLOSET	105	14 SF	18' - 3"	
CLOSET	106	4 SF	8' - 7"	
WORK ROOM	121	83 SF	36' - 10"	NEW
STORAGE	122	76 SF	34' - 10"	NEW
L01 - Basement: 7		759 SF		
GREAT ROOM	201	486 SF	95' - 0"	
KITCHEN	202	147 SF	51' - 4"	
BATHROOM	203	47 SF	31' - 0"	
SUNROOM	204	291 SF	79' - 9"	
DINING AREA	205	106 SF	41' - 5"	
LANDING	206	26 SF	21' - 11"	
CLOSET	207	7 SF	10' - 8"	
BEDROOM B	208	179 SF	56' - 7"	
UPPER WOOD DECK	215	74 SF	39' - 8"	(BELOW OR ABOVE OTHER)
MASTER BEDROOM	221	205 SF	63' - 2"	NEW
MASTER BATHROOM	222	74 SF	36' - 5"	NEW
CLOSET	223	40 SF	25' - 5"	RENOVATION
FOYER	224	125 SF	49' - 1"	RENOVATION
ATTACHED GARAGE	228	352 SF	75' - 1"	NEW
CLOSET	229	15 SF	16' - 2"	NEW
L02 - Main Floor: 15		2174 SF		
BALCONY / LOFT	301	43 SF	30' - 3"	
BEDROOM E	302	74 SF	34' - 6"	NEW
BEDROOM F	303	73 SF	34' - 5"	NEW
CLOSET E	304	13 SF	19' - 2"	NEW
CLOSET F	305	13 SF	18' - 5"	NEW
L03 - Upper Floor: 5		216 SF		
GRAND TOTAL: 27		3149 SF		

AREA PERIMETER

NOTES

client:
Robert & Sally Griffin
2712 N Magnolia Ave,
Chicago, IL 60614


architectural designer:
Patrick Griffin
2712 N Magnolia Ave,
Chicago, IL 60614

structural engineer:

project name: **Griffin Residence**7655 Lilly Lake Rd.
Burlington, WI 53105

project number: **PG-2023-001**

consultant:

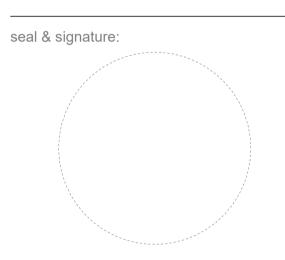

Not For Construction

issuance:

Rennovation Drawings V5

sheet number: 8 of 35

sheet revisions:

No. Date

Description

sheet title

key plan:


Rennovated Area Calculations

drawn by: Patrick G
scale: 1/8" = 1'-0"
size: 24 in × 36 in
date: 12/19/2023 12:52:09 PM

Do not scale. Check all dimensions on site.

sheet number:

A-002.02

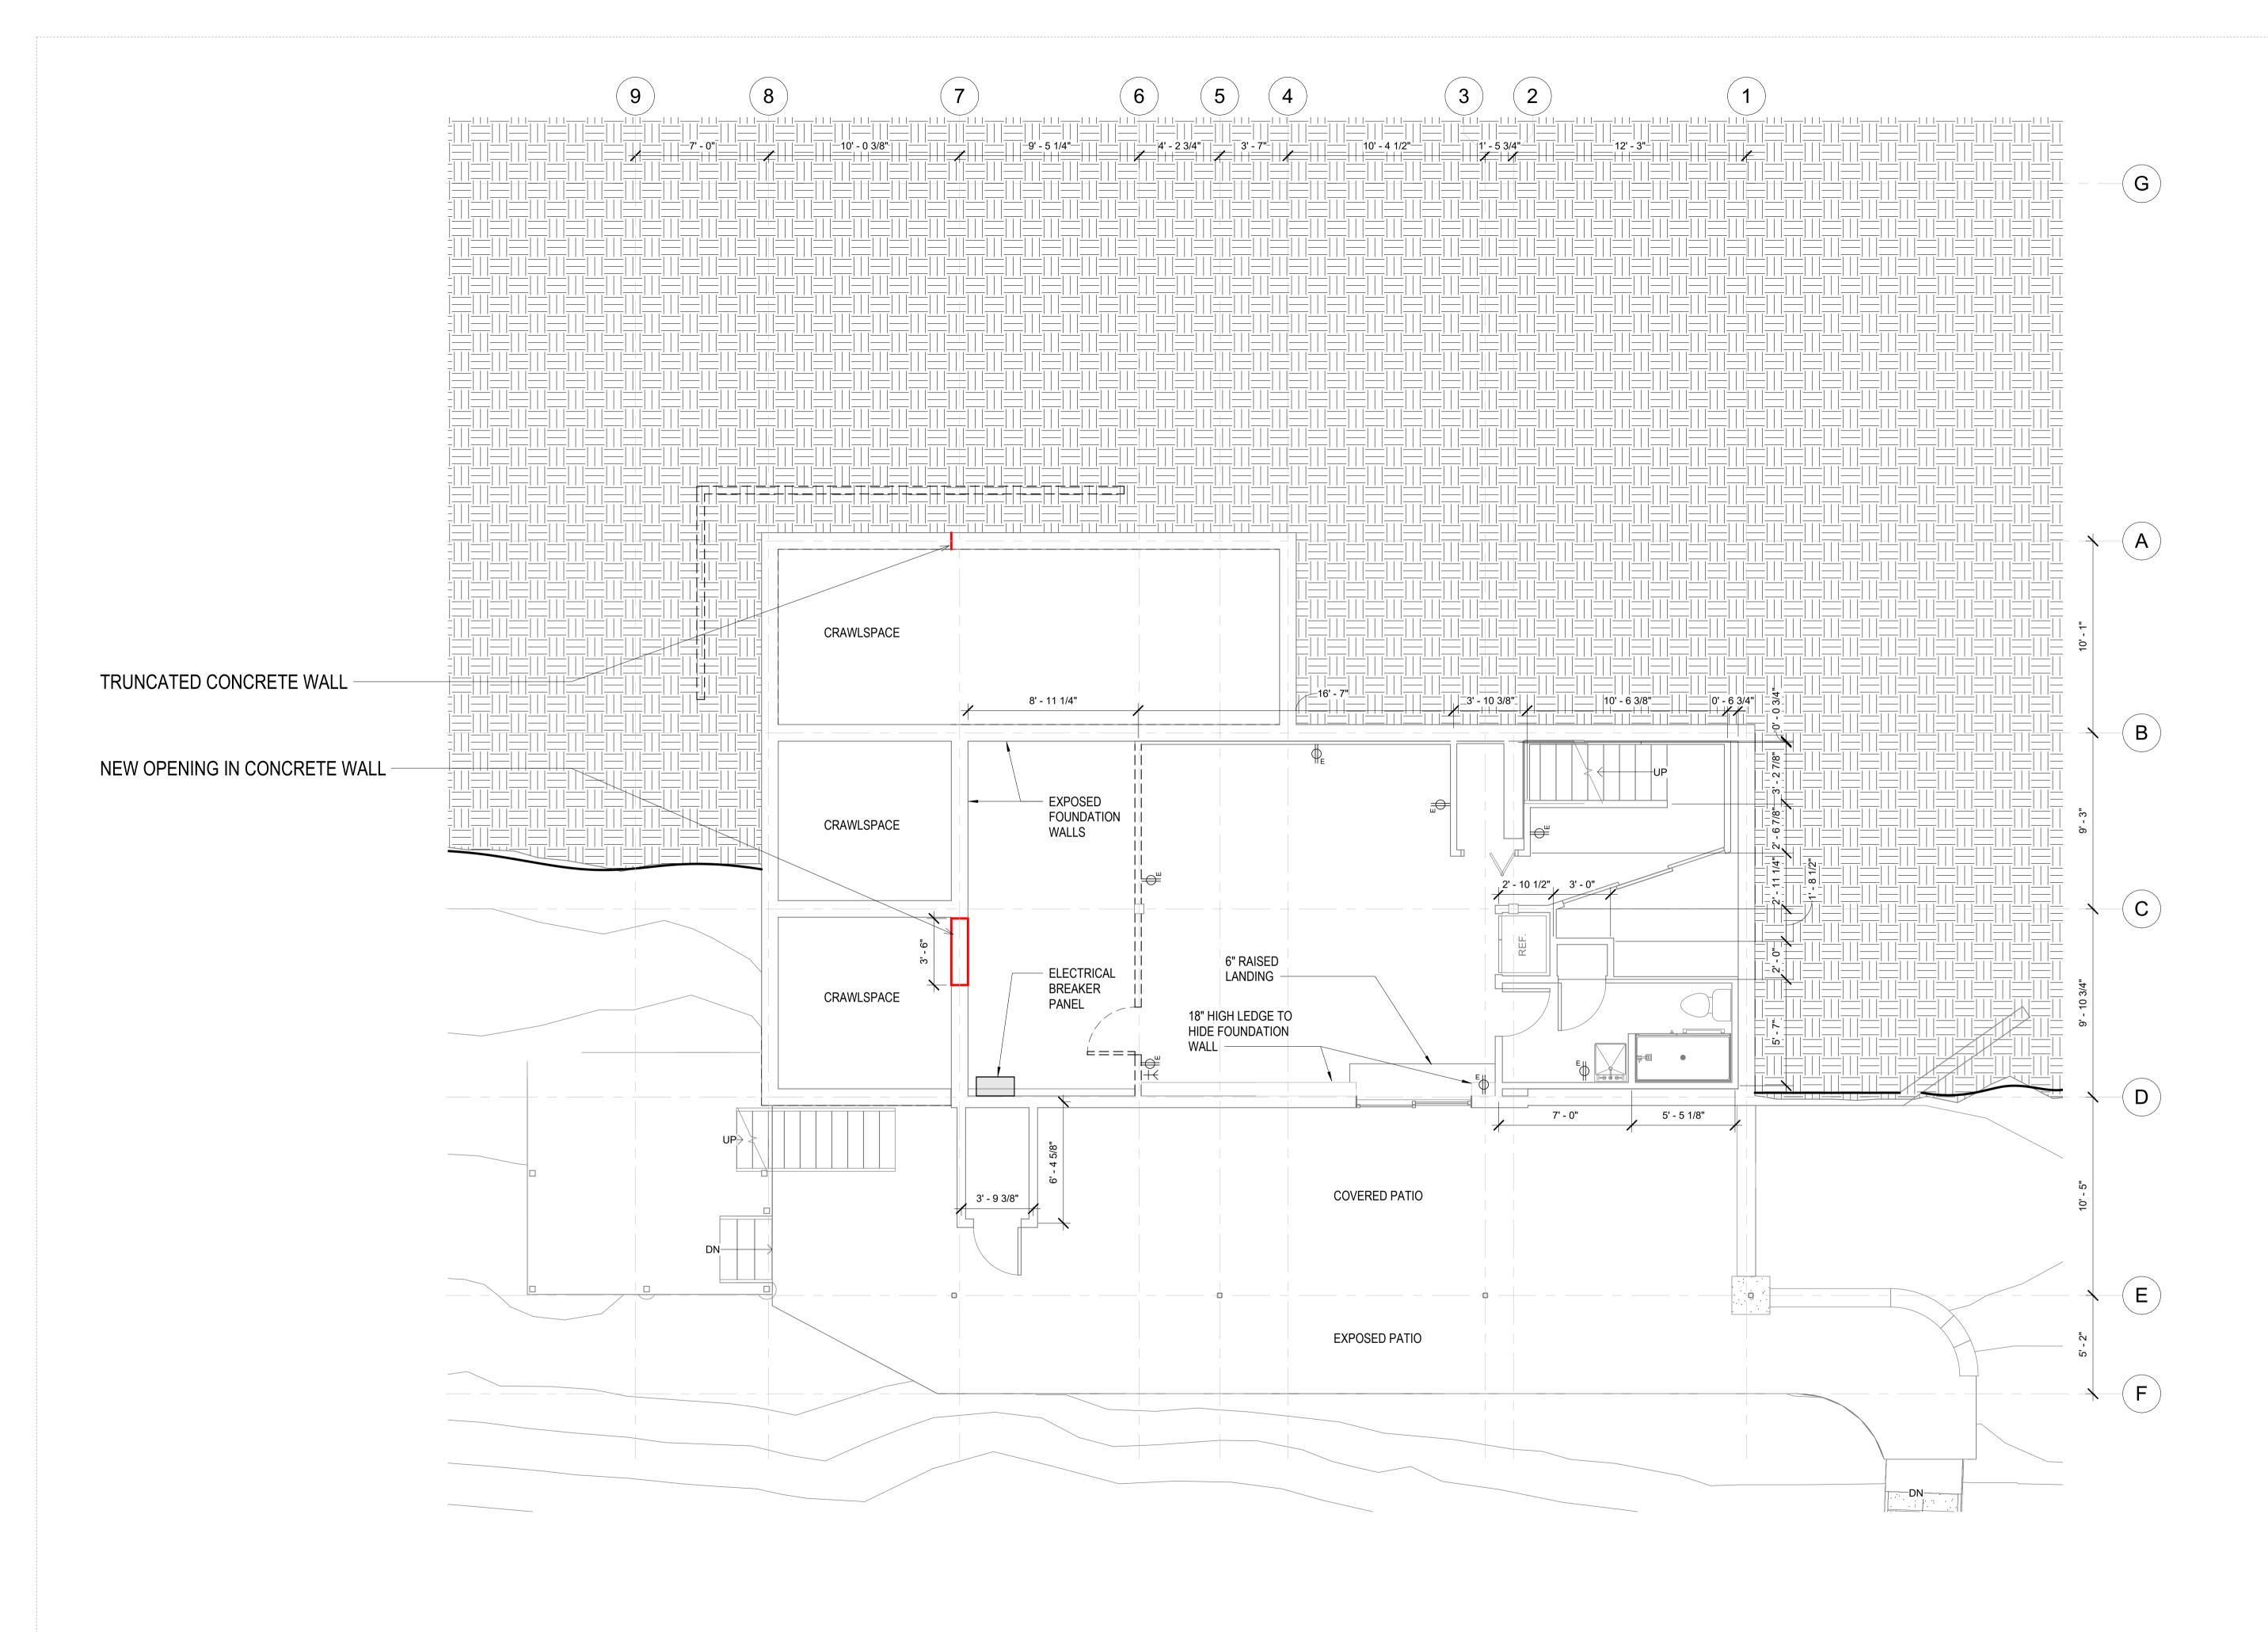

1 Exisiting - L01 - Basement 1/4" = 1'-0"

client:

Robert & Sally Griffin
2712 N Magnolia Ave,
Chicago, IL 60614


architectural designer:
Patrick Griffin
2712 N Magnolia Ave,
Chicago, IL 60614

civil engineer:

consultant:

project name: **Griffin Residence**7655 Lilly Lake Rd.
Burlington, WI 53105

project number: **PG-2023-001**

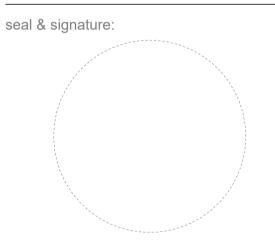

Not For Construction

issuance:

Rennovation Drawings V5

9 of 35

sheet number:

sheet revisions:

No. Date Description

key plan:


sheet tit

Level 1 Demolition Floor Plan

drawn by: Patrick G
scale: 1/4" = 1'-0"
size: 24 in × 36 in
date: 12/19/2023 12:52:11 PM

Do not scale. Check all dimensions on site.

sheet number: **A-101.00**

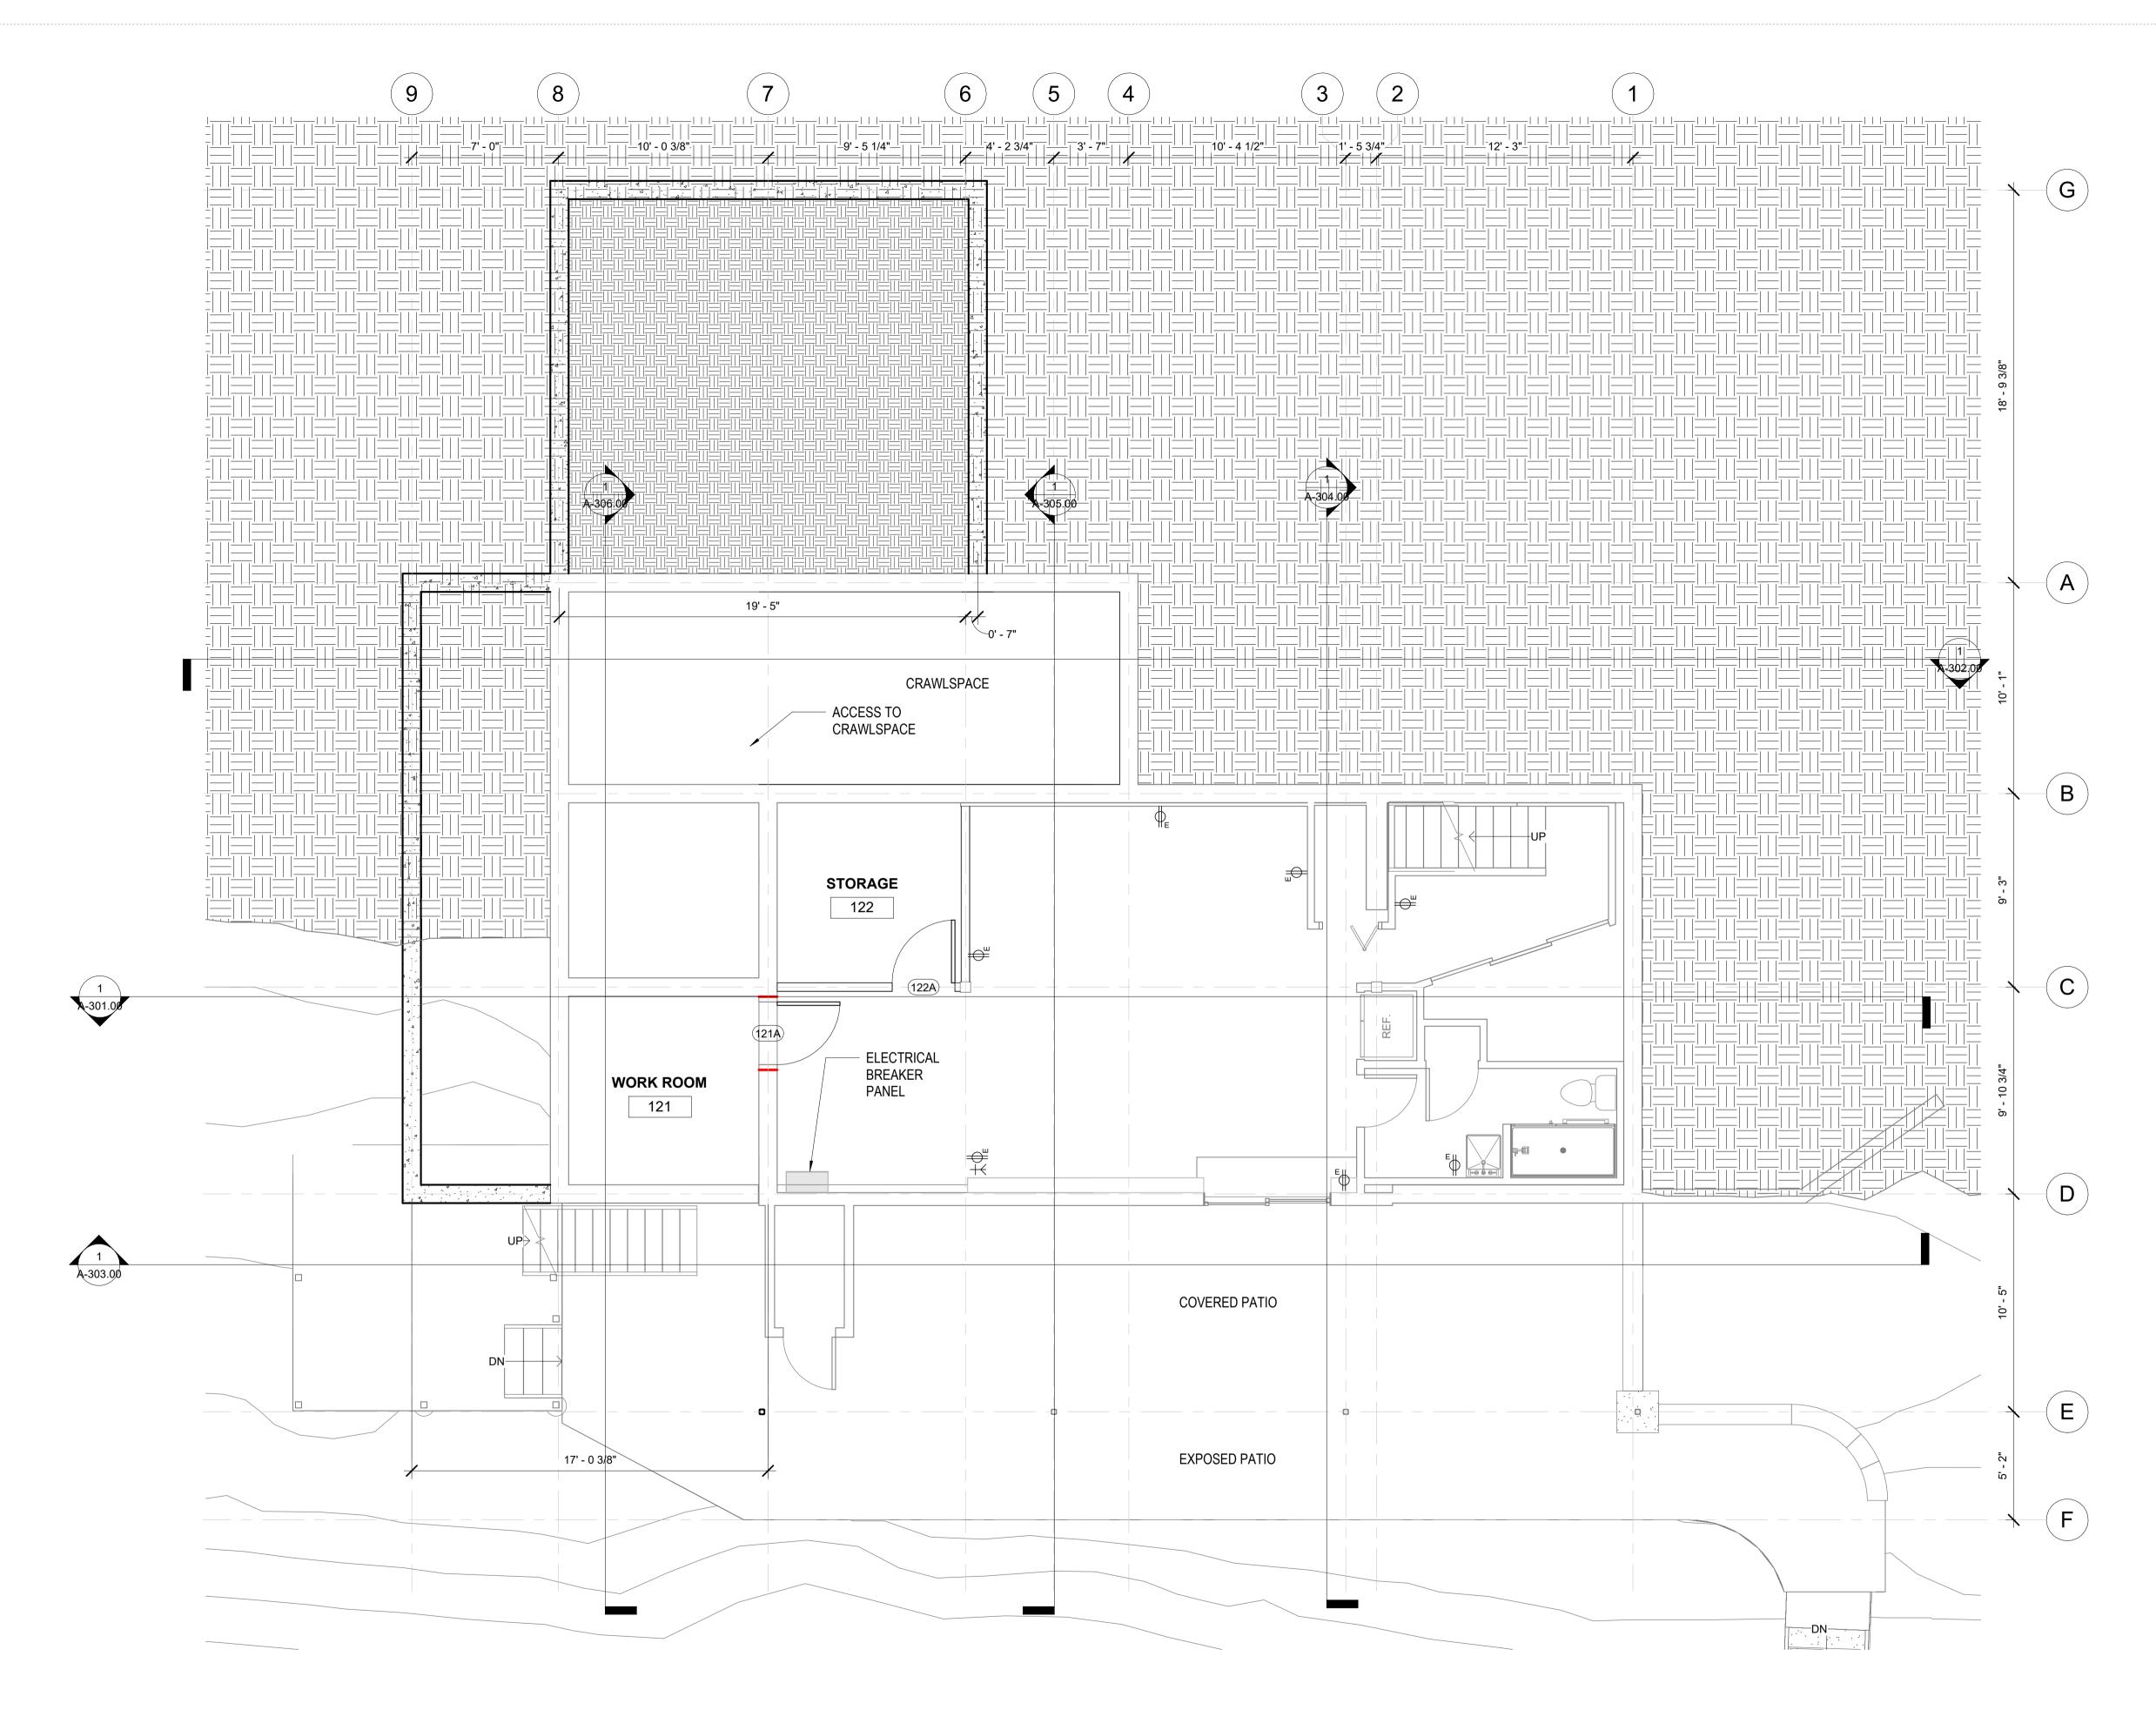

1) Proposed - L01 - Basement 1/4" = 1'-0"


Robert & Sally Griffin 2712 N Magnolia Ave, Chicago, IL 60614 architectural designer:
Patrick Griffin 2712 N Magnolia Ave, Chicago, IL 60614 structural engineer: civil engineer: consultant: project name: Griffin Residence 7655 Lilly Lake Rd. Burlington, WI 53105 project number: PG-2023-001 seal & signature: **Not For Construction** Rennovation Drawings V5 sheet number: 10 of 35 sheet revisions: No. Date Description

key plan:

Level 1 Renovated Floor Plan

drawn by: Patrick G
scale: 1/4" = 1'-0"
size: 24 in × 36 in
date: 12/19/2023 12:52:13 PM
Do not scale. Check all dimensions on site.

A-101.01

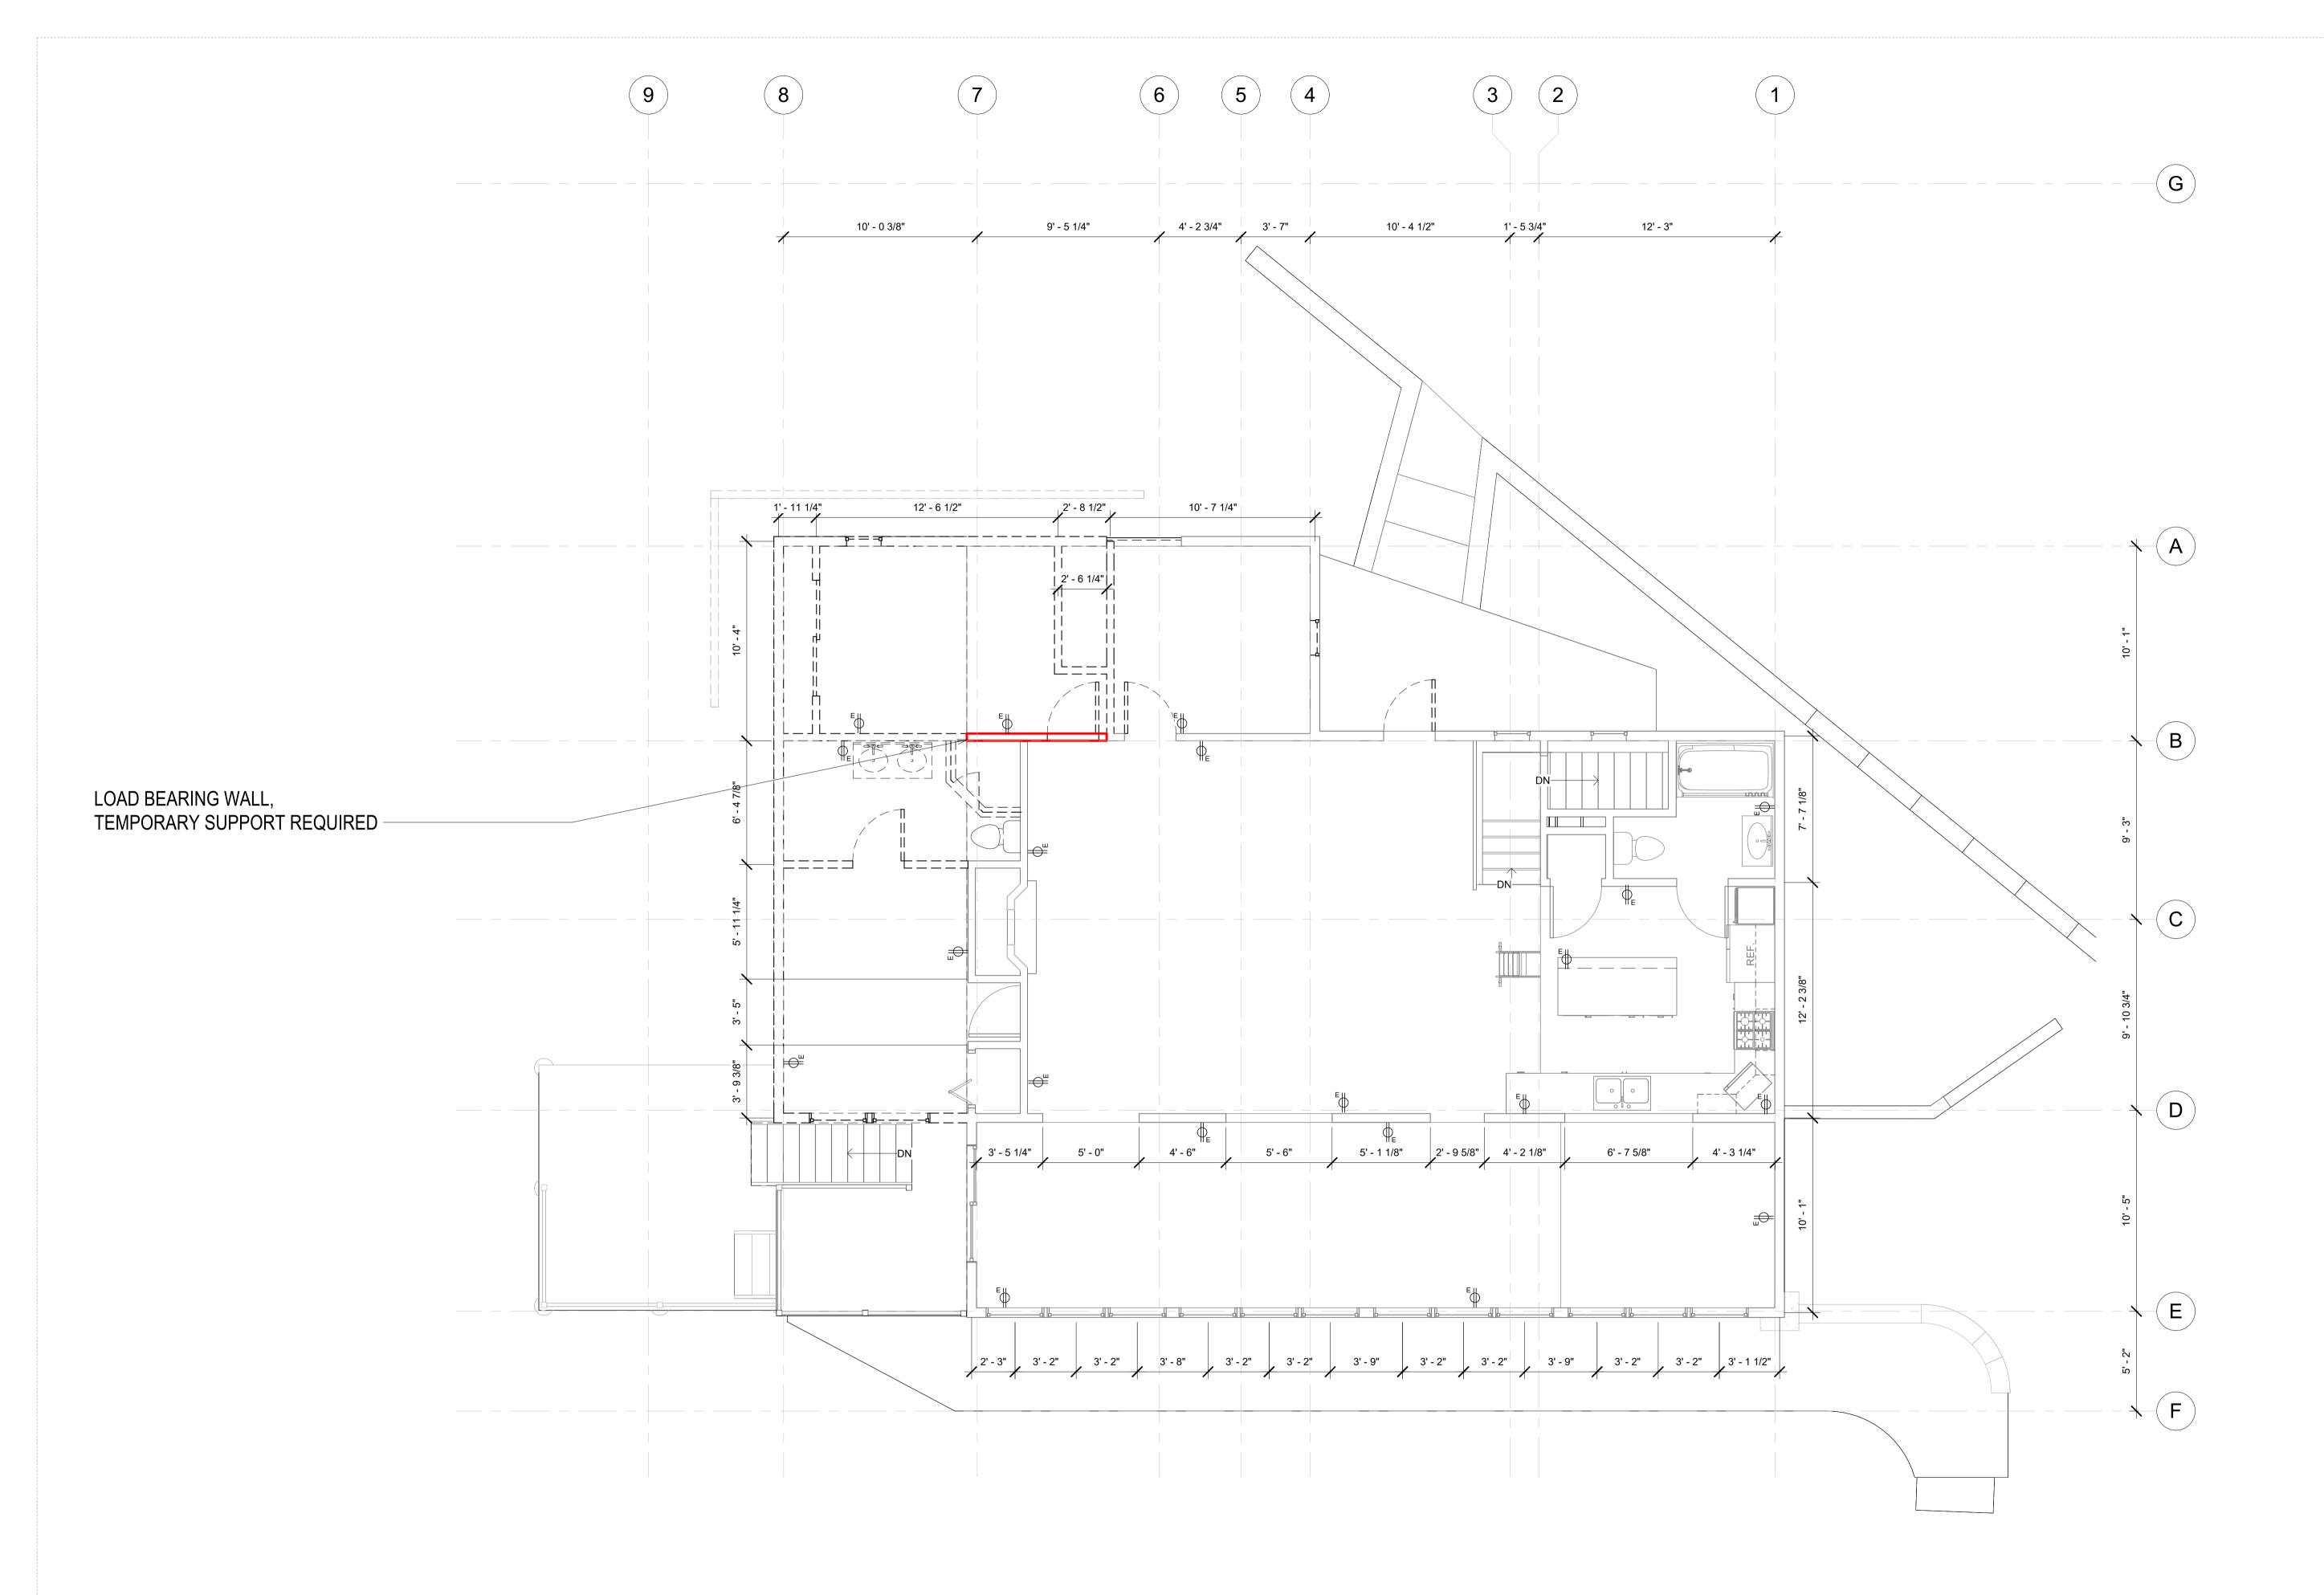

1 Existing - L02 - Main Floor 1/4" = 1'-0"

Robert & Sally Griffin 2712 N Magnolia Ave, Chicago, IL 60614

architectural designer:
Patrick Griffin 2712 N Magnolia Ave, Chicago, IL 60614

structural engineer:

civil engineer:

consultant:

project name: **Griffin Residence**

7655 Lilly Lake Rd. Burlington, WI 53105 project number:

PG-2023-001



Not For Construction

Rennovation Drawings V5

sheet number: 11 of 35

sheet revisions:

No. Date Description


key plan:

Level 2 Demolition Floor Plan

Patrick G 1/4" = 1'-0" 24 in × 36 in

12/19/2023 12:52:14 PM Do not scale. Check all dimensions on site.

A-102.00

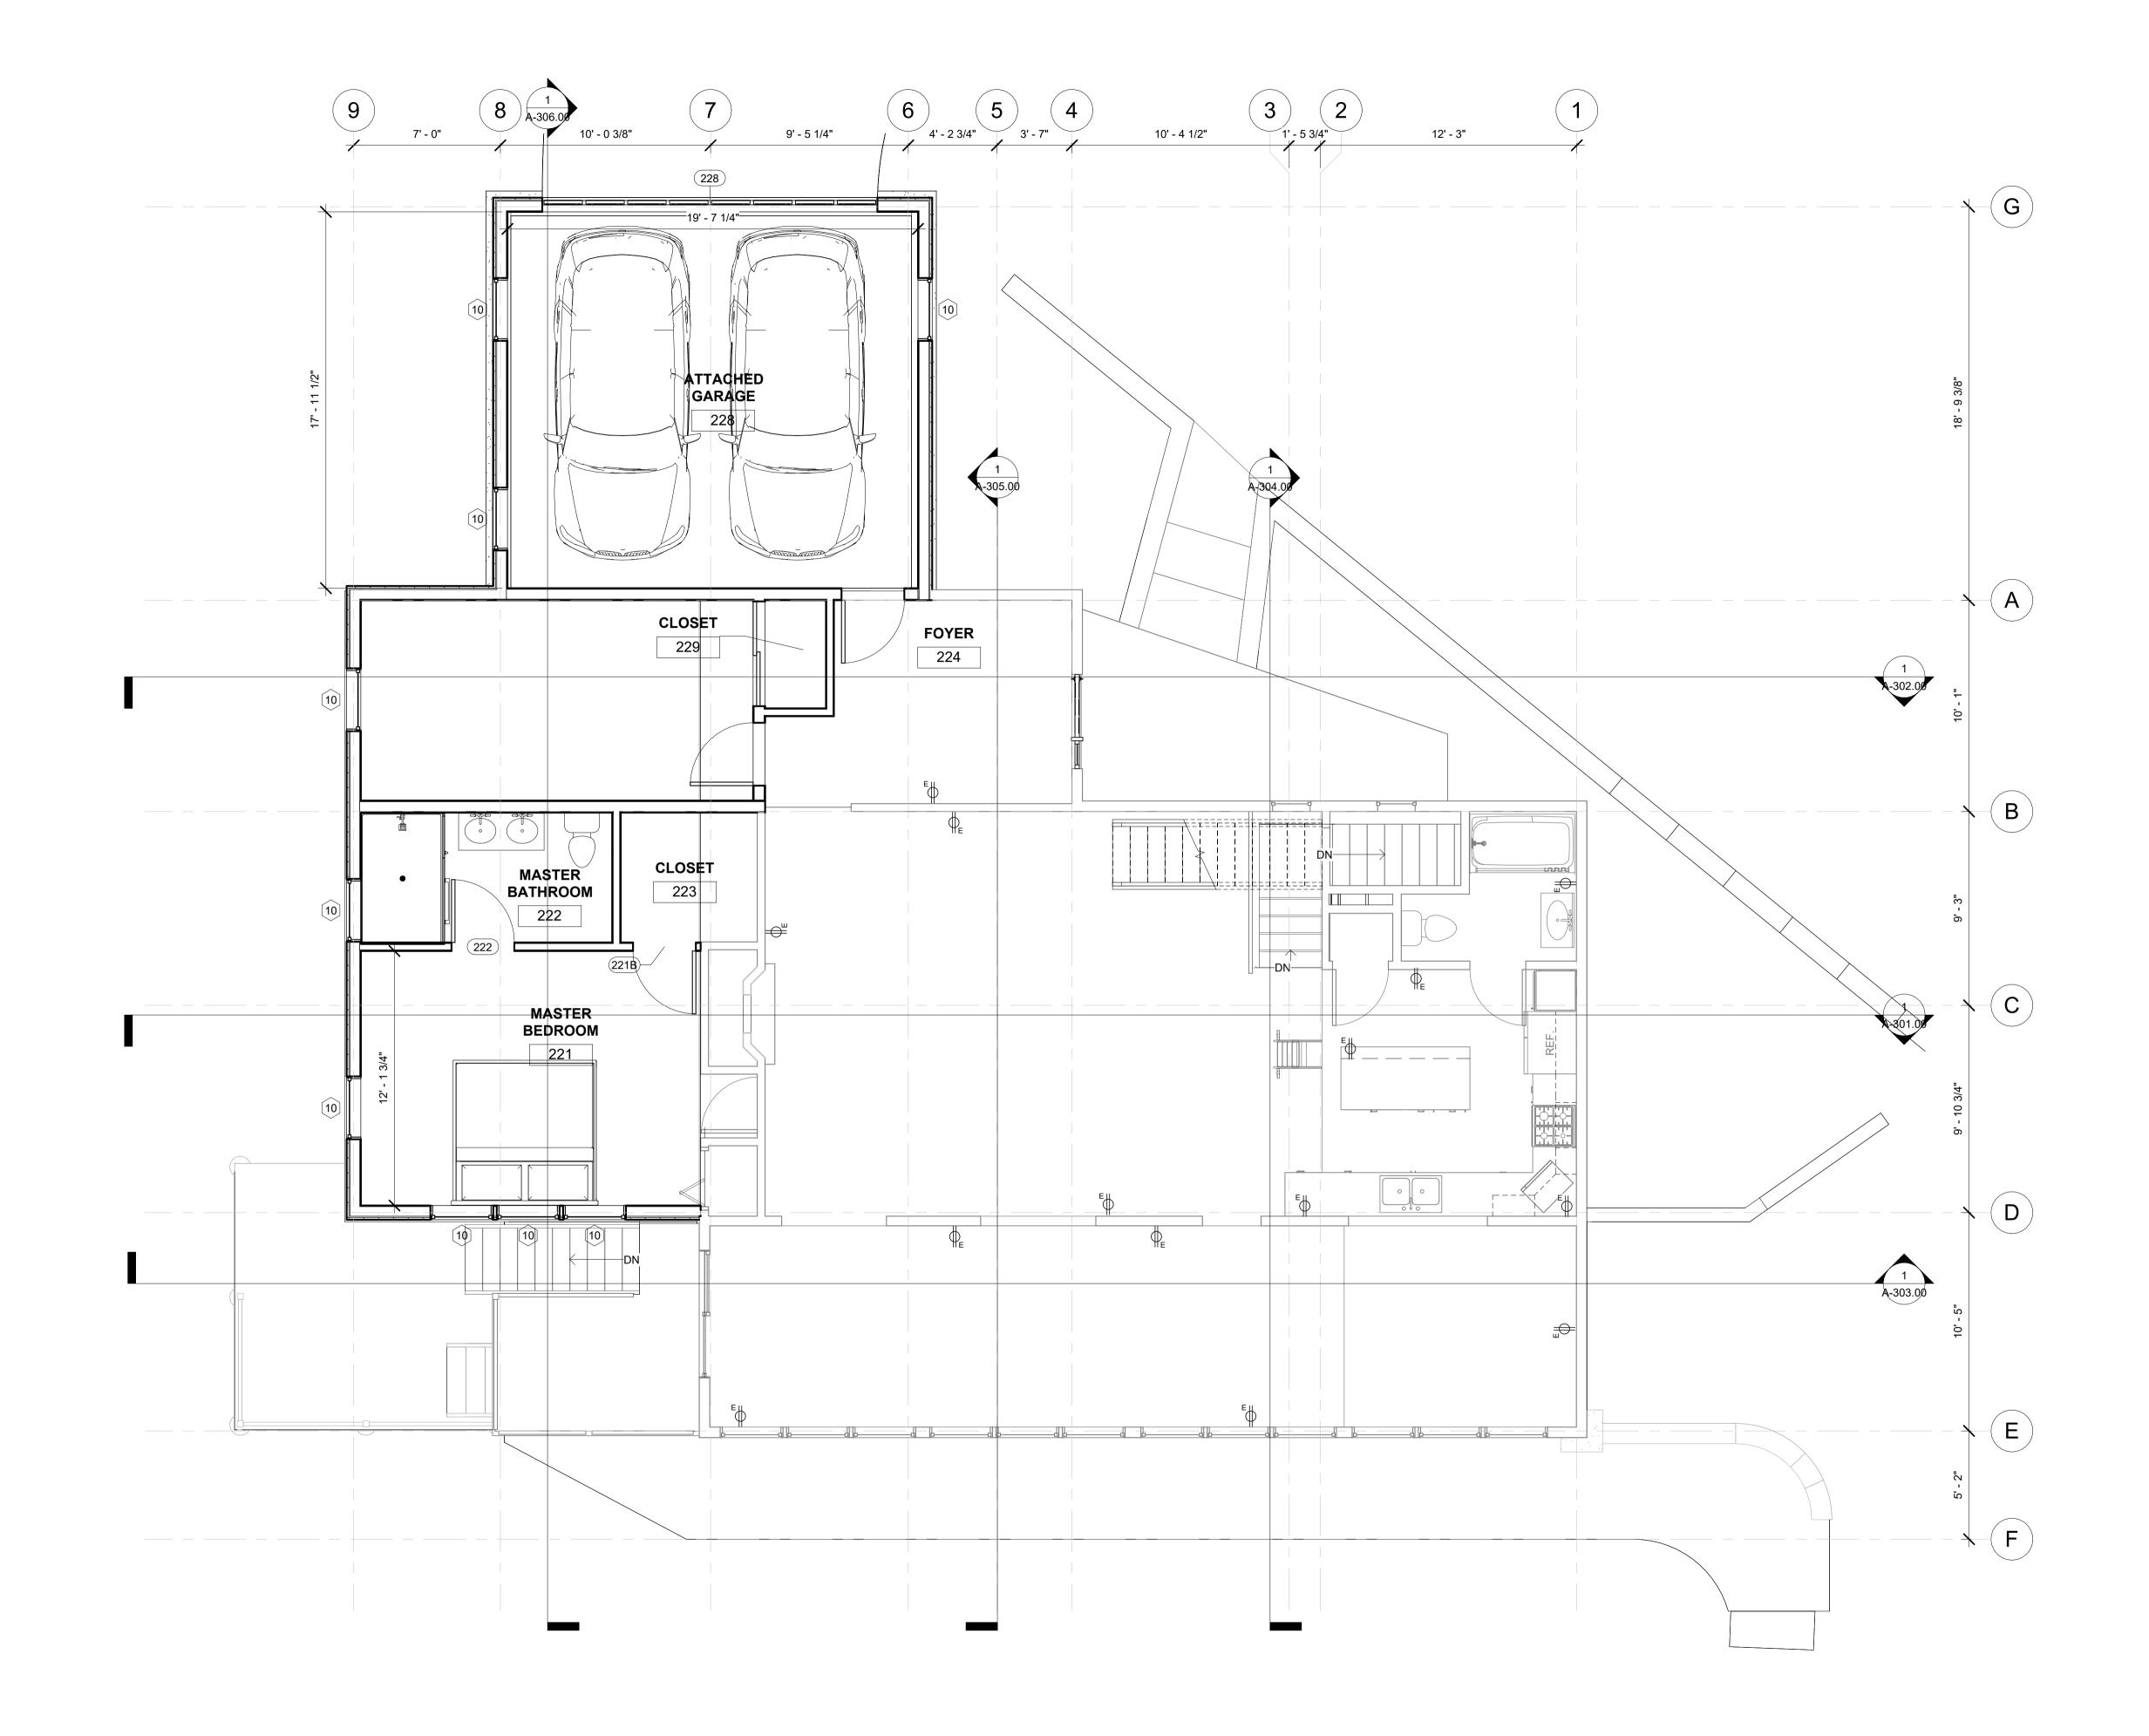

1/4" = 1'-0"

client: **Robert & Sally Griffin**2712 N Magnolia Ave,

Chicago, IL 60614

architectural designer:
Patrick Griffin 2712 N Magnolia Ave, Chicago, IL 60614

structural engineer:

civil engineer:

consultant:

project name: **Griffin Residence** 7655 Lilly Lake Rd. Burlington, WI 53105

project number: PG-2023-001



status: Not For Construction

Rennovation Drawings V5

sheet number: 12 of 35

sheet revisions:

No. Date Description


key plan:

Level 2 Renovated Floor Plan

Patrick G 1/4" = 1'-0" 24 in × 36 in 12/19/2023 12:52:17 PM

Do not scale. Check all dimensions on site.

A-102.01

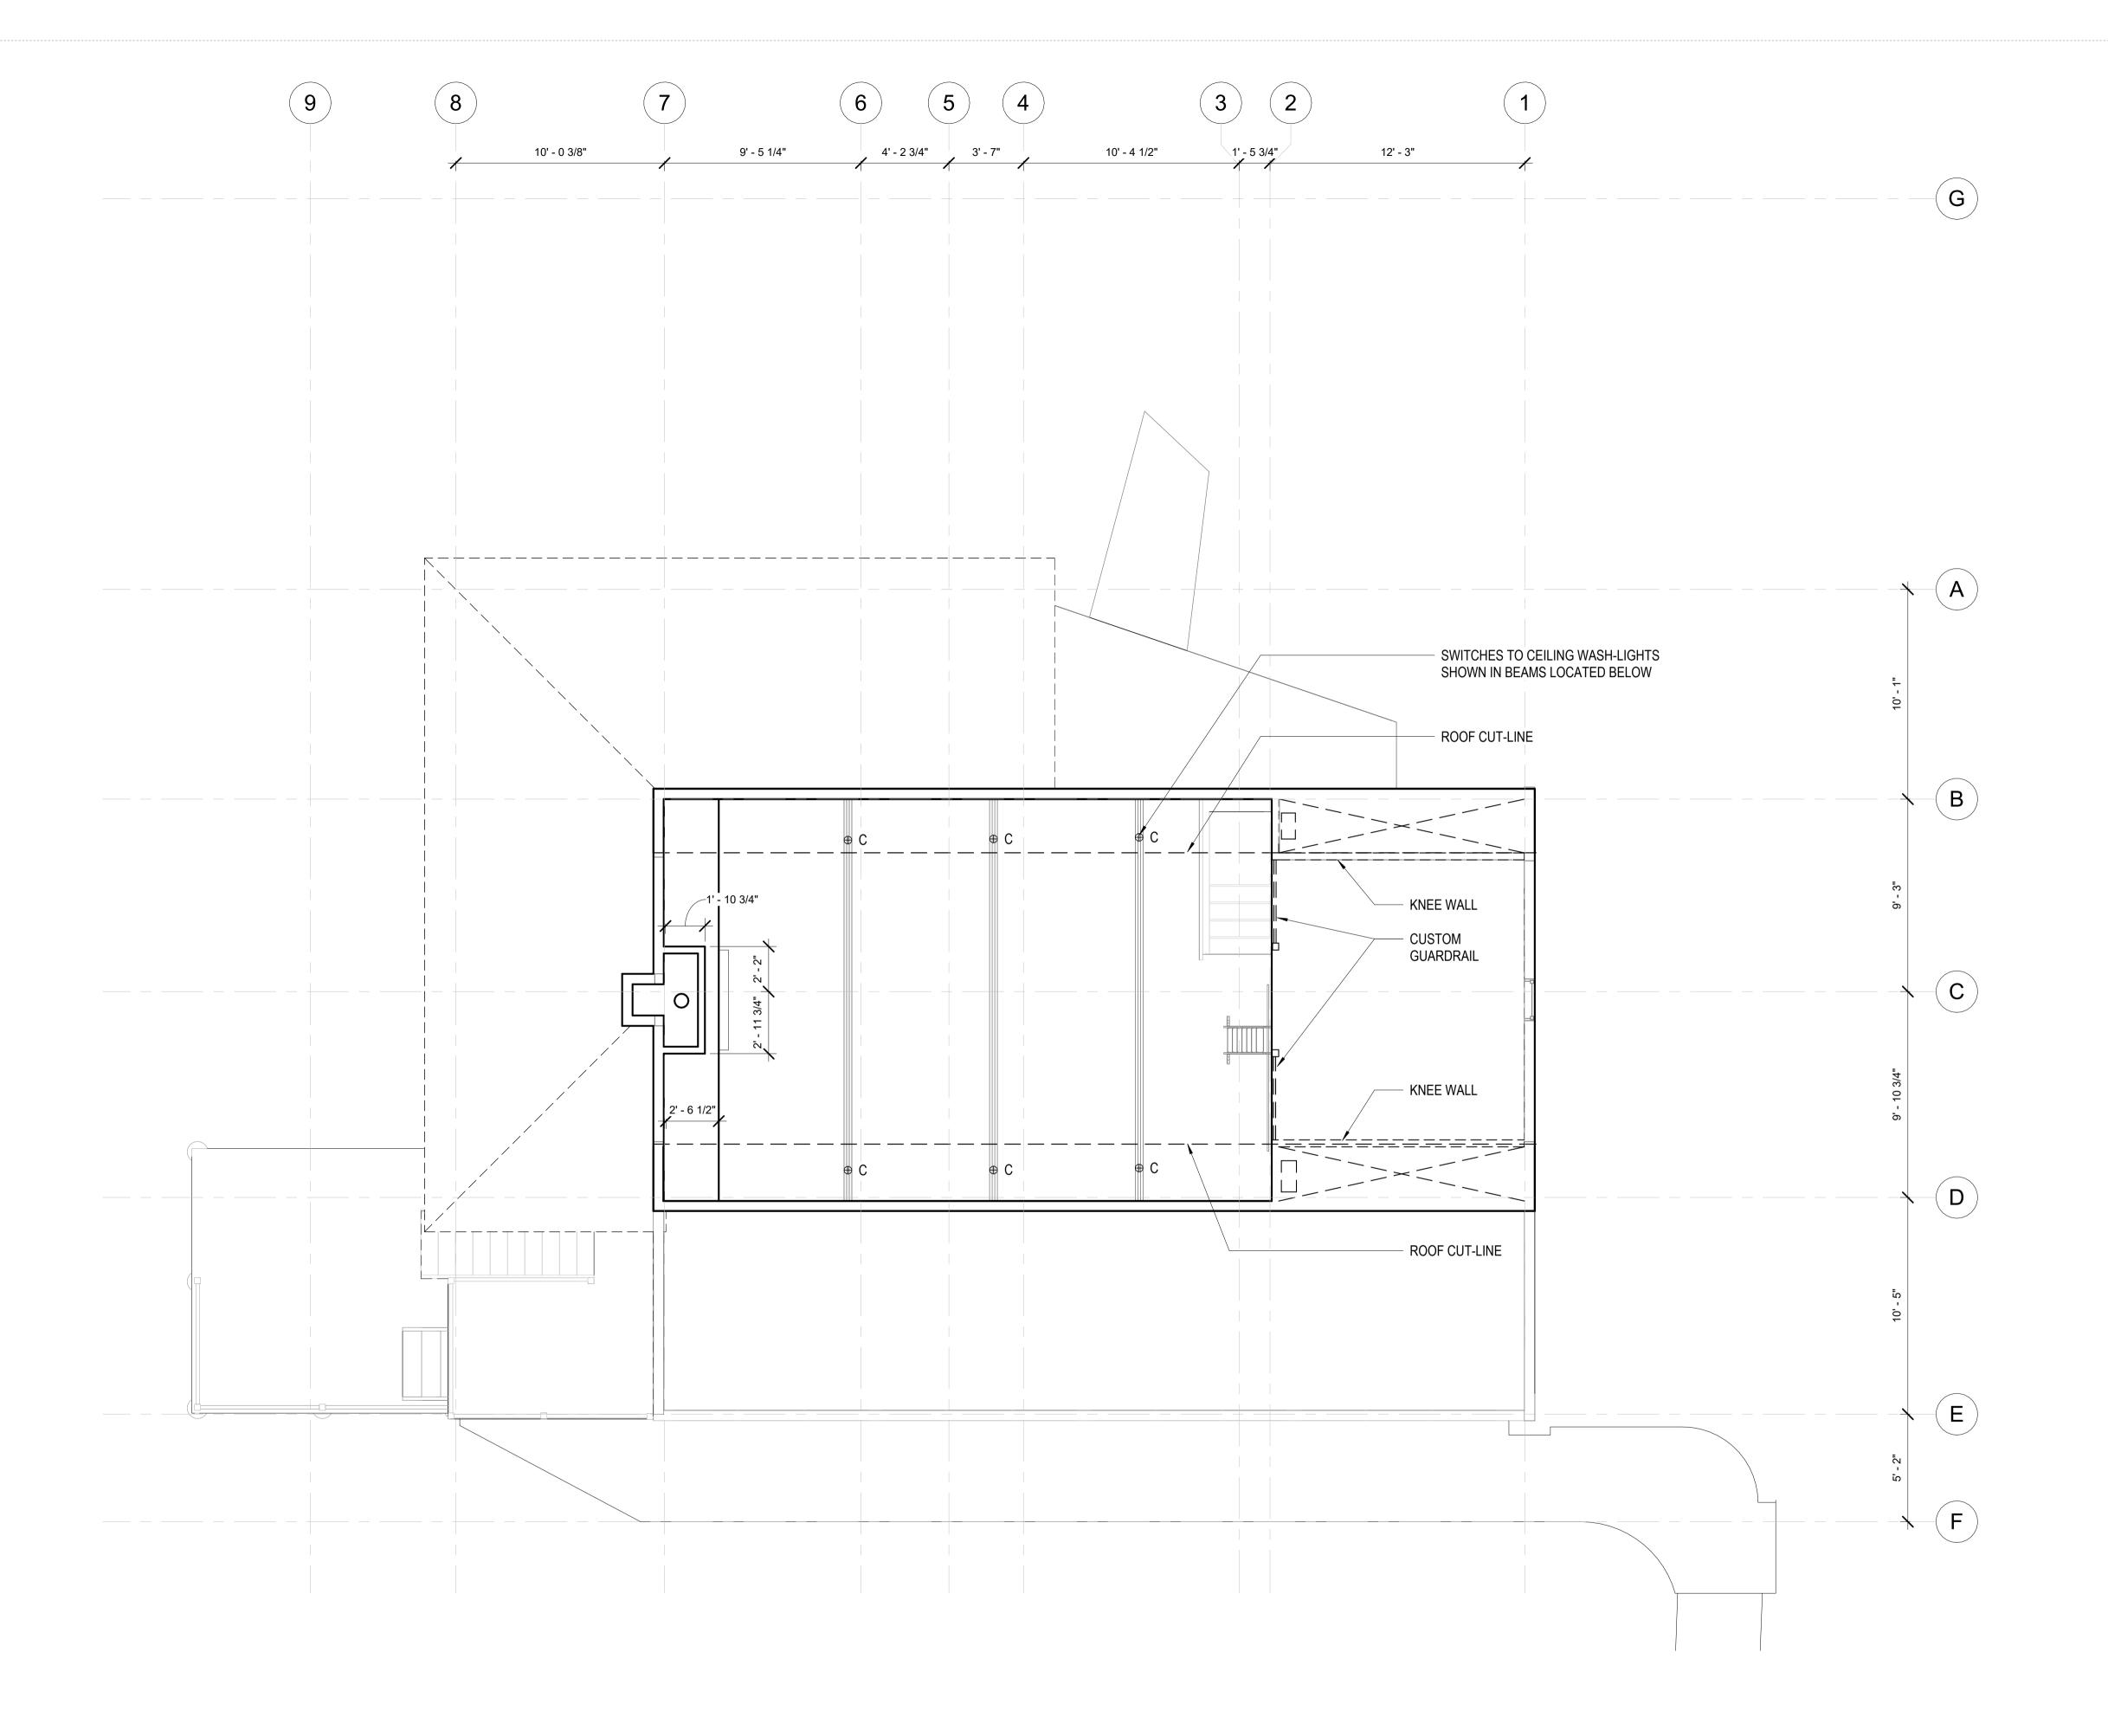

1 Existing - L03 - Upper Floor 1/4" = 1'-0"

lient:

Robert & Sally Griffin 2712 N Magnolia Ave, Chicago, IL 60614

architectural designer: **Patrick Griffin**2712 N Magnolia Ave,
Chicago, IL 60614

structural engineer:

civil engineer:


consultant:

project name: **Griffin Residence**7655 Lilly Lake Rd.

Burlington, WI 53105

project number: **PG-2023-001**

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sheet revisions:

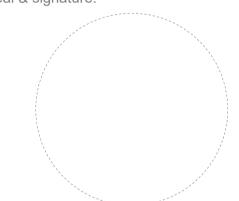No. Date Description

key plan:

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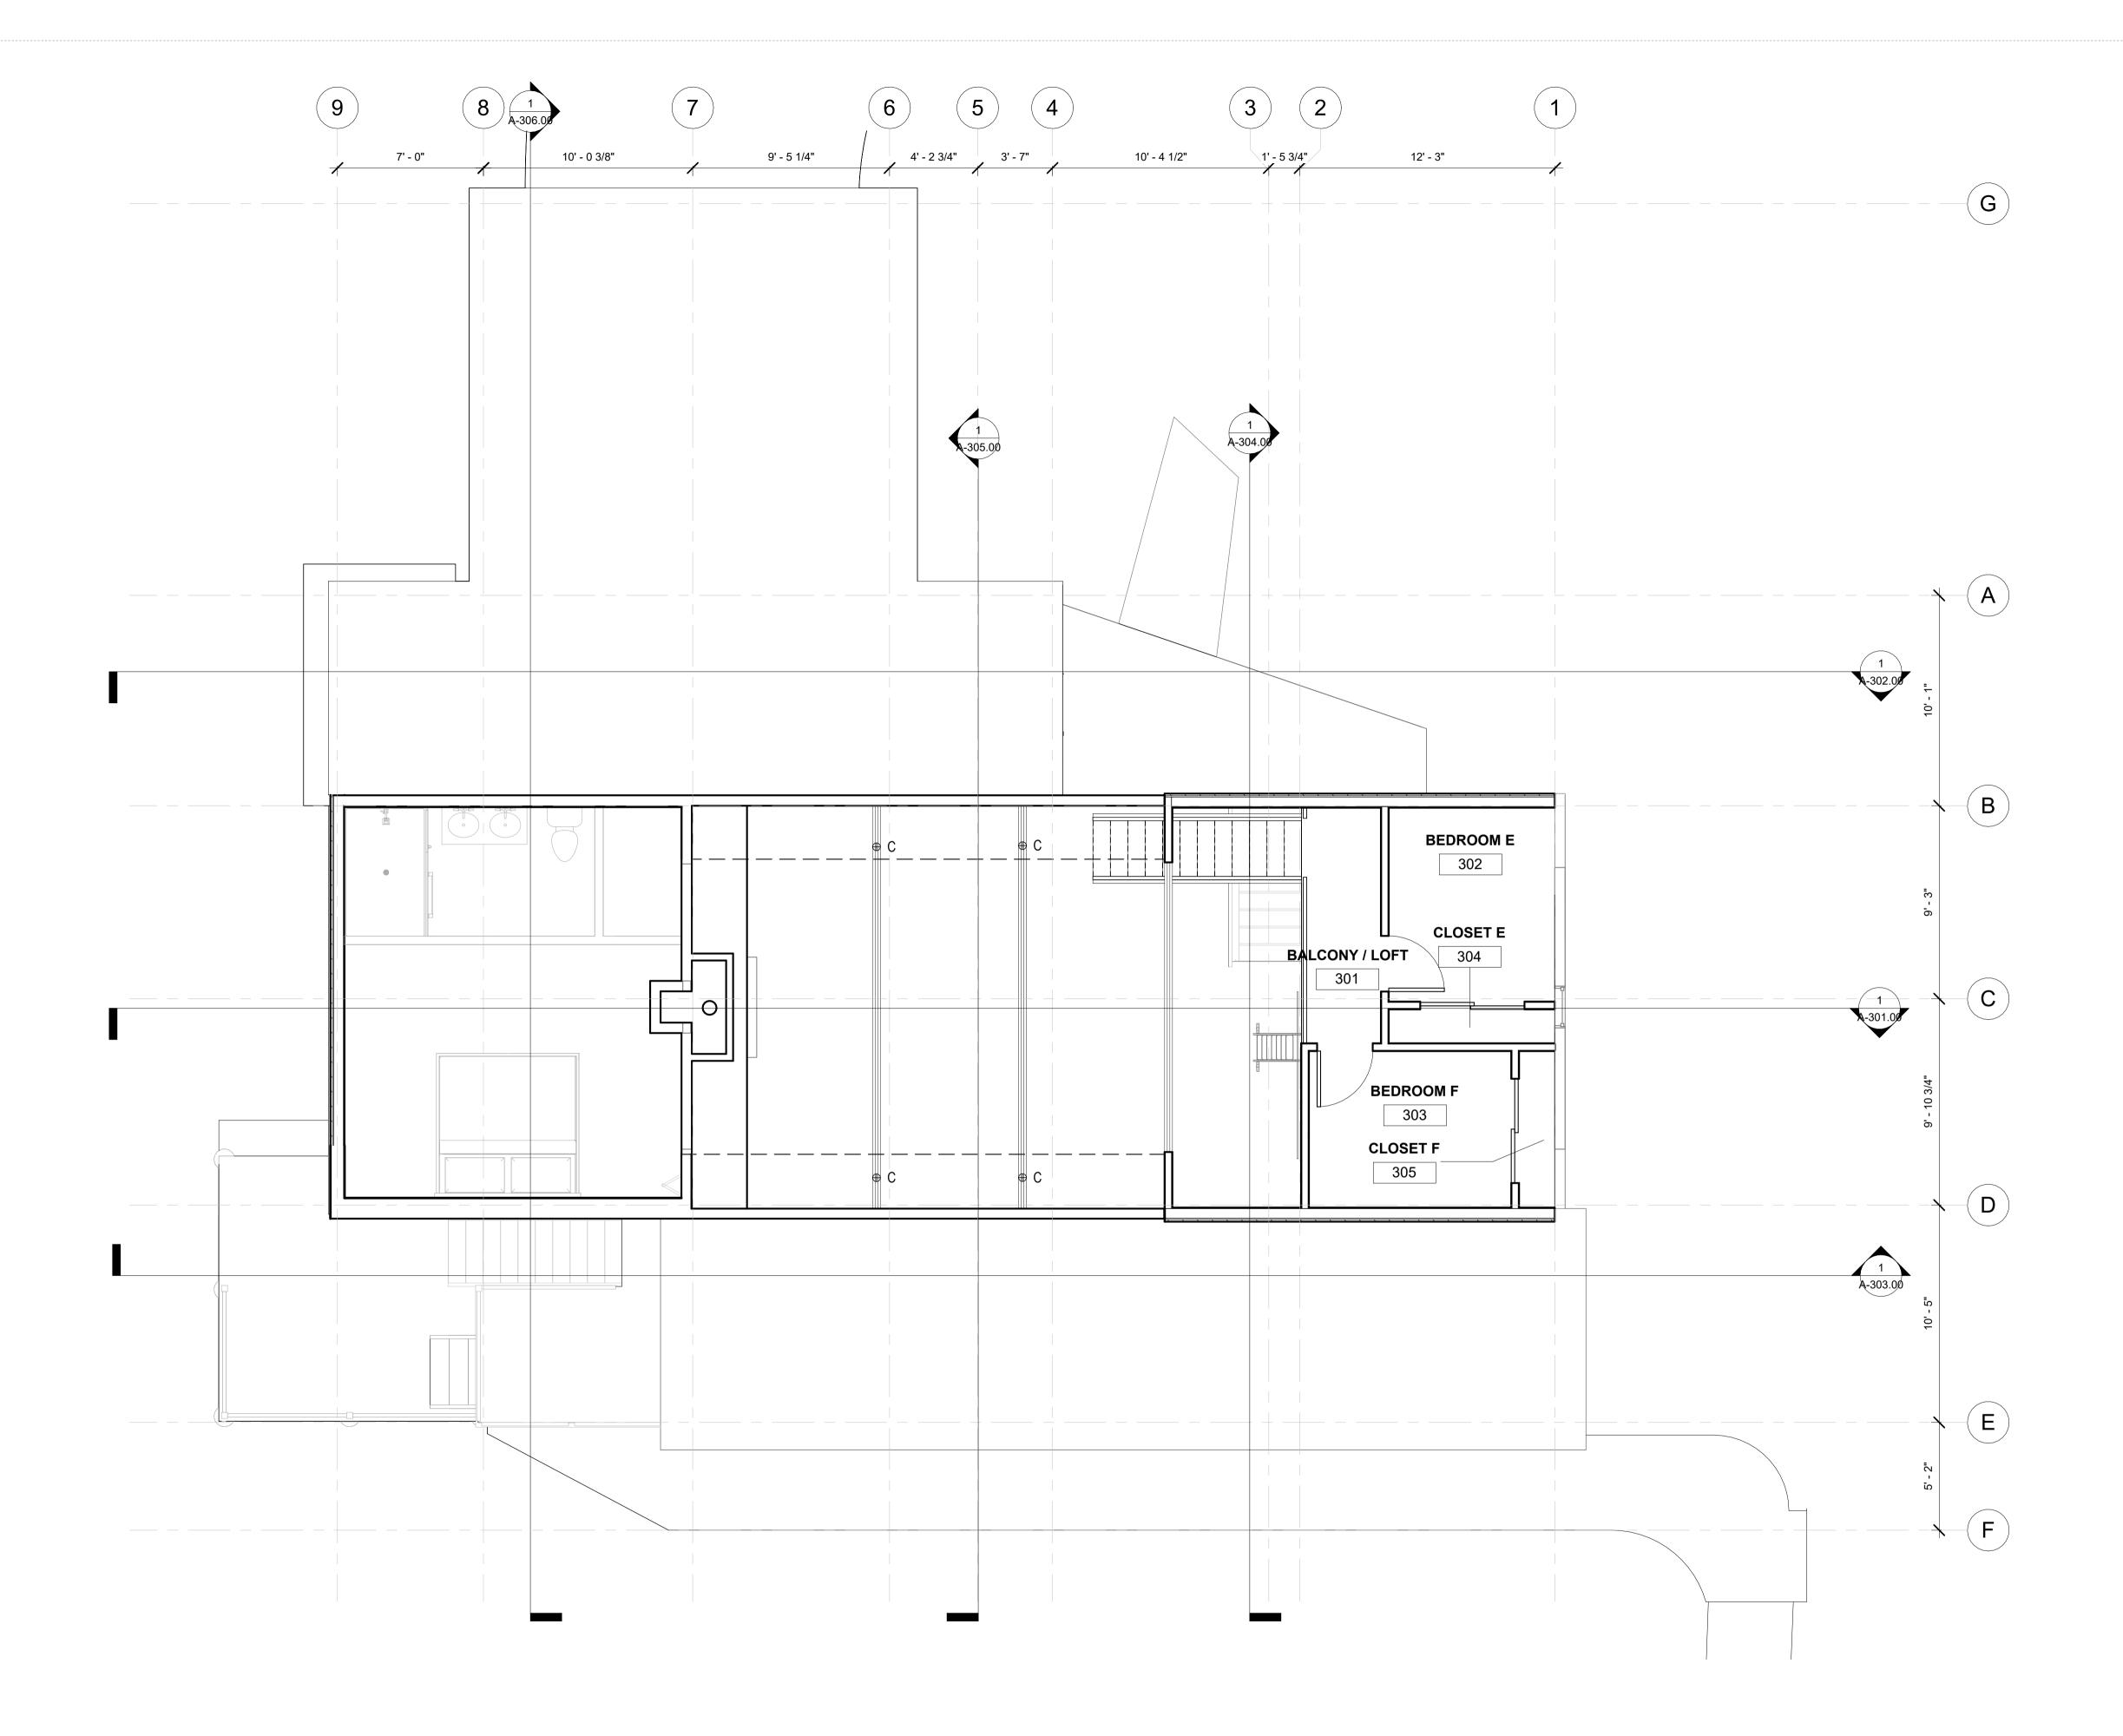
Level 3 Demolition Floor Plan

drawn by: Patrick G
scale: 1/4" = 1'-0"
size: 24 in × 36 in

date: 12/19/2023 12:52:18 PM

Do not scale. Check all dimensions on site.

A-103.00



Proposed - L03 - Upper Floor 1/4" = 1'-0"

client: **Robert & Sally Griffin**2712 N Magnolia Ave,

Chicago, IL 60614

architectural designer:
Patrick Griffin 2712 N Magnolia Ave, Chicago, IL 60614

structural engineer:

civil engineer:

consultant:

project name: **Griffin Residence**7655 Lilly Lake Rd.
Burlington, WI 53105

project number: PG-2023-001



status:
Not For Construction

issuance:
Rennovation Drawings V5

sheet number: 14 of 35

sheet revisions:

No. Date Description


key plan:

Level 3 Renovated Floor Plan

drawn by: Patrick G scale: 1/4" = 1'-0" 24 in × 36 in

12/19/2023 12:52:20 PM Do not scale. Check all dimensions on site.

A-103.01

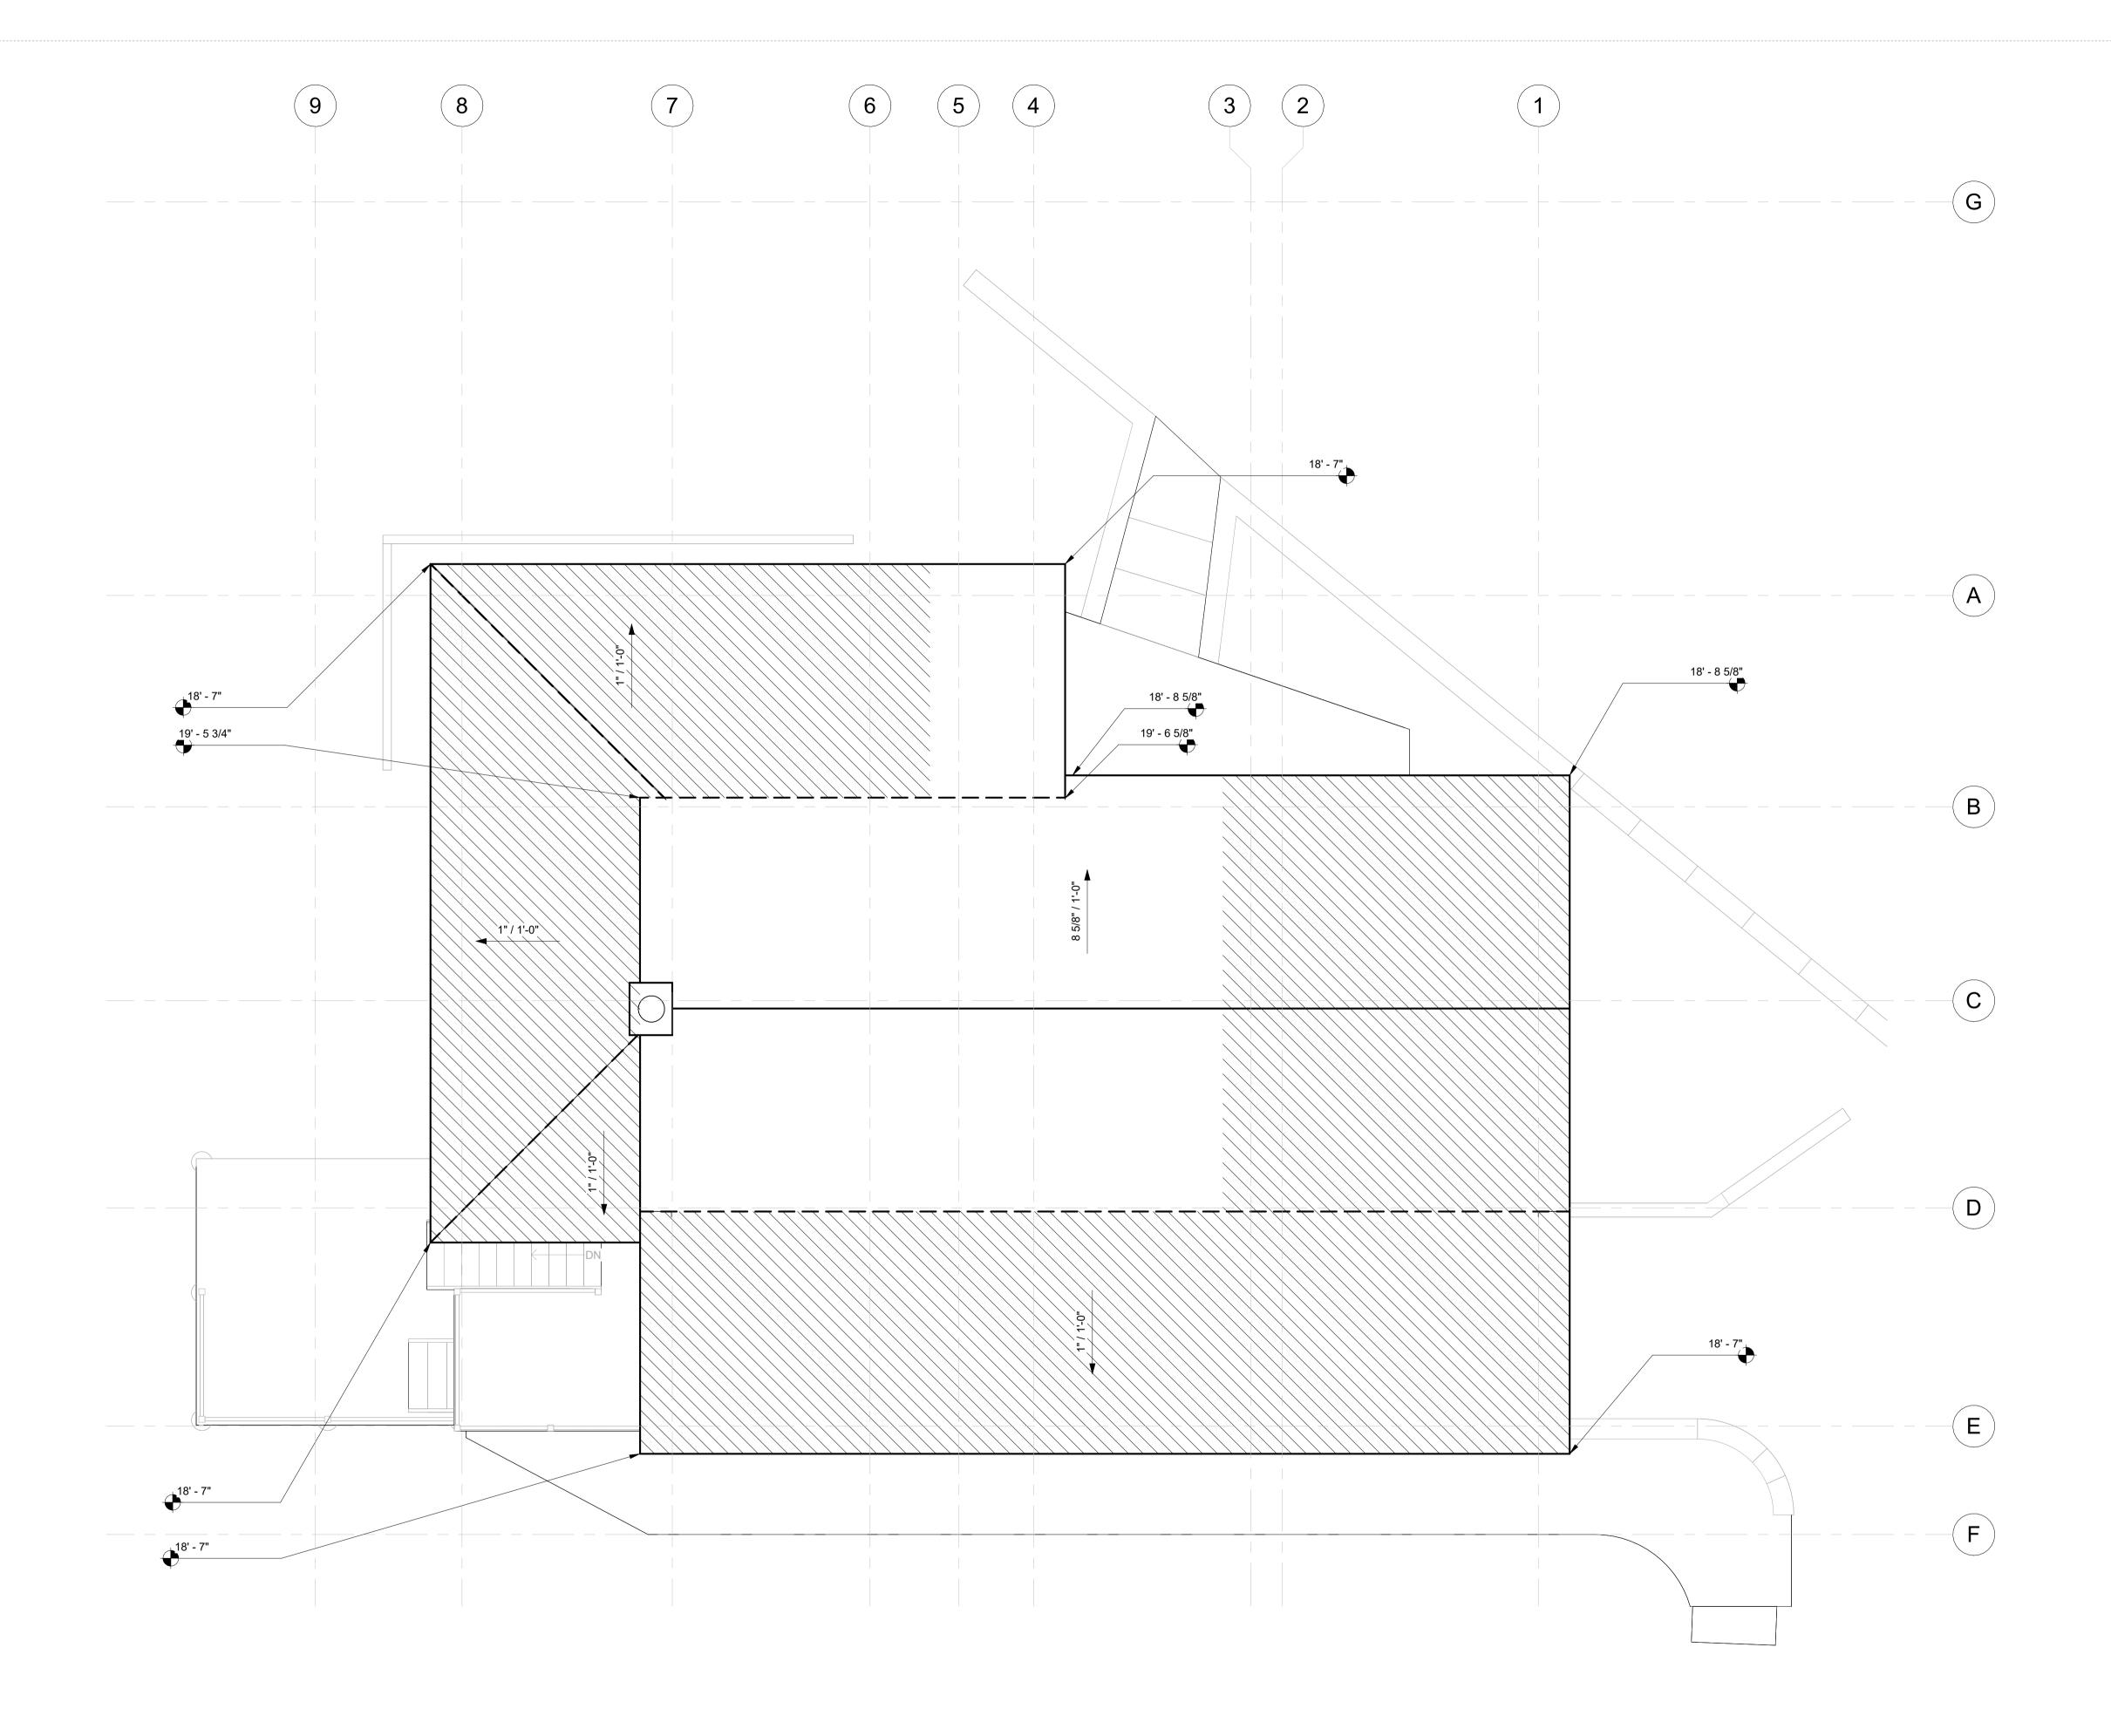

2 Existing - Roof Plan 1/4" = 1'-0"

client: **Robert & Sally Griffin**2712 N Magnolia Ave,

Chicago, IL 60614

architectural designer:
Patrick Griffin 2712 N Magnolia Ave, Chicago, IL 60614

structural engineer:

civil engineer:

consultant:

project name: **Griffin Residence**7655 Lilly Lake Rd.
Burlington, WI 53105

project number: PG-2023-001



status: Not For Construction

issuance:
Rennovation Drawings V5

sheet number: 15 of 35

sheet revisions:

No. Date Description

key plan:

sheet title:


Demolition Roof Plan

Patrick G 1/4" = 1'-0" 24 in × 36 in

12/19/2023 12:52:21 PM

Do not scale. Check all dimensions on site.

A-104.00

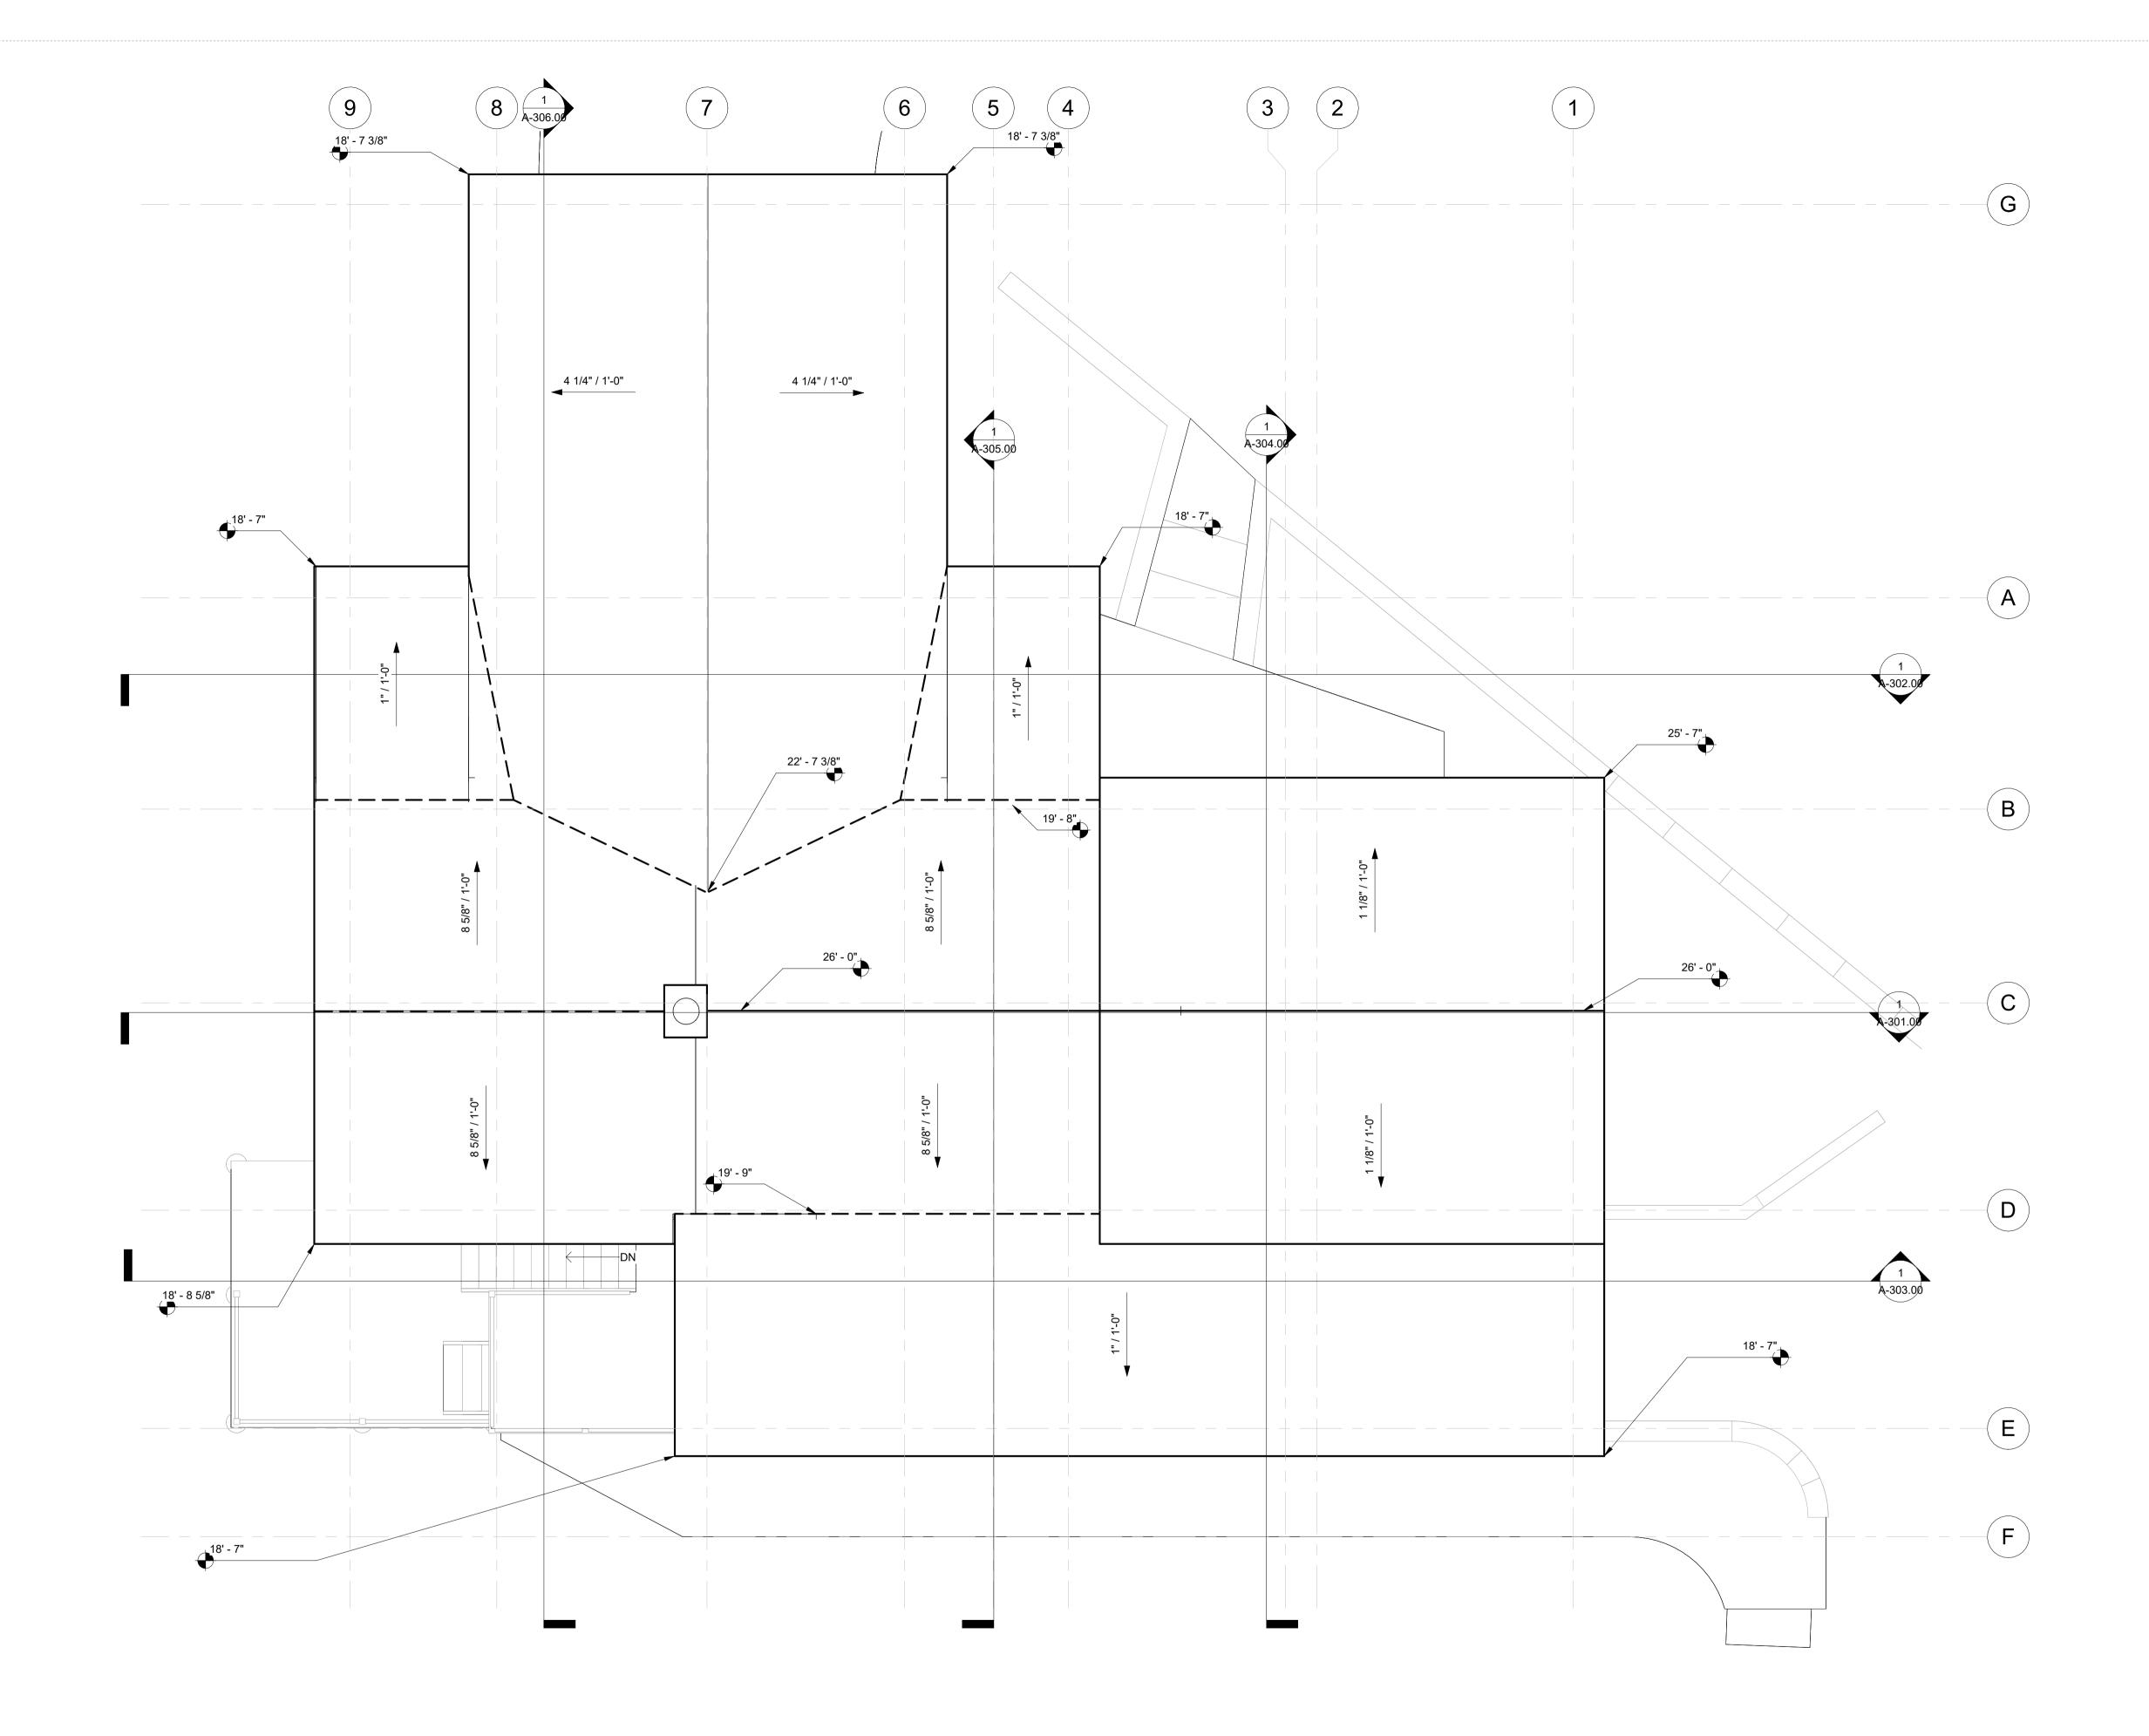

Proposed - Roof Plan 1/4" = 1'-0"

client: **Robert & Sally Griffin**2712 N Magnolia Ave,

Chicago, IL 60614

architectural designer:
Patrick Griffin 2712 N Magnolia Ave, Chicago, IL 60614

structural engineer:

civil engineer:

consultant:

project name: **Griffin Residence**7655 Lilly Lake Rd.
Burlington, WI 53105

project number: PG-2023-001



status:
Not For Construction

issuance:
Rennovation Drawings V5

sheet number: 16 of 35

sheet revisions:

No. Date Description

key plan:

Renovated Roof Plan

Patrick G 1/4" = 1'-0" 24 in × 36 in

12/19/2023 12:52:23 PM Do not scale. Check all dimensions on site.

sheet number: **A-104.01**



GENERAL NOTES

1. ALL CONSTRUCTION SHALL CONFORM AND COMPLY WITH ALL APPLICABLE CODES, LAWS, ORDINANCES, RULES AND REGULATIONS, LAWFUL ORDERS, ACCESSIBILITY CODES AND STANDARDS OF ANY FEDERAL, STATE OR LOCAL AUTHORITY BEARING ON LINE PERFORMANCE OF THE WORK.

2. ALL REFERENCES TO CODES, SPECIFICATIONS, AND STANDARDS REFERRED TO IN THE SPECIFICATIONS AND/OR DRAWINGS SHALL MEAN THE LATEST EDITION, AMENDMENT OR REVISION ADOPTED BY THE JURISDICTION IN WHICH THE PROJECT IS LOCATED, AT THE TIME OF ISSUANCE OF THE LATEST DATE OF

3. ALL WORK SHALL COMPLY WITH THE REQUIREMENTS, POLICIES, AND PROCEDURES OF THE OWNER.

4. DRAWINGS AND SPECIFICATIONS ARE TO BE ISSUED TO THE SUBCONTRACTORS IN COMPLETE SETS SO THAT THE FULL EXTENT OF WORK IS SHOWN AND COORDINATION OF WORK IS MADE POSSIBLE.

5. SUBCONTRACTORS FOR EACH TRADE ARE ADVISED THAT INFORMATION PERTINENT TO THEIR WORK MAY OCCUR IN OTHER PORTIONS OF THE CONTRACT DOCUMENTS. REFER TO CIVIL, STRUCTURAL, MECHANICAL, ELECTRICAL, PLUMBING AND ANY OTHER TRADE'S DRAWINGS FOR ADDITIONAL GENERAL NOTES. ABBREVIATIONS AND SYMBOLS. ALL NOTES ARE TO BE REVIEWED AND APPLIED TO RELATED BUILDING COMPONENTS. NOTES APPEAR ON VARIOUS SHEETS FOR DIFFERENT SYSTEMS AND MATERIALS. SHEETS ARE TO BE REVIEWED AND NOTES ON ANY ONE SHEET ARE TO BE APPLIED ON RELATED DRAWINGS AND DETAILS.

6. THE STRUCTURAL, MECHANICAL, ELECTRICAL AND PLUMBING DRAWINGS ARE OF EQUAL IMPORTANCE WITH THE ARCHITECTURAL DRAWINGS IN DEFINING THE WORK OF THE CONTRACT DOCUMENTS. THE CONTRACTOR SHALL COORDINATE PLACEMENT OF ALL COMPONENTS WITH ARCHITECTURAL. MECHANICAL, ELECTRICAL, PLUMBING, AND FIRE PROTECTION TRADES. WHERE DISCREPANCIES EXIST BETWEEN DRAWINGS AND INSTALLATION CONSULT THE ARCHITECT BEFORE PROCEEDING WITH THE WORK. ANY WORK INSTALLED IN CONFLICT WITH THE ARCHITECTURAL DRAWINGS SHALL BE CORRECTED BY THE CONTRACTOR AT HIS EXPENSE AND AT NO ADDITIONAL COST TO THE OWNER.

7. THE DRAWINGS ISSUED HEREWITH ARE SCOPE DOCUMENTS AND AS SUCH DO NOT NECESSARILY SHOW OR DESCRIBE ALL OF THE WORK REQUIRED FOR FULL COMPLETION OF THE WORK, NOR DO THEY SHOW ALL OF THE CONDITIONS WHICH MAY BE ENCOUNTERED IN THE COURSE OF THE COMPLETION OF THE

8. DETAILS SHOWN ARE INTENDED TO BE INDICATIVE OF THE PROFILES AND TYPES OF DETAILING REQUIRED FOR THE WORK, DETAILS NOT SHOWN ARE SIMILAR IN CHARACTER TO THOSE DETAILED. THE CONTRACTOR IS TO PROVIDE ALL DETAILS REQUIRED FOR CONSTRUCTION IN SUBMITTALS PROVIDED TO THE DESIGN TEAM. THE CONTRACTOR IS TO SUBMIT RFIS FOR ANY CLARIFICATIONS REQUIRED TO DEVELOP THE ADDITIONAL REQUIRED DETAILS.

9. ALL WORK SHALL BE OF THE HIGHEST QUALITY FOLLOWING THE CONTRACT DOCUMENTS, PROJECT SPECIFICATIONS, MANUFACTURERS SPECIFICATIONS AND RECOMMENDATIONS, AND THE BEST ACCEPTED

10. PROVIDE ALL SHOP DRAWINGS, CATALOG CUTS, SAMPLES, ETC. FOR THE NECESSARY WORK REQUIRED AND FOR ARCHITECT'S REVIEW PRIOR TO COMMENCEMENT OF THE WORK.

11. EACH CONTRACTOR SHALL KEEP ACCURATE RECORDS OF ALL WORK WHICH DIFFERS FROM CONTRACT DOCUMENTS SO THAT ACCURATE RECORD DRAWINGS AND SPECIFICATIONS CAN BE KEPT AND PROVIDED TO THE OWNER AT PROJECT CLOSEOUT.

12. EACH CONTRACTOR SHALL VISIT THE PROJECT SITE AND BE KNOWLEDGEABLE OF CONDITIONS THEREON AND SHALL INVESTIGATE AND BE RESPONSIBLE FOR ALL CONDITIONS OF THE PROJECT. THE CONTRACTOR SHALL NOTIFY THE OWNER OF ANY CONDITIONS THAT REQUIRE MODIFICATION BEFORE PROCEEDING WITH THE WORK.

13. FAILURE TO EXAMINE THE SITE AND DETERMINE EXISTING CONDITIONS OR NATURE OF NEW CONSTRUCTION, OR NATURE AND EXTENT OF WORK TO BE PERFORMED BY OTHER TRADES WILL NOT BE CONSIDERED A BASIS FOR GRANTING OF ADDITIONAL COMPENSATION OR EXTENDING THE CONSTRUCTION SCHEDULE.

14. THE CONTRACTOR SHALL INVESTIGATE, VERIFY AND BE RESPONSIBLE FOR ALL REQUIREMENTS OF

THE PROJECT AND SHALL NOTIFY THE ARCHITECT OF ANY CONDITIONS CONTRARY TO THE CONSTRUCTION DOCUMENTS THAT REQUIRE MODIFICATION BEFORE PROCEEDING WITH THE WORK.

15. THE CONTRACTOR SHALL PROTECT ALL EXISTING SITE ELEMENTS AND ADJACENT AREAS FROM DAMAGE AND DISRUPTION DUE TO THE CONSTRUCTION OPERATIONS, AND REPAIR OR REPLACE ANY ELEMENTS DAMAGED DURING THE PROJECT.

16. ANY UTILITY SHUT-OFFS AS REQUIRED BY THE CONTRACTOR FOR COMPLETION OF THEIR WORK SUCH AS ELECTRICAL, GAS, WATER, SEWER, ETC. MUST BE SCHEDULED WITH THE OWNER PRIOR TO

17. THE CONTRACTOR SHALL SECURE AND PAY FOR REQUIRED PERMITS AND ALL OTHER FEES, LICENSES AND INSPECTIONS NECESSARY FOR THE PROPER EXECUTION AND COMPLETION OF THE WORK.

18. THE CONTRACTOR SHALL BE RESPONSIBLE FOR OBTAINING ALL INSPECTIONS AND APPROVALS REQUIRED DURING THE COURSE OF THE WORK.

19. THE CONTRACTOR SHALL BE RESPONSIBLE FOR DAILY CLEANING AND REMOVAL OF ALL DEBRIS, DUST AND EQUIPMENT RELATED TO THE WORK AND FOR THOROUGH CLEAN-UP OF ALL AREAS OF WORK UPON

20. MAINTAIN AREAS OF WORK SECURE AND LOCKABLE DURING CONSTRUCTION, COORDINATE CONSTRUCTION OPERATIONS WITH OWNERS SECURITY REQUIREMENTS.

21. WHETHER OR NOT SPECIFICALLY INDICATED, ALL GLAZING SHALL BE SAFETY GLAZED WHEN WITHIN 18" OF THE FLOOR OR WITHIN 3'-0" HORIZONTAL DISTANCE FROM ANY DOOR, A CERTIFICATE MUST ACCOMPANY ALL GLAZING PRODUCTS STATING THAT THE PRODUCTS CONFORM WITH APPLICABLE CONSUMER PRODUCT SAFETY STANDARDS.

22. THE CONTRACTOR SHALL HAVE SOLE RESPONSIBILITY FOR DETERMINING THE MEANS. METHODS. SEQUENCES AND SAFETY PROCEDURES USED IN PERFORMING THE WORK. THE ARCHITECT/ENGINEER DOES NOT HAVE THE RIGHT TO STOP THE WORK. SHOULD THE ARCHITECT/ENGINEER VISIT THE SITE, IT IS IN THE CAPACITY AS ARCHITECT/ENGINEER AND NOT IN THE CAPACITY OF A CONTRACTOR.

INSTALLATION, GENERAL

1. PROVIDE EXPANSION AND/OR CONTROL JOINTS IN ACCORDANCE WITH SPECIFIED OR DRAWN REQUIREMENTS. IN THE ABSENCE OF SPECIFIED OR DRAWN REQUIREMENTS, PROVIDE JOINTS IN ACCORDANCE WITH ACCEPTED INDUSTRY STANDARDS. LOCATIONS SHALL BE REVIEWED AND ACCEPTED BY THE ARCHITECT PRIOR TO INSTALLATION.

2. ALL JOINTS OF ANY ELEMENT OF CONSTRUCTION WHICH IS REQUIRED TO HAVE A FIRE RESISTIVE RATING SHALL BE INSTALLED PER MANUFACTURER'S TESTED ASSEMBLIES AND SHALL PREVENT PASSAGE

3. ALL WOOD BLOCKING AND FRAMING USED IN WALL, FLOOR, AND CEILING CONSTRUCTION SHALL BE FIRE RETARDANT TREATED. COMBUSTIBLE MATERIALS MAY NOT BE USED IN ANY ASSEMBLY WITH REQUIRED FIRE RESISTANCE OF 2 HR OR MORE.

4. ALL OPENINGS IN FIRE-RATED FLOORS AND FIRE-RATED WALLS INCLUDING SPACES BETWEEN DUCTS. PIPES, CONDUIT, ETC., SHALL BE CLOSED OFF BY TESTED AND APPROVED FIRE-RATED ASSEMBLIES TO MAINTAIN FIRE RATING CONTINUITY OF RATED FLOOR OR WALL CONSTRUCTION, EXCEPT WHEN COMPLETELY ENCLOSED WITHIN FIRE-RATED CONSTRUCTION, ALL OPENINGS AND PENETRATIONS SHALL BE SEALED TO PREVENT PASSAGE OF SMOKE AND FLAMES WITH THE TESTED AND APPROVED FIRE-RATED ASSEMBLIES.

5. OMIT MANUFACTURER'S NAMES, LABELS AND DESIGNATIONS FROM EXPOSED FACES ON ALL ACCESSORIES, GLAZING, FIXTURES, ETC., EXCEPT WHERE REQUIRED TO REMAIN PER CODE REQUIREMENTS.

6. UNLESS NOTED OTHERWISE, ALL FASTENERS AND FASTENING DEVICES ARE TO BE CONCEALED AT ALL EXTERIOR AREAS AND IN ALL INTERIOR FINISHED SPACES.

7. ALL EXTERIOR HANDRAILS, FERROUS METAL WORK, AND STRUCTURAL STEEL AND THEIR ASSEMBLIES USED ON EXTERIOR OR IN OTHER NONCONDITIONED SPACES SHALL BE HOT-DIPPED GALVANIZED, AND PAINTED WHERE INDICATED IN THE DRAWINGS AND SPECIFICATIONS.

8. ALL DISSIMILAR METALS SHALL BE EFFECTIVELY ISOLATED FROM EACH OTHER IN ORDER TO AVOID GALVANIC ACTION. SEE SPECIFICATIONS FOR REQUIREMENTS.

9. FINISH FLOOR ELEVATIONS ARE TO THE TOP OF CONCRETE UNLESS NOTED OTHERWISE

10. ALL EXTERIOR JOINTS AROUND WINDOW AND DOOR FRAMES, BETWEEN WALLS AND FOUNDATION, BETWEEN WALLS AND ROOF, BETWEEN WALL PANELS AND AT PENETRATIONS, ETC., THROUGH THE EXTERIOR ENVELOPE SHALL BE SEALED, CAULKED OR WEATHER-STRIPPED WITH TWO LINES OF DEFENSE TO PREVENT AIR AND WATER INFILTRATION

DIMENSIONS

1. DO NOT SCALE THE DRAWINGS; WRITTEN DIMENSIONS SHALL GOVERN. LARGE SCALE DRAWINGS SHALL GOVERN OVER SMALL SCALE, (E.G. 1 1/2" SCALE DETAILS SHALL GOVERN OVER 1/4" SCALE DETAILS). WHERE A DISCREPANCY MAY EXIST BETWEEN DRAWINGS AND SPECIFICATIONS, THE MORE RESTRICTIVE OR EXPENSIVE REQUIREMENTS SHALL GOVERN.

2. THE CONTRACTOR SHALL VERIFY ALL DIMENSIONS ON SITE, AND SHALL NOTIFY THE ARCHITECT IN WRITING OF ANY DISCREPANCIES, OMISSIONS AND/OR CONFLICTS BEFORE PROCEEDING WITH THE

3. ALL PARTITIONS ARE DIMENSIONED TO THE FACE OF GYPSUM BOARD PARTITION. UNLESS NOTED

NOTIFY THE ARCHITECT IN WRITING BEFORE PROCEEDING WITH ANY WORK IN QUESTION. 4. DOOR OPENINGS ARE DIMENSIONED TO THE HINGE SIDE JAMB OF OPENING. DOOR OPENINGS THAT ARE NOT DIMENSIONALLY LOCATED ARE TO BE POSITIONED WITH ONE JAMB CASING TRIM 6" FROM

ADJACENT WALL OR COLUMN AS SHOWN ON THE PLANS AND /OR DETAILS.

OTHERWISE. WHERE SPECIFIC DIMENSIONS, DETAILS AND/OR DESIGN INTENT CANNOT BE DETERMINED.

1. REFER TO THE SPECIFICATIONS AND CIVIL, LANDSCAPING, ARCHITECTURAL, STRUCTURAL, MECHANICAL, ELECTRICAL, PLUMBING, FIRE PROTECTION, AND ADDITIONAL CONSULTANT'S DRAWINGS FOR FULL COORDINATION OF WORK.

2. REFER TO SITE SURVEY FOR SITE INFORMATION. SITE SURVEY MAY BE INCLUDED WITH THE DOCUMENTS FOR "INFORMATION ONLY", AND CONTRACTOR SHALL VERIFY ALL INFORMATION SHOWN

3. THE CONTRACTOR SHALL FURNISH, COORDINATE AND INSTALL ALL CONCEALED BLOCKING, STIFFENERS, BRACING, PLATES AND SUPPORTING BRACKETS REQUIRED FOR THE INSTALLATION OF HANDRAILS, GRAB BARS, WINDOW TREATMENTS, WALL PANELS, CASEWORK, WALL MOUNTED EQUIPMENT OR ACCESSORIES AND OR SUSPENDED MECHANICAL, ELECTRICAL OR OTHER EQUIPMENT WHETHER SHOWN IN THE DRAWINGS OR NOT. THIS SHALL ALSO APPLY TO OWNER FURNISHED, CONTRACTOR INSTALLED ITEMS.

4. THE CONTRACTOR SHALL COORDINATE AND VERIFY THE EXACT SIZE AND LOCATION OF ALL FLOOR PENETRATIONS AND OPENINGS IN WALLS AND CEILINGS INDICATED WITHIN EACH OF THE RESPECTIVE MECHANICAL. ELECTRICAL. PLUMBING AND FIRE PROTECTION DRAWINGS. ALL PARTITIONS SHALL BE ADEQUATELY BRACED AND OPENINGS REINFORCED. SUBMIT COORDINATED DRAWINGS OF ALL PENETRATIONS FOR REVIEW.

5. GENERAL CONTRACTOR TO COORDINATE ELECTRICAL DEVICES, ELECTRICAL CONDUIT, ELECTRICAL BUSSING, CABLE TRAYS, DUCTWORK AND MECHANICAL SYSTEMS WITH ALL LIGHTING FIXTURES, RETURN AND SUPPLY DIFFUSERS, SMOKE DETECTORS, ALARM/SECURITY DEVICES AND SPRINKLER HEAD LOCATIONS AS INDICATED ON THE CONTRACT DOCUMENTS. THE CONTRACTOR SHALL IDENTIFY ANY VARIATIONS OR CONFLICTS WITH THE LAYOUT INDICATED, CEILING HEIGHT, OR CLEAR SPACE ALLOWED FOR THESE ITEMS AS INDICATED IN THE CONTRACT DOCUMENTS. THE CONTRACTOR WILL NOTIFY THE ARCHITECT OF THESE CONFLICTS/VARIATIONS FOR REVIEW, COMMENT AND APPROVAL PRIOR TO SHOP DRAWING SUBMITTALS AND INSTALLATION.

6. THE CONTRACTOR IS TO PROVIDE AND COORDINATE LOCATIONS OF ACCESS PANELS AS REQUIRED BY CODE AND FOR THE LOCATION OF MEP/FP EQUIPMENT AND DEVICES NEEDING ACCESS FOR ROUTINE INSPECTION AND MAINTENANCE. ALL ACCESS PANELS SHALL BE FLUSH WITH WALL OR CEILING SURFACE, WITH CONCEALED FASTENERS. THE CONTRACTOR SHALL SUBMIT COORDINATED DRAWINGS INDICATING THE LOCATION OF ACCESS PANELS IN THE CEILING AND WALLS FOR REVIEW BY THE ARCHITECT PRIOR TO

7. THE CONTRACTOR SHALL NOTIFY THE ARCHITECT IN ADVANCE OF ANY MEP/FP DEVICES REQUIRED AS PART OF THE SPECIFIED SYSTEM WHICH ARE TO BE MOUNTED IN FINISHED SPACES AND ARE NOT LOCATED ON THE ARCHITECTURAL DRAWINGS. THE ARCHITECT WILL DETERMINE THE MOUNTING LOCATION, HEIGHT, AND DETAIL FOR ATTACHMENT.

8. ALL CONDUIT, CABLE TRAY, ELECTRICAL BUSWAY, PIPING, DUCTWORK, AND MECHANICAL SYSTEMS SHALL BE INSTALLED WITHIN OR TIGHT TO THE UNDERSIDE OF STRUCTURE WHERE FEASIBLE. WHERE "FLYWAYS" ARE INDICATED IN THE CONTRACT DOCUMENTS, THESE ITEMS MUST REMAIN IN THE "FLYWAY" SPACE PROVIDED.

9. REFER TO MEP/FP DRAWINGS FOR EXTENT OF CONCRETE EQUIPMENT PADS. THE CONTRACTOR SHALL COORDINATE THE SIZE AND LOCATION OF THE CONCRETE PADS WITH THE EQUIPMENT INSTALLER.

10. DETAILS NOT SHOWN IN THE DRAWINGS ARE SIMILAR IN CHARACTER TO THOSE DETAILS THAT ARE SHOWN. WHERE SPECIFIC DIMENSIONS, DETAILS OR DESIGN INTENT CANNOT BE DETERMINED, CONSULT THE ARCHITECT BEFORE PROCEEDING WITH THE WORK.

11. WALL TYPE INDICATIONS ON A WALL SHALL MEAN THE ENTIRE LENGTH OF THE WALL IS TO MATCH THE WALL TYPE INDICATED.

FIRE PROTECTION

1. PROVIDE UL RATED PORTABLE CLEAN AGENT FIRE EXTINGUISHER WITH A RATING OF NOT LESS THAN 2A10BC, OR AS INDICATED IN SPECIFICATION SECTION 104416, WITHIN 75 FEET TRAVEL DISTANCE, OR AS REQUIRED BY FIRE EXTINGUISHER TYPE USED. TO ALL PORTIONS OF THE BUILDING ON EACH FLOOR. AND ADDITIONAL EXTINGUISHERS AS REQUIRED BY LOCAL OFFICIALS. PROVIDE WET CHEMICAL K TYPE FIRE EXTINGUISHERS OF CAPACITY 2A:K, WITHIN 30 FEET TRAVEL DISTANCE, FOR COMMERCIAL KITCHEN AREAS WHERE THERE IS A POTENTIAL FOR FIRES INVOLVING COMBUSTIBLE COOKING MEDIA. REFER TO SPECIFICATIONS FOR SPECIAL REQUIREMENTS AT COLOCATION AND ELECTRICAL ROOM SPACES. FIRE EXTINGUISHER VENDOR TO SUBMIT A LAYOUT FOR REVIEW BY ARCHITECT THAT INCLUDES THE LOCATION OF ALL FIRE EXTINGUISHERS TO BE INSTALLED WITH AN INDICATION OF THE RECESSED OR SEMI-RECESSED FIRE EXTINGUISHER CABINETS TO BE PROVIDED.

FIRE EXTINGUISHER TYPES 'FE-1': CLEAN AGENT WITH RATING NOT LESS THAN 2A10BC FIRE EXTINGUISHER TYPES 'FE-2': WET CHEMICAL K TYPE OF CAPACITY 2A:K. FIRE EXTINGUISHER CABINET TYPE 'C1': RECESSED PAINTED CABINET FIRE EXTINGUISHER CABINET TYPE 'C1r': RATED RECESSED PAINTED CABINET FIRE EXTINGUISHER CABINET TYPE 'C2': NON-RATED SEMI RECESSED PAINTED CABINET FIRE EXTINGUISHER CABINET TYPE 'C2r': FIRE-RATED SEMI RECESSED PAINTED CABINET FIRE EXTINGUISHER CABINET TYPE 'C3': SURFACE MOUNTED PAINTED CABINET FIRE EXTINGUISHER CABINET TYPE 'C4': WALL BRACKET MOUNTED FIRE EXTINGUISHER

2. PROVIDE EXIT SIGNS WITH MINIMUM 6 INCH HIGH LETTERS, OR AS REQUIRED BY LOCAL CODE, AT REQUIRED EXITS AS SHOWN IN THE DRAWINGS. INSTALL ADDITIONAL EXIT SIGNS AS REQUIRED BY LOCAL

3. PROVIDE EMERGENCY LIGHTING OF MINIMUM 1 FOOT CANDLE, OR AS REQUIRED BY LOCAL CODE, AT EACH FLOOR LEVEL.

4. MAINTAIN CLEAR EXIT PATHWAYS AT LEAST 44 INCHES WIDE IN ALL PUBLIC AREAS

LIMITATIONS FOR FLAME SPREAD (0-25) AND SMOKE DENSITY DEVELOPED (150).

5. ALL EXIT DOORS SHALL BE OPERABLE FROM THE INSIDE WITHOUT THE USE OF A KEY OR ANY SPECIAL KNOWLEDGE OR EFFORT. SPECIAL LOCKING DEVICES SHALL BE OF AN APPROVED TYPE. ALL DOORS SHALL HAVE APPROVED LEVER HARDWARE OR PANIC BARS.

6. DOORS OPENING INTO REQUIRED 1-HOUR FIRE RESISTIVE EXIT PASSAGEWAYS SHALL BE PROTECTED WITH A SMOKE OR DRAFT STOP ASSEMBLY HAVING A 20 MIN. RATING AND SHALL BE SELF CLOSING WITH

7. EXIT DOORS SHALL SWING IN THE DIRECTION OF TRAVEL WHEN SERVING 50 OR MORE PERSONS OR IN ANY HAZARDOUS USE AREA.

8. INTERIOR FLOOR, WALL AND CEILING FINISHES THROUGHOUT THE AREA OF WORK SHALL MEET CLASS I

9. PROVIDE REQUIRED SMOKE OR FIRE DAMPERS WHERE AIR DUCTS PENETRATE FIRE RATED WALLS, FLOORS OR CEILINGS.

10. ALL FIRE RESISTIVE RATED DOORS SHALL HAVE THE APPROPRIATE UL OR OTHER RATING AGENCY LABEL ACCEPTABLE TO GOVERNMENT AUTHORITIES AFFIXED TO BOTH DOOR AND FRAME. DO NOT PAINT

11. PROVIDE FIRE SAFING TO SEPARATE WALL CAVITIES FROM HORIZONTAL PLENUM AREAS AND BETWEEN FLOORS TO CLOSE OPENINGS. FIRE RATING OF SAFING TO EQUAL FIRE RATING OF SEPARATION OR FLOOR ASSEMBLY.

12. ALL RECESSED CABINETS, PANELS AND BOXES LOCATED IN FIRE-RATED WALLS SHALL BE INSTALLED TO MAINTAIN FIRE-RATED CONSTRUCTION.

13. PROVIDE TACTILE EXIT SIGNS AT STAIRWAYS, EXIT PASSAGEWAYS, EXIT DISCHARGE DOORS, AREAS OF REFUGE, ACCESSIBLE ENTRANCES AND ACCESSIBLE TOILET ROOMS, LOCATE WALL MOUNTED TACTILE

14. TWO-WAY COMMUNICATION SYSTEMS AND ALL ASSOCIATED SIGNAGE SHALL BE PROVIDED AT ALL AREAS DESIGNATED AS AREAS OF REFUGE.

LEGAL NOTICE

1 THESE CONSTRUCTION DOCUMENTS-PLANS, SPECIFICATIONS. ADDENDA, CLARIFICATIONS AND THE LIKE, MAY ONLY BE USED WITH THE WRITTEN AUTHORIZATION OF THE ARCHITECT OF

2 UNAUTHORIZED USE AND/OR ALTERATION, BY ANY PERSON, IN ANY WAY, OF ANY ITEM CONTAINED ON OR IN THESE CONSTRUCTION DOCUMENTS-PLANS, SPECIFICATION ADDENDA CLARIFICATIONS AND THE LIKE UNLESS ACTING UNDER THE SPECIFIC WRITTEN DIRECTION OF THE LICENSED PERSON(S) WHOSE PROFESSIONAL SEAL(S) ARE AFFIXED HERETO, IS

3 ALL IDEAS, DESIGNS, ARRANGEMENTS, PLANS AND SPECIFICATIONS, ADDENDA, CLALIFICATION, AND THE LIKE, INDICATED AND/OR REPRESENTED BY THESE CONSTRUCTION DOCUMENTS, ARE OWNED EXCLUSIVELY BY THE ARCHITECT OF

4 THESE WERE CREATED, AND DEVELOPED FOR THE EXCLUSIVE AND SPECIFIC USE ON, AND IN CONNECTION WITH, THIS PROJECT. NONE OF SUCH IDEAS, DESIGNS, ARRANGEMENTS, PLANS AND SPECIFICA.TION, ADDENDA, AND THE LIKE, AND SIMILAR RELATED DOCUMENTS, SHALL BE USED AND/OR REPRODUCED FOR ANY OTHER PURPOSE WHATSOEVER, WITHOUT THE EXPRESSED WRITIEN PERMISSION OF THE ARCHITECT OF RECORD.

Griffin Residence

Proposed Alterations to Existing Single Family Residence 7655 Lilly Lake Road, Burlington, WI 53105

DRAWING LIST

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Chicago, IL 60614 structural engineer:

architectural designer

Patrick Griffin

Robert & Sally Griffin 2712 N Magnolia Ave, Chicago, IL 60614


2712 N Magnolia Ave.

civil engineer:

consultant:

project name: Griffin Residence 7655 Lilly Lake Rd Burlington, WI 53105

project number: PG-2023-001

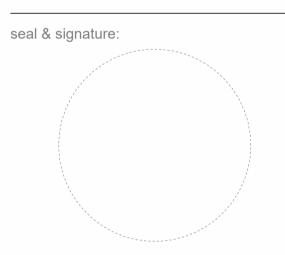

Not For Construction

Renovation Drawings V5

sheet number: 1 of 35

sheet revisions:

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key plan:

General Project Information


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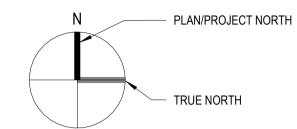
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SYMBOLS LEGEND

FOR ADDITIONAL SYMBOLS SEE STRUCTURAL, MECHANICAL, ELECTRICAL AND PLUMBING DRAWINGS




NORTH ARROW:

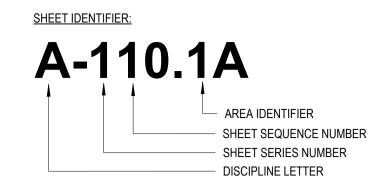

DETAIL TARGETS



COLUMN DESIGNATION SYMBOLS:

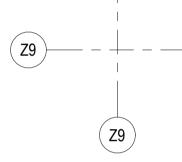

ELEVATION MARKS:


LEVEL NAME: INDICATED ON ELEVATIONS AND SECTIONS VERTICAL HEIGHT: INDICATED ON ELEVATIONS AND SECTIONS


SPOT ELEVATION SYMBOL




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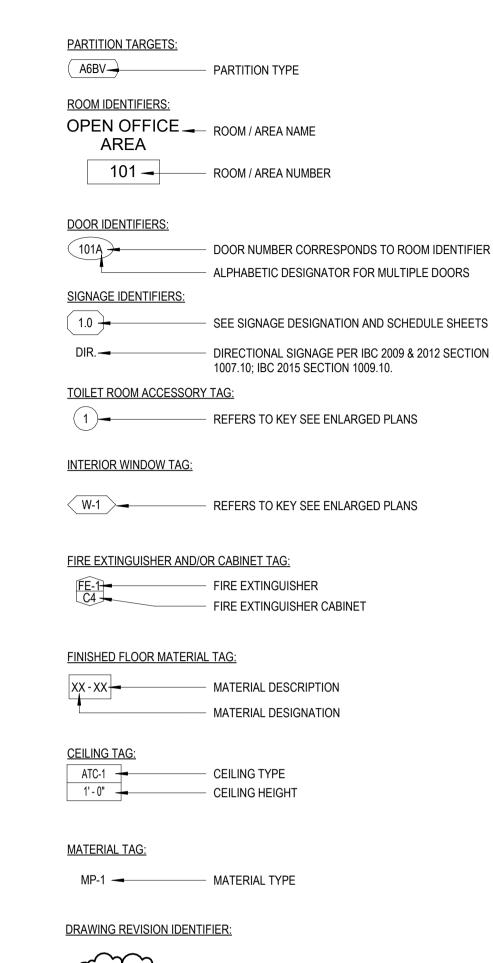
EXTERIOR ELEVATION




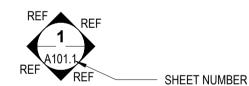


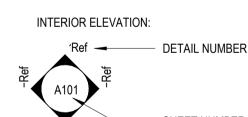
NEW WALL:			
EXISTING WALL:			



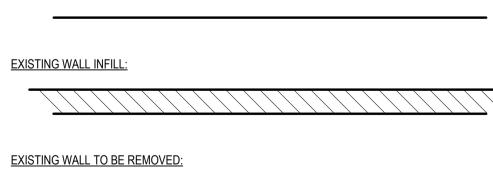

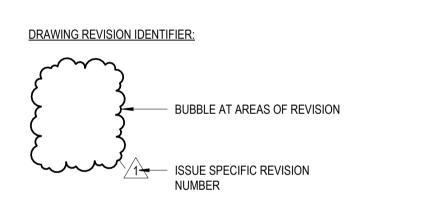

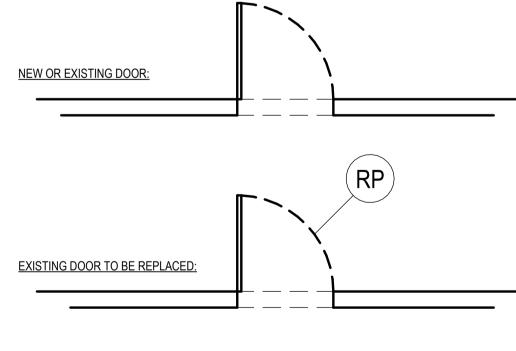

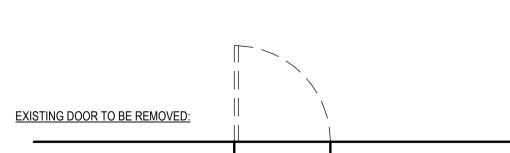

А ⊕	LED RECESSED LIGHT
A 1⊕	LED RECESSED ADJUSTABLE LIGHT
A2 ⊕	LED RECESSED LIGHT
В ⊕	LED RECESSED WET LOCATION LIGHT
С⊕	LED RECESSED WALL WASH LIGHT
D	LED SURFACE MOUNTED LIGHT (FBO)
E .	LED SURFACE MOUNTED PICTURE LIGHT (FBO)
F [::::::::	LED STRIP LIGHT
G [:::::::]	LED COVE LIGHT
G1::::::	LED WET LOCATION COVE LIGHT
н	PENDANT LIGHT (FBO)
J (vs)	WALL SCONCE (FBO)
K +	LED TRACK LIGHT
L ⊕	LED RECESSED PUCK LIGHT
X (vs)	EXTERIOR WALL SCONCE
8	SPRINKLER HEAD
######################################	CEILING LOUVER VENT
	CEILING SLOT VENT
S1	MANUAL ROLLER SHADE
S2	MOTORIZED ROLLER SHADE
S3	MANUAL ROMAN SHADE
S4	MOTORIZED ROMAN SHADE
S5	MANUAL CURTAINS
S6	MOTORIZED CURTAINS
\$	SINGLE SWITCH
\$0	DIMMER SWITCH
\$ ² _D	TWO-WAY DIMMER SWITCH
\$F	FAN SWITCH
ф	HALF SWITCHED DUPLEX
ф	DUPLEX OUTLET
GFI	GFI DUPLEX OUTLET
∯ _E	EXISTING DUPLEX OUTLET
GFI ⊕ E	EXISTING GFI DUPLEX OUTLET
¥	TELEPHONE JACK (RJ11)
*	CABLE / DATA JACK (RG6)
0	NEW OR EXISTING FIXTURE TO REMAIN
RP .	EXISTING FIXTURE TO BE REPLACED

EXISTING FIXTURE TO BE REMOVED

CODES, STANDARDS, AND PROCEDURES FLAT HEAD MACHINE SCREW ACOUSTICAL ACOUSTICAL PANEL TILE FIRE HOSE RACK WALL PROTECTION **PLASTER** ACOUSTICAL CEILING TILE FIN PLUMBING WATERPROOFING ACOUSTICAL WALL PANEL **FLOOR** PLYWOOD WSC WAINSCOT PNT **ADHESIVE FLEXIBLE** PAINT WS WINDOW COVERING **ADJUSTABLE FLUOR FLUORESCENT** WEIGHT WELDED WIRE FABRIC ACCESS FLOOR **FIREPROOF** POLISHED FIBER REINFORCED WALL PANEL ABOVE FINISHED FLOOR FOOT (FEET) **PROPERTY** ALUMINUM FACE TO FACE POUNDS PER SQUARE FOOT **ALTERNATE** POUNDS PER SQUARE INCH ANODIZED FOOTING **ANCHOR FURNISH PORCELAIN TILE** ANNUNCIATOR **FURRING** PTD **ACCESS PANEL** FUT **FUTURE** PTN PARTITION **APPROXIMATE** PTS PNEUMATIC TUBE STATION **ARCHITECTURA** GLASS BLOCK **QUARRY TILE ASPHALT ASSISTANT** GALVANIZED QTY QUANTITY **ASSEMBLY** GEN **GENERAL GLASS FILM** AUTOMATIC RECEPTION ALUMINUM WALL FRAMING GLAZING RECEP GLASS MOSAIC TILE REINFORCING **BOTTOM OF** RIGHT-OF-WAY GROUND BASEBOARD GYPSUM PLASTER RAD RADIUS **GROUT RUBBER BASE** BOARD **GRADE** BITUMINOUS REFLECTED CEILING PLAN **GREASE TRAP** BUILDING **ROOF DRAIN GLASS TILE** RIGHT HAND **BLOCK BLOCKING** GYPSUM WALL BOARD RECESSED REF HOSE BIB REFERENCE BENCHMARK **HOLLOW CORE** REFR REFRIGERATOR **BIO-METRIC READER** HARDWOOD REQUIRED BOTTOM HARDWARE RESIL RESILIENT **BRICK HOLLOW METAL** REVISION **BEARING** HOLD OPEN **ROOFING BASEMENT** HORIZONTAL ROOM BACK-TO-BACK HIGH POINT **ROUGH OPENING BUILT-UP ROOFING** HOUR RUBBER RISER HEIGHT **RESINOUS FLOOR** HEATING, VENTILATING, AND RUBBER TILE CATCH BASIN AIR CONDITIONING RUBBER TRANSITION EDGE **CORNER GUARD** RUBBER TREAD **HYDRANT** RTW **RUNNING TRIM** CIRCULATION CENTERLINE INSIDE DIAMETER CEILING SOUND ATTENUATION BLANKET INCH(ES) CLOSET SOUND ATTENUATION FIRE BLANKET INCANDESCENT SAFB CENTIMETER INCLUDE(D) CERAMIC MOSAIC TILE INSULATION SOLID CORE SCHEDULE CONCRETE MASONRY UNIT INTERIOR SCHED **CLEAN OUT** INTERMEDIATE SOAP DISPENSER COLUMN INT EL INVERT ELEVATION CONCRETE INTERIOR STONE COUNTER SECT SECTION CONFERENCE INTERIOR SOLID SURFACE COUNTER SECUR SECURITY CONNECTION SQUARE FOOT (FEET) CONSTRUCTION SGT STRUCTURAL GLAZED TILE CONSTR SHR CONT CONTINUOUS JANITOR CLOSET SHOWER SHEET COORD. COORDINATE SIMILAR KNOCK DOWN **STANDPIPE** CORR CORRIDOR KNOCK OUT **SPECIFICATION** CONTROL JOINT **KITCHEN** SPEAKER CERAMIC TILE KNEE SPACE SPRINK SPRINKLER CENTER SQUARE COUNTERSUNK SERVICE SINK CLOSED CIRCUIT TELEVISION LAUNDRY STAINLESS STEEL STONE STATION STA STC COLD WATER POUND(S) LINEAR FOOT SOUND TRANSMISSION CLASS STD STANDARD DOUBLE LEFT HAND DEG **DEGREE** LOCKER STL STEEL **DEMOLISH** LOW POINT STOR STORAGE DEPARTMENT LIGHT STW STANDING TRIM DIAMETER LIGHTWEIGHT STRUCTURAL LUXURY VINYL COMPOSITE TILE DIAGONAL SUSPENDED DIFFUSER SHEET VINYL DIMENSION **SWITCHBOARD** DISPENSER MACH MACHINE SYMMETRICAL DIVISION MAINTENANCE DOWN MASONRY TOP OF DOOR OPENING TOP & BOTTOM DAMPPROOFING MAXIMUM DOOR T&G METAL BASE **TONGUE & GROOVE** DOWNSPOUT METAL CORNER BEAD TRENCH DRAIN DIMENSIONAL STONE TILE **TELEPHONE** MECHANICAL MEMBRANE TEMPERED DISTILLED WATER **TERRAZZO** MEZZANINE TERRAZZO FLOOR TILE METAL FLASHING THK THICK MANUFACTURER **TOILET** MANHOLE TOPOGRAPHY MINIMUM **ELEVATION TOILET PARTITION MISCELLANEOUS ELASTOMERIC TELEVISION** MILLIMETER **ELECTRICAL** MASONRY OPENING TERRAZZO FLOOR **ELEVATOR** MOVEABLE **EMERGENCY** INSULATED METAL PANEL **ENCLOSURE** UNEXCAVATED **ENGINEER** METAL PANEL FORMED UNFINISHED UNLESS NOTED OTHERWISE **ENTRANCE** METAL PANEL PLATE UR UTIL **EXPANSION JOINT** MOUNTED UTILITY **ELECTRICAL OUTLET** MOUNTING ELECTRICAL PANEL METAL MULLION VINYL BASE VCT VINYL COMPOSITION TILE **EQUIPMENT** NORTH VENTILATION ELECTRIC WATER COOLER NOT IN CONTRACT **EXCAVATION** VERTICAL VESTIBULE VERIFY IN FIELD **EXISTING** NOMINAL VLP VENEERED LAMINATE PANEL **EXPANSION** NOT TO SCALE **EXPANSION JOINT** VOL VINYL TILE **EXTERIOR** ON CENTER VINYL WALL COVERING **OUTSIDE DIAMETER** OVERFLOW DRAIN FACE OF OFF WITH OFFICE OF/CI OWNER FURNISHED/ WITHOUT FIRE ALARM WATER CLOSET FACE BRICK CONTRACTOR INSTALLED FOOT CONTROL

PUBLIC ACCESS

PANEL FABRIC

PLATE

ARCHITECTURAL PRE-CAST

INSULATED PRE-CAST

PRE-CAST STRUCTURAL

PRE-CAST

WOOD FLOOR

WIDE FLANGE

WINDOW

WATER HEATER

WROUGHT IRON

WALL COVERING

WALK OFF MAT

WIRE MESH

FIBER CEMENT PANEL

FIRE EXTINGUISHER

FEC-CLEAN AGENT

FIRE HOSE CABINET

FIRE EXTINGUISHER CABINET

FE-CLEAN AGENT

FLOOR DRAIN

FOUNDATION

Robert & Sally Griffin 2712 N Magnolia Ave, Chicago, IL 60614

architectural designer **Patrick Griffin** 2712 N Magnolia Ave, Chicago, IL 60614

structural engineer:


civil engineer:

consultant:

project name:

Griffin Residence 7655 Lilly Lake Rd. Burlington, WI 53105

project number: PG-2023-001

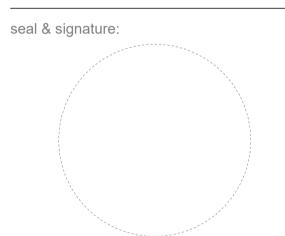

Not For Construction

Rennovation Drawings V5

sheet number: 2 of 35

sheet revisions: No. Date

Description


key plan:


Abbreviations & Symbols

drawn by: Patrick G 12" = 1'-0" 24 in × 36 in

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2 Existing - Site - Properties
1" = 100'-0"

sheet number: **A-001.01**

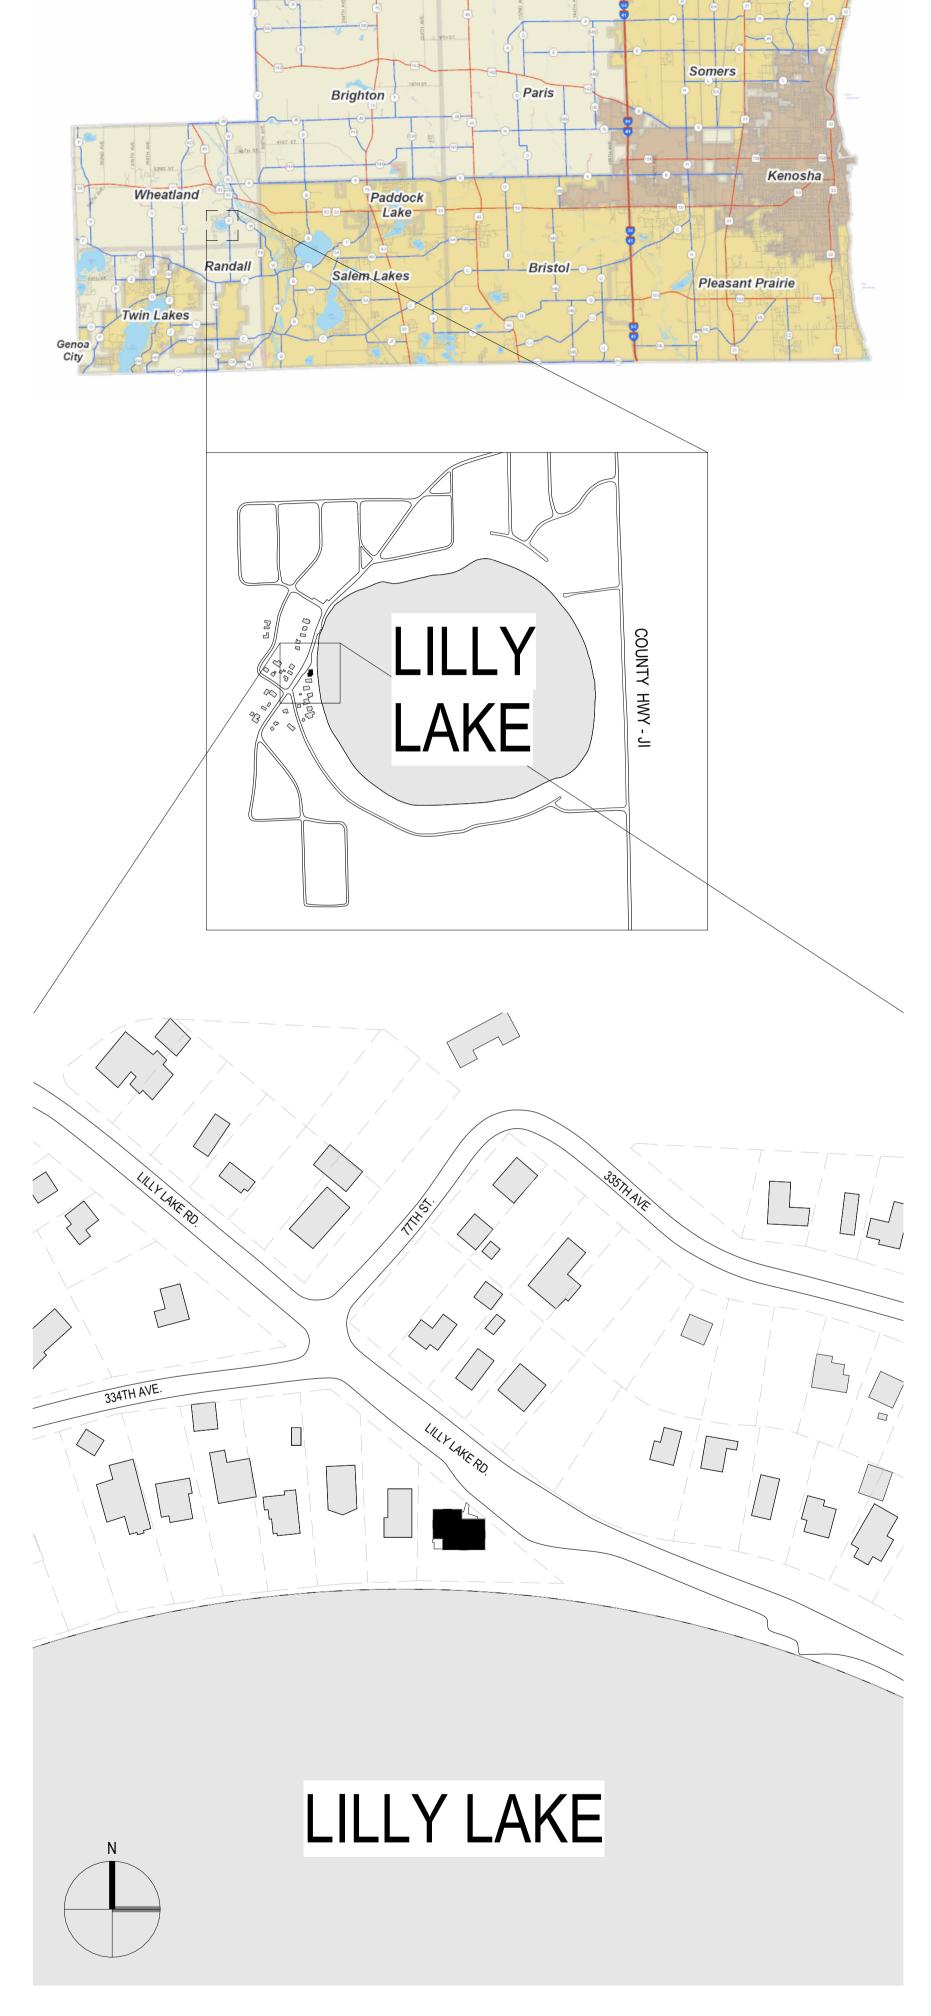Do not scale. Check all dimensions on site.
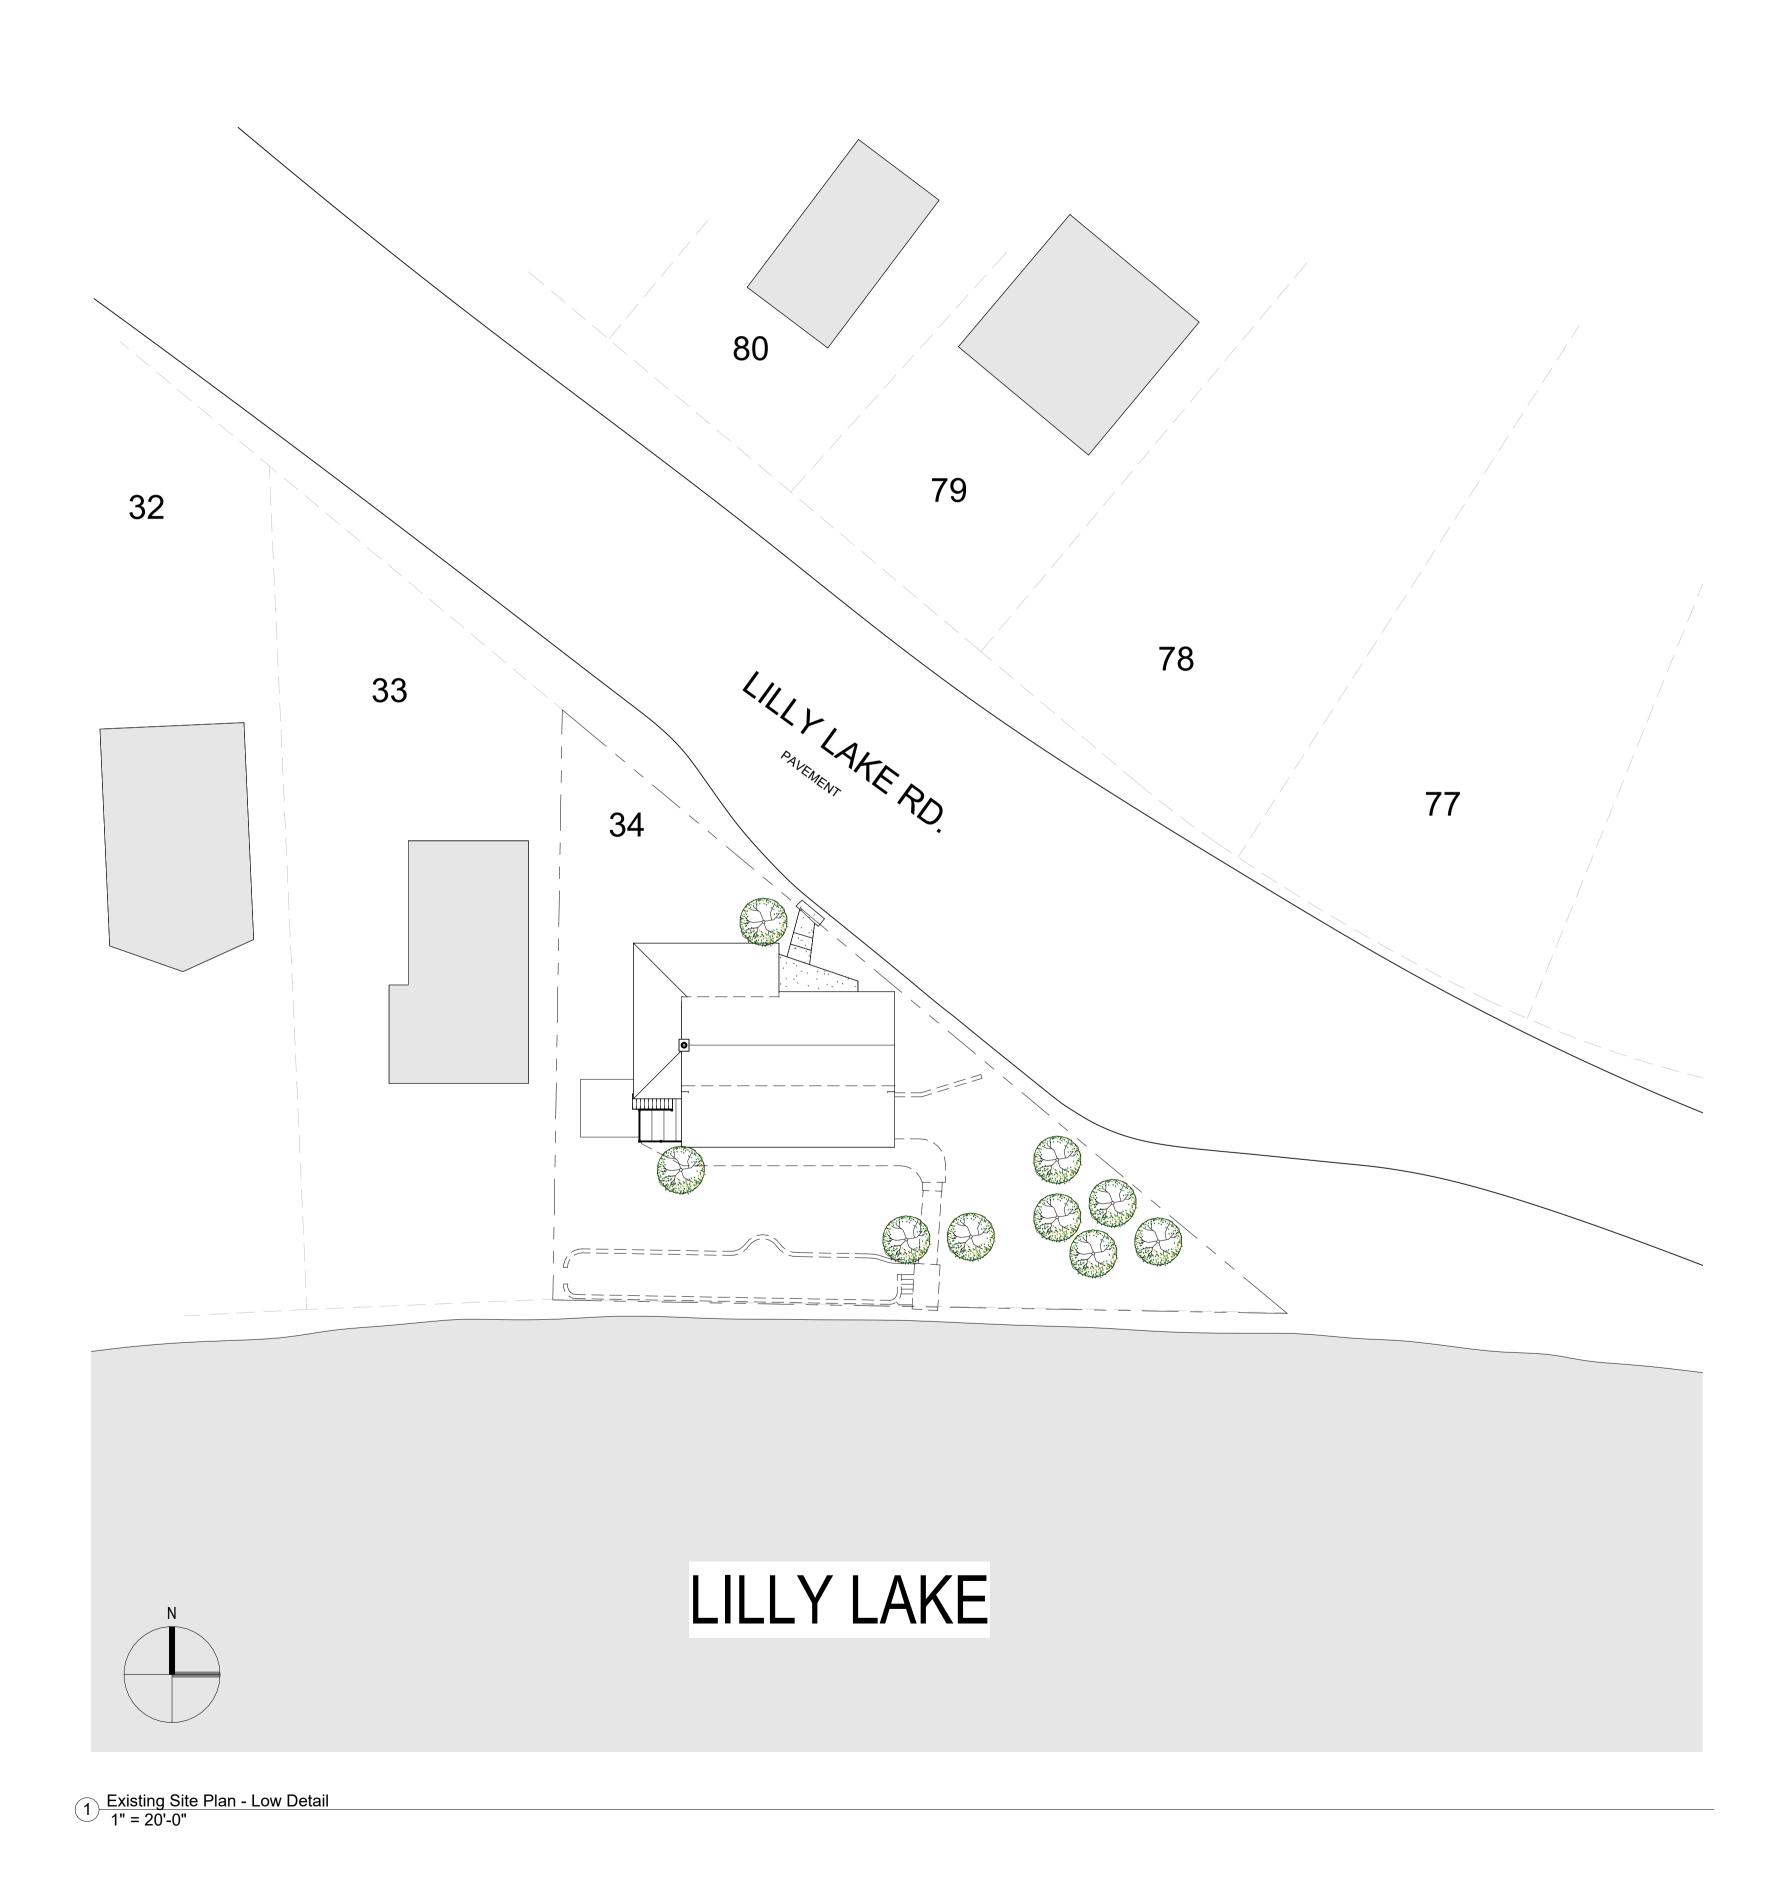
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Location Diagram &

Patrick G As indicated 24 in × 36 in

Site Plan

client: **Robert & Sally Griffin**2712 N Magnolia Ave,
Chicago, IL 60614

2712 N Magnolia Ave, Chicago, IL 60614

architectural designer:
Patrick Griffin

structural engineer:

civil engineer:

consultant:

Griffin Residence

7655 Lilly Lake Rd. Burlington, WI 53105

status:
Not For Construction

sheet number: 3 of 35

sheet revisions:

key plan:

Rennovation Drawings V5

No. Date Description

project number: **PG-2023-001**


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RENOVATION DRAWINGS **LOT COVERAGE SUMMARY** 'HOMESITE' LOT AREA: 9,385.47 SF (TRAINGLE ONLY) BUILDABLE 'ENVELOPE' AREA: 7,524.97 SF **IRON BAR SET** (SETBACK) BUILDING FOOTPRINT: 1,775.33 SF (AT SECOND LEVEL) EXISTING MAJOR CONTOURS ENCLOSED BUILDING AREA: 2,118 SF SIDEYARD SETBACK NEW MAJOR CONTOURS structural engineer: **UNDERGROUND UTILITY LEGEND NEW MINOR CONTOURS** UNDERGROUND ELECTRICAL ______ BUILDING FOOTPRIN UNDERGROUND WATER ----civil engineer: UNDERGROUND GAS UNDERGROUND DATA/TELEPHONE — - - - - - - -ASPHALT DRIVE UTILITY POLE WITH 783' consultant: BOXES FOR ELECTRICAL AND TELEPHONE LINES 782' 28' - 3 1/2" CURRENT BUILDABLE AREA FOR ANCILLARY STRUCTURE WITH 5' SETBACK FROM PRIMARY STRUCTURE 00. WITHOUT VARIANCE CURRENT PRIMARY STRUCTURE 779' SITS WITHIN 2' OF PROPERTLY LINE AT STREET-SIDE 23 778' 75' OHWM SETBACK CONC. RETAINING WALL LAKE ELEVATION 757.80' project name: RECORD BUILDING CONCRETE project number: 773' NO. 7665 PG-2023-001 775' seal & signature: 774' FRAME BUILDING 772' NO. 7655 773' WOOD DECK WOOD DECK HOLDING TANKS LEVEL 2 CANTILEVER OVER CONCRETE PATIO BRICK RETAINING WALL sheet number: 4 of 35 CONCRETE PATIO sheet revisions: BRICK RETAINING WALL GRASS TERRACE key plan: - BRICK RETAINING WALL RECORD = 152.00' MEASURE = 152.02' 20' IRON PIPE FOUND ORDINARY HIGH WATER MARK ELEVATION = 757.80' IRON PIPE FOUND ON LINE TO SW & 0.26' SW'ly OF CORNER ANOTHER PIPE IS 5.4' W'ly APPROXIMATE WATER LINE 11/03/2005 ELEVATION = 754.7' 1 Existing - Site Plan - Englarged 1/8" = 1'-0"

Robert & Sally Griffin 2712 N Magnolia Ave, Chicago, IL 60614

> architectural designer: Patrick Griffin 2712 N Magnolia Ave, Chicago, IL 60614

Griffin Residence 7655 Lilly Lake Rd. Burlington, WI 53105

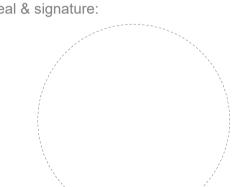

Not For Construction

Rennovation Drawings V5


No. Date Description

Existing Site Plan

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Robert & Sally Griffin 2712 N Magnolia Ave, Chicago, IL 60614

> architectural designer: Patrick Griffin 2712 N Magnolia Ave, Chicago, IL 60614

structural engineer:

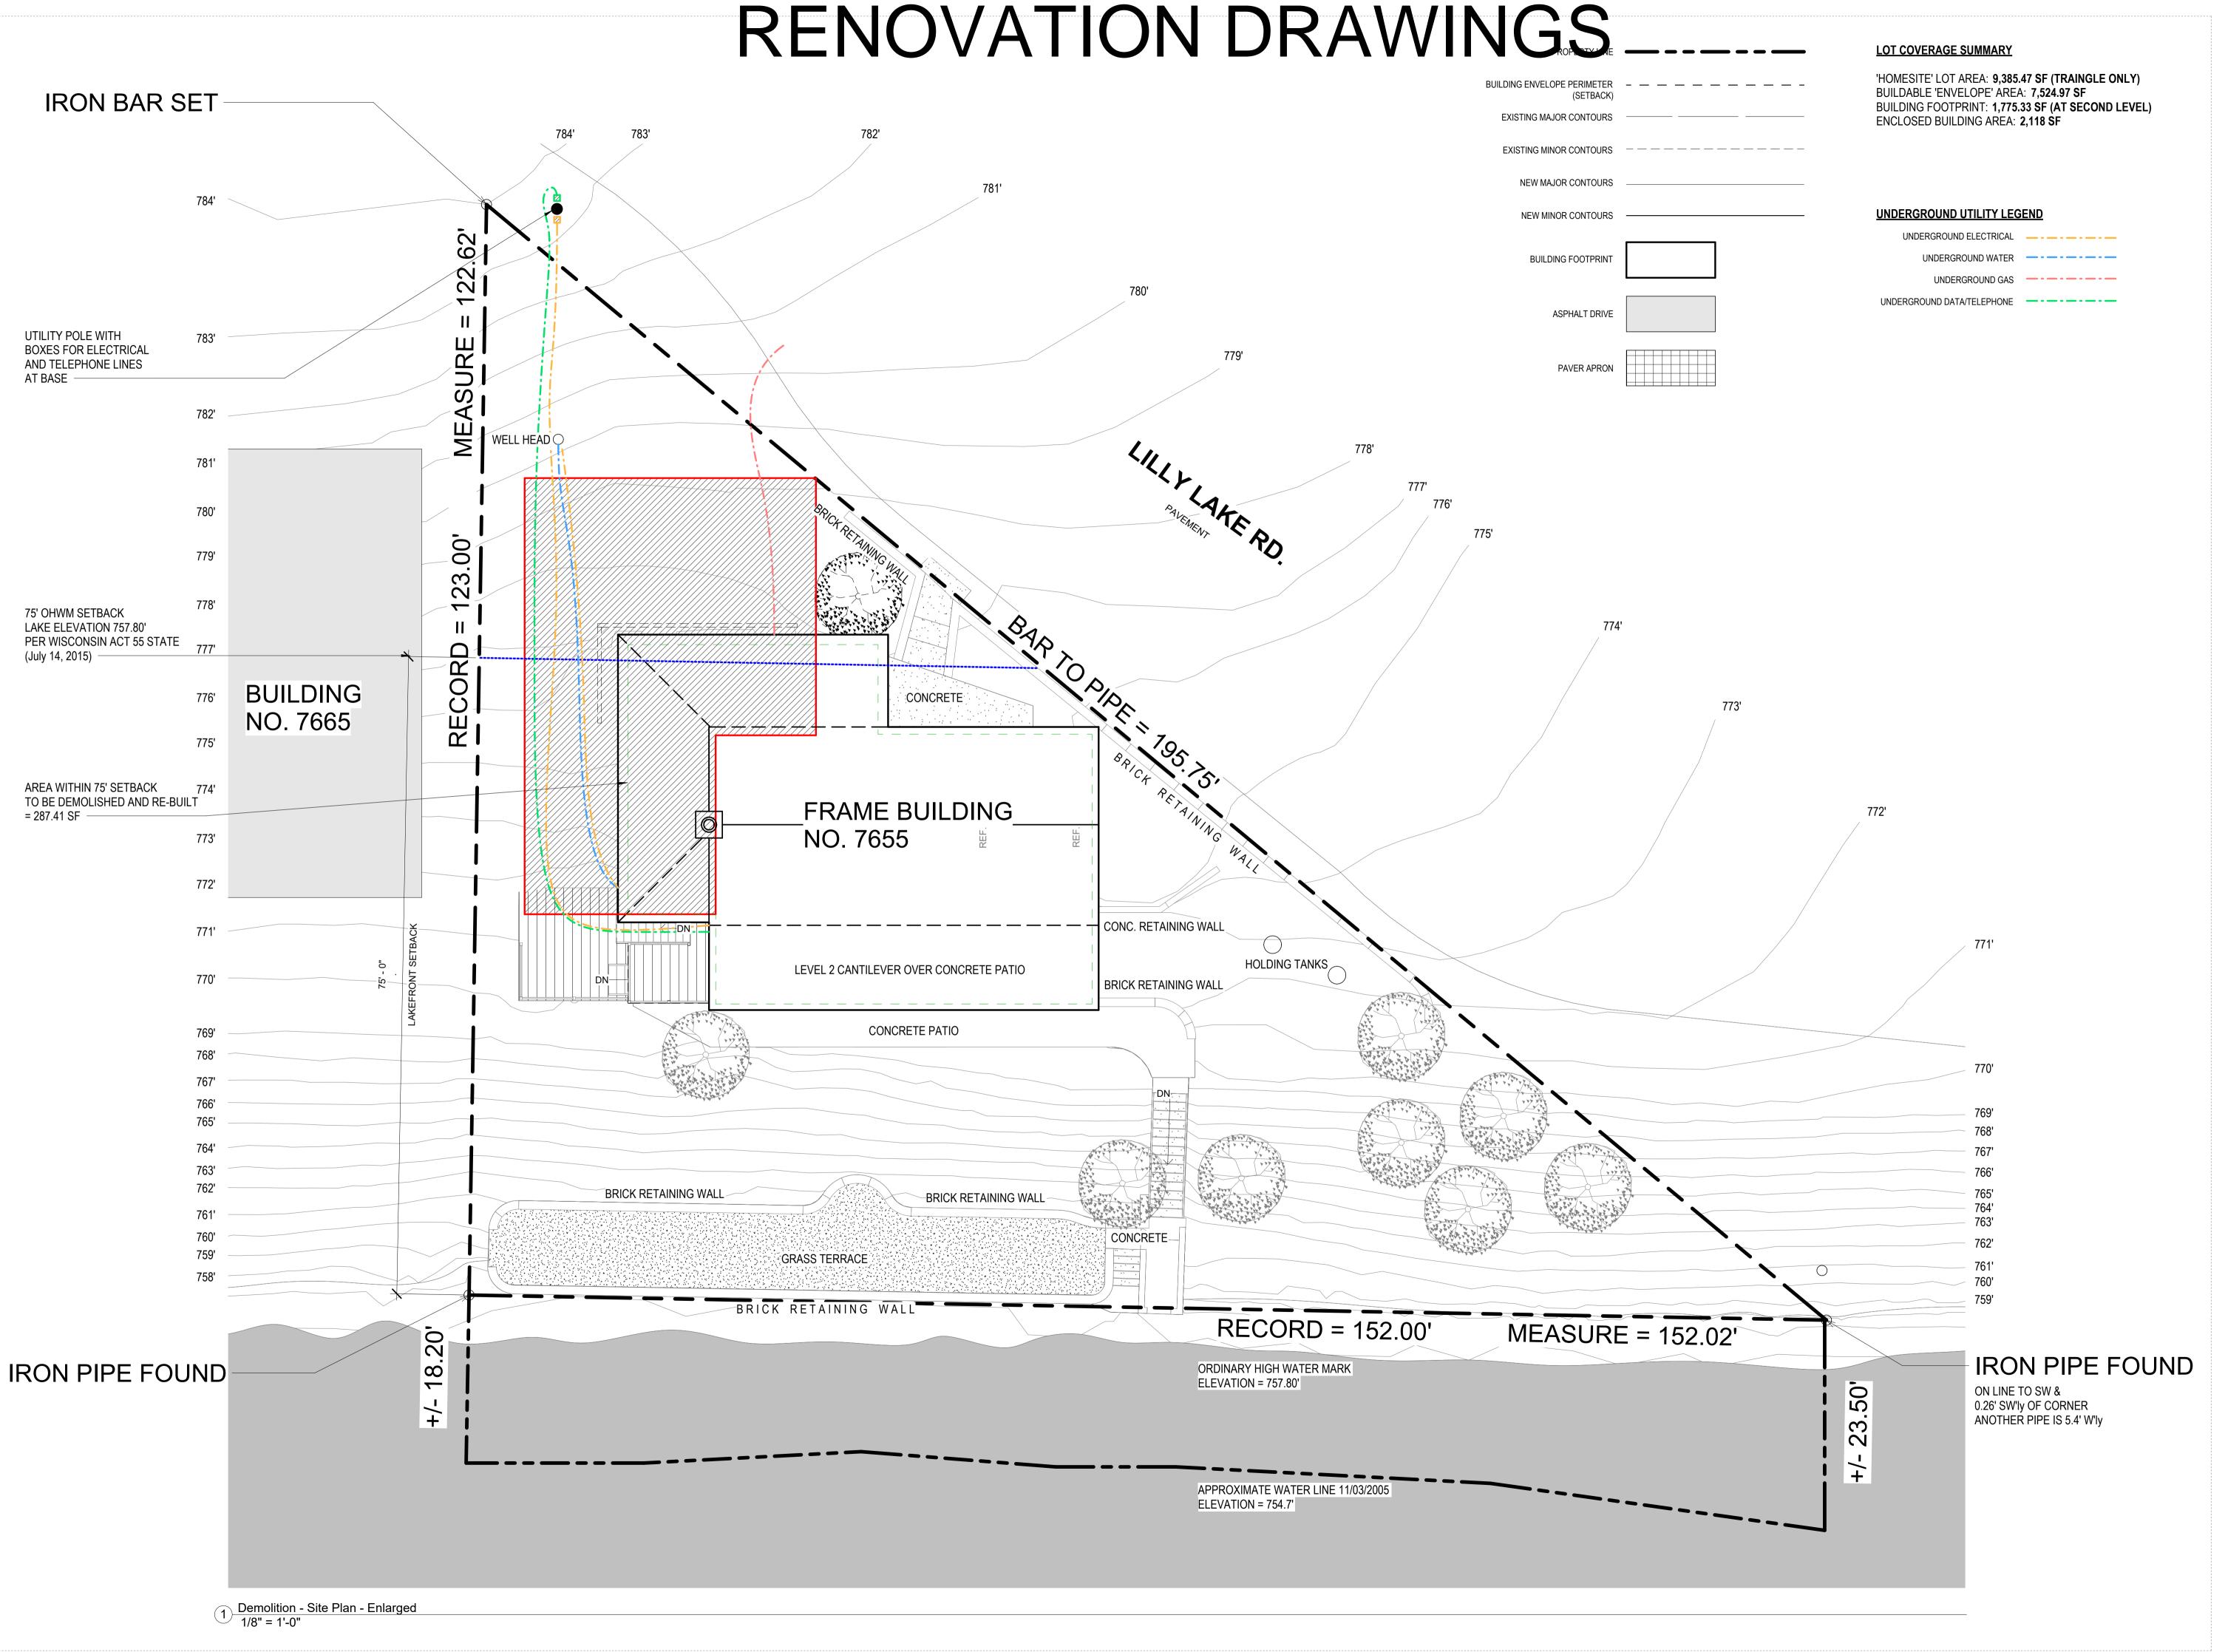
civil engineer:

consultant:

project name:

Griffin Residence 7655 Lilly Lake Rd. Burlington, WI 53105

project number: PG-2023-001

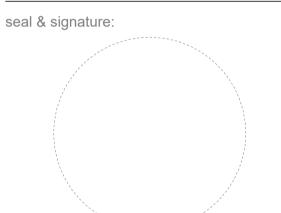

Not For Construction

Rennovation Drawings V5

sheet number: 5 of 35

sheet revisions:

No. Date Description

key plan:

Demolition Site Plan

Patrick G 1/8" = 1'-0" 24 in × 36 in

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RENOVATION DRAWINGS **LOT COVERAGE SUMMARY IRON BAR SET** 'HOMESITE' LOT AREA: 9,385.47 SF (TRAINGLE ONLY) BUILDABLE 'ENVELOPE' AREA: 7,524.97 SF BUILDING FOOTPRINT: 1,775.33 SF (AT SECOND LEVEL) **EXISTING MAJOR CONTOURS** ENCLOSED BUILDING AREA: 2,118 SF **NEW MAJOR CONTOURS UNDERGROUND UTILITY LEGEND** NEW MINOR CONTOURS 122. UNDERGROUND ELECTRICAL **BUILDING FOOTPRINT** UNDERGROUND WATER — - - - - - -ASURE ___ UNDERGROUND DATA/TELEPHONE -----ASPHALT DRIVE 779' PAVER APRON WELL HEAD 20' - 10 1/2" PROPOSED VARIANCE TO 5'-0" SETBACK IN SIDEYARD 780' 23.00' 779' 778' _ 75' OHWM SETBACK LAKE ELEVATION 757.80' PER WISCONSIN ACT 55 STATE 777' RECORD BUILDING CONCRETE NO. 7665 LATERAL EXPANSION OF PRIMARY STRUCTURE WITHIN FRAME BUILDING 75' SETBACK FROM OHWM (+200.00 SF) NO. 7655 773' 772' CONC. RETAINING WALL UPPER WOOD DECK WOOD DECK HOLDING TANKS LEVEL 2 CANTILEVER OVER CONCRETE PATIO 770' BRICK RETAINING WALL LATERAL EXPANSION CONCRETE PATIO 42' - 4 1/2" BRICK RETAINING WALL BRICK RETAINING WALL CONCRETE **GRASS TERRACE** BRICK RETAINING WALL RECORD = 152.00'MEASURE = 152.02' 20, IRON PIPE FOUND ORDINARY HIGH WATER MARK ELEVATION = 757.80' IRON PIPE FOUND 18 ON LINE TO SW & 0.26' SW'ly OF CORNER ANOTHER PIPE IS 5.4' W'ly APPROXIMATE WATER LINE 11/03/2005 ELEVATION = 754.7' Proposed - Site Plan - Englarged Copy 1 1/8" = 1'-0"

Robert & Sally Griffin 2712 N Magnolia Ave, Chicago, IL 60614

architectural designer: Patrick Griffin 2712 N Magnolia Ave, Chicago, IL 60614

structural engineer:


civil engineer:

consultant:

project name:

Griffin Residence 7655 Lilly Lake Rd. Burlington, WI 53105 project number:

PG-2023-001

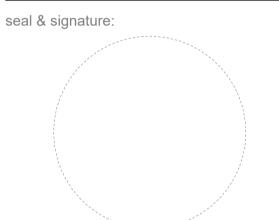

Not For Construction

Rennovation Drawings V5

sheet number: 6 of 35

sheet revisions:


No. Date Description

key plan:


Rennovated Site Plan

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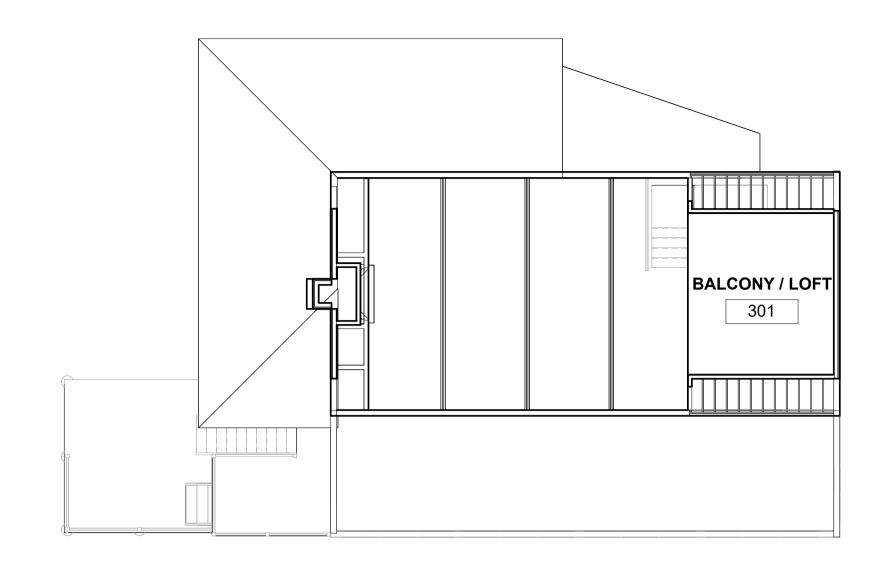
Do not scale. Check all dimensions on site.

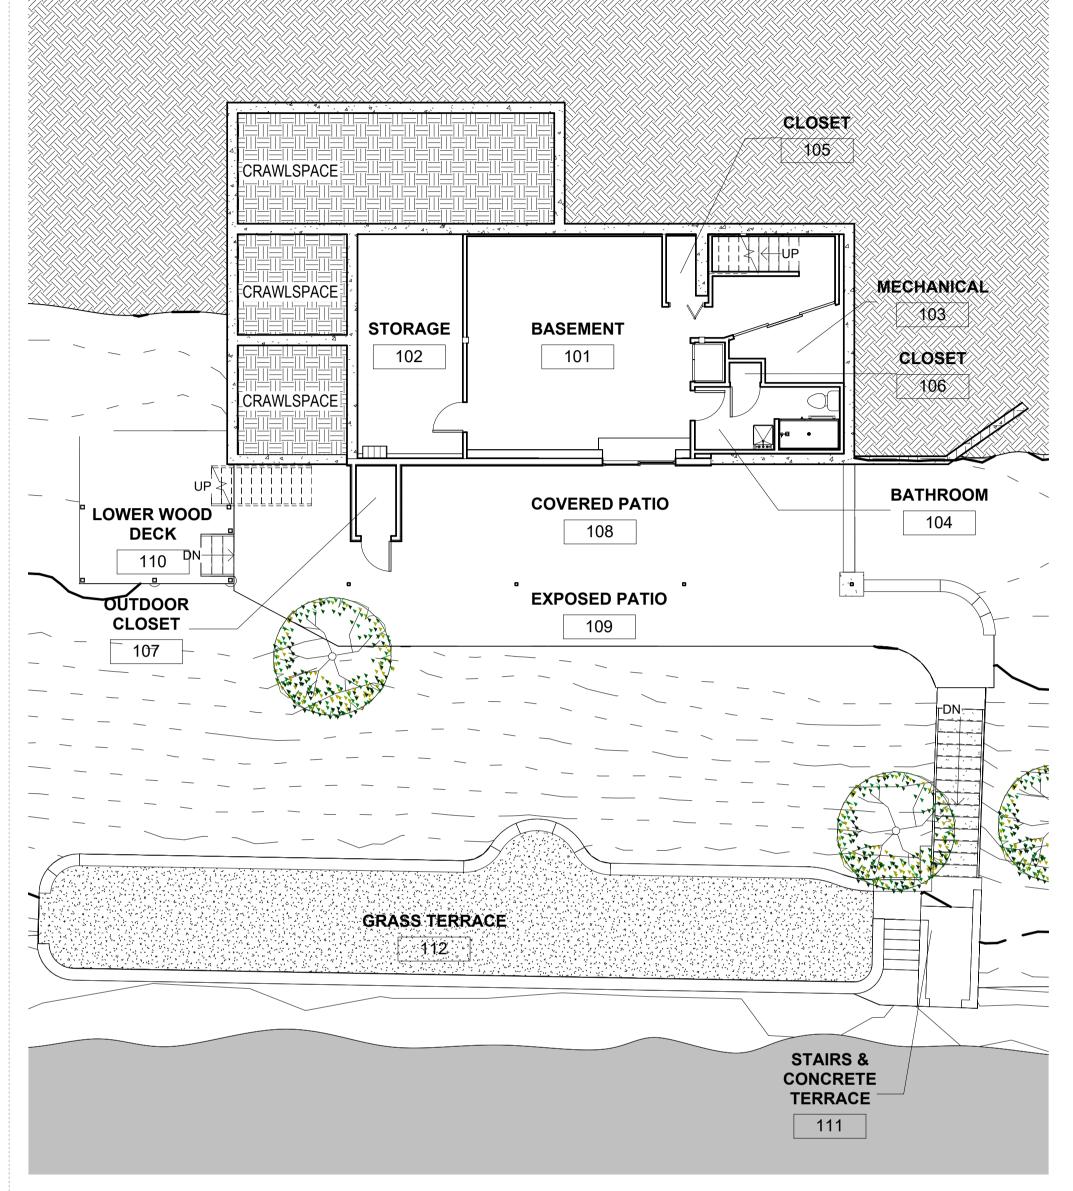

1 Existing - L01 - Basement Room Plan 1/8" = 1'-0"

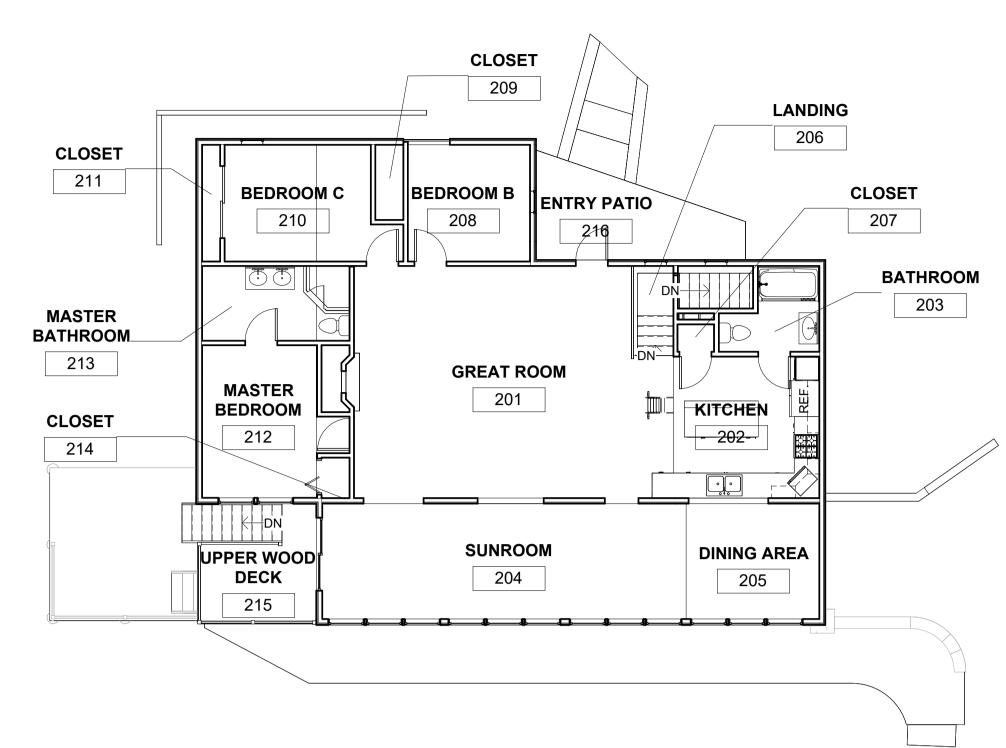

2 Existing - L02 - Main Floor Room Plan 1/8" = 1'-0"



3 Existing - L03 - Balcony Room Plan 1/8" = 1'-0"

EXTERIOR AREA SCHEDULE

NAME	NUMBER	AREA	PERIMETER	NOTES
OUTDOOR CLOSET	107	19 SF	18' - 4"	(BELOW OR ABOVE OTHER)
COVERED PATIO	108	386 SF	105' - 6"	(BELOW OR ABOVE OTHER)
UPPER WOOD DECK	215	100 SF	42' - 0"	(BELOW OR ABOVE OTHER)
(BELOW OR ABOVE OTHER): 3		506 SF		
EXPOSED PATIO	109	393 SF	162' - 9"	IMPERVIOUS SURFACE
LOWER WOOD DECK	110	159 SF	50' - 3"	IMPERVIOUS SURFACE
STAIRS & CONCRETE TERRACE	111	157 SF	73' - 11"	IMPERVIOUS SURFACE
ENTRY PATIO	216	148 SF	66' - 5"	IMPERVIOUS SURFACE
IMPERVIOUS SURFACE: 4		857 SF		
GRASS TERRACE	112	747 SF	158' - 0"	PURVEOUS SURFACE
PURVEOUS SURFACE: 1		747 SF		
GRAND TOTAL: 8		2109 SF		

LOT SURFACE COVERAGE

'HOMESITE' LOT AREA: 9,385.47 SF (TRAINGLE ONLY) BUILDABLE 'ENVELOPE' AREA: 7,524.97 SF

MAX. UMITIGATED IMPERVIOUS SURFACE AREA: (9,385.47x0.30) = 2,815.5 SF MAX. MITIGATED IMPERVIOUS SURFACE AREA: (9,384.47x0.40) = 3754.1 SF

EXISTING BUILDING FOOTPRINT: 1,775.33 SF (AT SECOND LEVEL) EXISTING IMPERVIOUS SURFACE AREA: 857 SF (OUTSIDE OF BUILDING FOOTPRINT) EXISTING RETAINING WALL SURFACE AREA: 270 SF

GRAND TOTAL IMPERVIOUS SURFACES: 2901 SF

ROOM SCHEDULE

NAME	NUMBER	AREA	PERIMETER	NOTES
BASEMENT	101	393 SF	125' - 10"	
STORAGE	102	160 SF	54' - 1"	
MECHANICAL	103	43 SF	29' - 10"	
BATHROOM	104	62 SF	39' - 9"	
CLOSET	105	14 SF	18' - 3"	
CLOSET	106	4 SF	8' - 7"	
L01 - Basement: 6		677 SF		
GREAT ROOM	201	485 SF	94' - 7"	
KITCHEN	202	147 SF	51' - 4"	
BATHROOM	203	47 SF	31' - 0"	
SUNROOM	204	291 SF	79' - 9"	
DINING AREA	205	106 SF	41' - 5"	
LANDING	206	26 SF	21' - 11"	
CLOSET	207	7 SF	10' - 8"	
BEDROOM B	208	Not Enclosed	Not Enclosed	
CLOSET	209	15 SF	17' - 2"	
BEDROOM C	210	126 SF	49' - 2"	
CLOSET	211	15 SF	22' - 5"	
MASTER BEDROOM	212	130 SF	49' - 11"	
MASTER BATHROOM	213	76 SF	37' - 0"	
CLOSET	214	8 SF	11' - 5"	
L02 - Main Floor: 14		1478 SF		
BALCONY / LOFT	301	163 SF	51' - 2"	
L03 - Upper Floor: 1	,	163 SF		
GRAND TOTAL: 21		2319 SF		

Robert & Sally Griffin 2712 N Magnolia Ave, Chicago, IL 60614 architectural designer: Patrick Griffin

2712 N Magnolia Ave, Chicago, IL 60614

civil engineer:


structural engineer:

consultant:

project name:

Griffin Residence 7655 Lilly Lake Rd. Burlington, WI 53105

project number: PG-2023-001

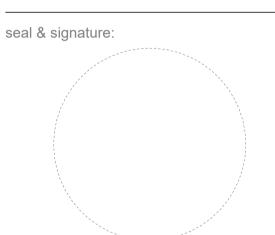

Not For Construction

Rennovation Drawings V5

sheet number: 7 of 35

sheet revisions:

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Description

sheet title:


key plan:

Existing Area Calculations


Patrick G 1/8" = 1'-0" 24 in × 36 in 12/19/2023 12:52:07 PM

Do not scale. Check all dimensions on site.

A-002.01

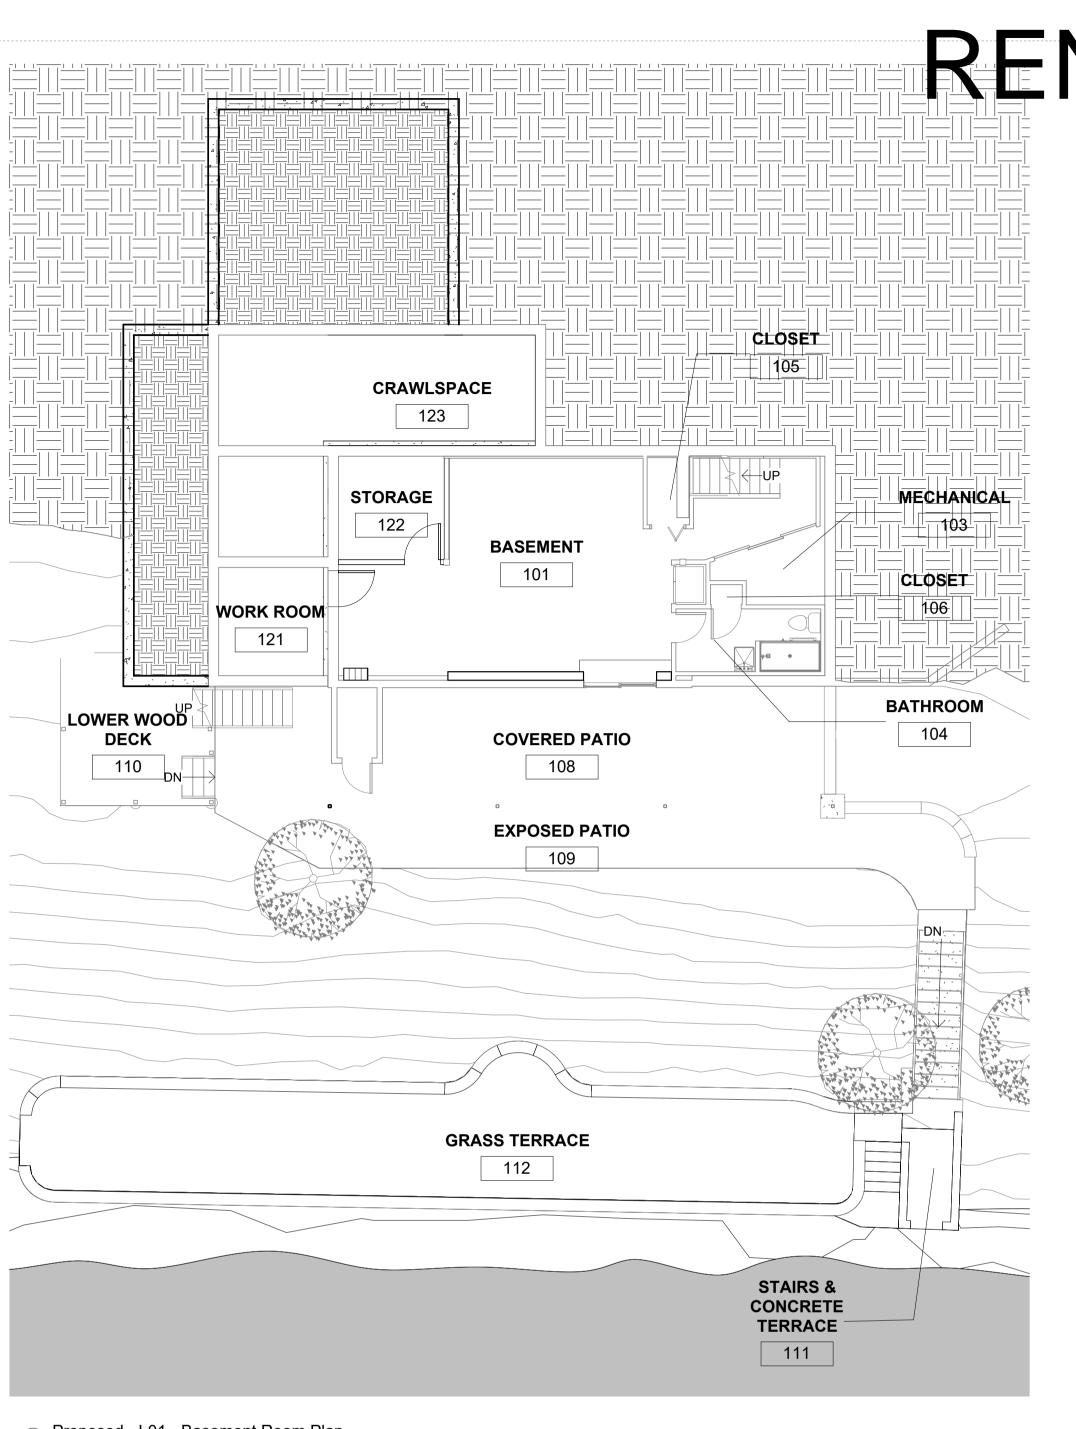

1 Proposed - L01 - Basement Room Plan 1/8" = 1'-0"

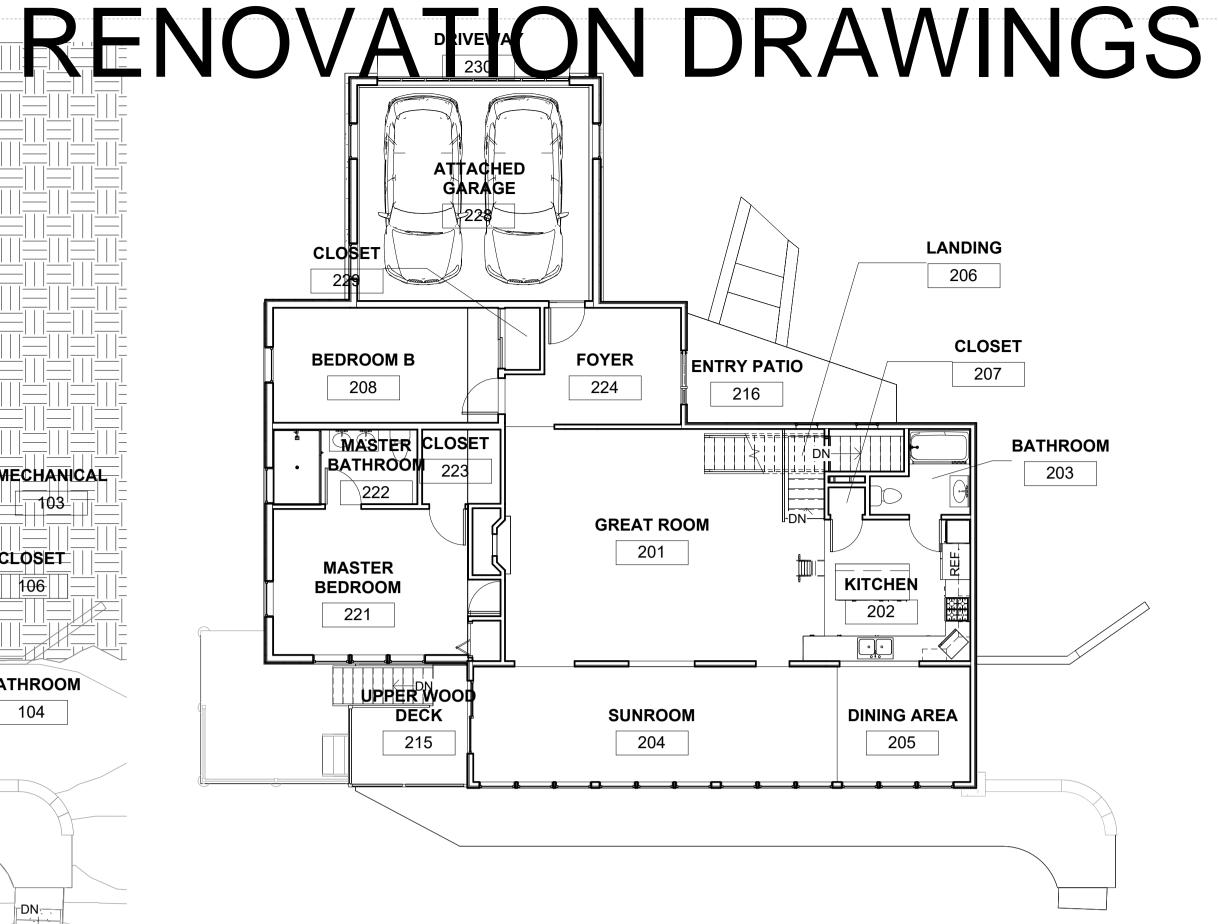

Proposed - L02 - Main Floor Room Plan
1/8" = 1'-0"

BALCONY/LOFT BEDROOM E 301 302 CLOSET E 304 BEDROOM F CLOSET F 303 305

3 Proposed - L03 - Balcony Room Plan 1/8" = 1'-0"

EXTERIOR AREA SCHEDULE (RENOVATED)

		'	\	
NAME	NUMBER	AREA	PERIMETER	NOTES
COVERED PATIO	108	386 SF	105' - 6"	(BELOW OR ABOVE OTHER)
UPPER WOOD DECK	215	74 SF	39' - 8"	(BELOW OR ABOVE OTHER)
(BELOW OR ABOVE OTHER): 2		459 SF		
EXPOSED PATIO	109	393 SF	162' - 9"	IMPERVIOUS SURFACE
LOWER WOOD DECK	110	124 SF	45' - 0"	IMPERVIOUS SURFACE
STAIRS & CONCRETE TERRACE	111	157 SF	73' - 11"	IMPERVIOUS SURFACE
ENTRY PATIO	216	148 SF	66' - 5"	IMPERVIOUS SURFACE
IMPERVIOUS SURFACE: 4		822 SF		
GRASS TERRACE	112	747 SF	158' - 0"	PURVEOUS SURFACE
DRIVEWAY	230	314 SF	70' - 8"	PURVEOUS SURFACE
PURVEOUS SURFACE: 2		1061 SF		
GRAND TOTAL: 8		2343 SF		

LOT SURFACE COVERAGE

'HOMESITE' LOT AREA: 9,385.47 SF (TRAINGLE ONLY)
BUILDABLE 'ENVELOPE' AREA: 7,524.97 SF

MAX. UMITIGATED IMPERVIOUS SURFACE AREA: (9,385.47x0.30) = 2,815.5 SF MAX. MITIGATED IMPERVIOUS SURFACE AREA: (9,384.47x0.40) = 3754.1 SF

RENOVATED BUILDING FOOTPRINT: 2371.25 SF (AT SECOND LEVEL)
RENOVATED IMPERVIOUS SURFACE AREA: 849 SF (OUTSIDE OF BUILDING FOOTPRINT)
EXISTING RETAINING WALL SURFACE AREA: 270 SF

GRAND TOTAL IMPERVIOUS SURFACES: 3485 SF

WATER MITIGATION REQUIREMENT: 670

ROOM SCHEDULE (RENOVATED)

BASEMENT	101	476 SF	144' - 9"	
MECHANICAL	103	43 SF	29' - 10"	
BATHROOM	104	62 SF	39' - 9"	
CLOSET	105	14 SF	18' - 3"	
CLOSET	106	4 SF	8' - 7"	
WORK ROOM	121	83 SF	36' - 10"	NEW
STORAGE	122	76 SF	34' - 10"	NEW
L01 - Basement: 7		759 SF		
GREAT ROOM	201	486 SF	95' - 0"	
KITCHEN	202	147 SF	51' - 4"	
BATHROOM	203	47 SF	31' - 0"	
SUNROOM	204	291 SF	79' - 9"	
DINING AREA	205	106 SF	41' - 5"	
LANDING	206	26 SF	21' - 11"	
CLOSET	207	7 SF	10' - 8"	
BEDROOM B	208	179 SF	56' - 7"	
UPPER WOOD DECK	215	74 SF	39' - 8"	(BELOW OR ABOVE OTHER)
MASTER BEDROOM	221	205 SF	63' - 2"	NEW
MASTER BATHROOM	222	74 SF	36' - 5"	NEW
CLOSET	223	40 SF	25' - 5"	RENOVATION
FOYER	224	125 SF	49' - 1"	RENOVATION
ATTACHED GARAGE	228	352 SF	75' - 1"	NEW
CLOSET	229	15 SF	16' - 2"	NEW
L02 - Main Floor: 15		2174 SF		
BALCONY / LOFT	301	43 SF	30' - 3"	
BEDROOM E	302	74 SF	34' - 6"	NEW
BEDROOM F	303	73 SF	34' - 5"	NEW
CLOSET E	304	13 SF	19' - 2"	NEW
CLOSET F	305	13 SF	18' - 5"	NEW
L03 - Upper Floor: 5		216 SF		
GRAND TOTAL: 27		3149 SF		

client:
Robert & Sally Griffin
2712 N Magnolia Ave,
Chicago, IL 60614

architectural designer:
Patrick Griffin
2712 N Magnolia Ave,
Chicago, IL 60614

Patrick Griffin
2712 N Magnolia Ave,
Chicago, IL 60614

structural engineer:

civil engineer:

PG-2023-001	
eal & signature:	

Not For Construction

issuance:

NOTES

project name:

project number:

Griffin Residence 7655 Lilly Lake Rd. Burlington, WI 53105

Rennovation Drawings V5 sheet number:

8 of 35

No. Date

Description

key plan:

sheet title:

Rennovated Area Calculations

drawn by: Patrick G
scale: 1/8" = 1'-0"
size: 24 in × 36 in
date: 12/19/2023 12:52:09 PM

sheet number:

A-002.02

Do not scale. Check all dimensions on site.

RENOVATION DRAWINGS
7
6
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4
3
2 G \rightarrow (A) CRAWLSPACE TRUNCATED CONCRETE WALL 8' - 11 1/4" (B)NEW OPENING IN CONCRETE WALL EXPOSED **FOUNDATION** CRAWLSPACE ' - 10 1/2" 3' - 0" (C)6" RAISED **ELECTRICAL** LANDING BREAKER CRAWLSPACE **PANEL** 18" HIGH LEDGE TO HIDE FOUNDATION -7' - 0" 5' - 5 1/8" **COVERED PATIO** E **EXPOSED PATIO** F 1 Exisiting - L01 - Basement 1/4" = 1'-0"

Robert & Sally Griffin 2712 N Magnolia Ave, Chicago, IL 60614 architectural designer: Patrick Griffin 2712 N Magnolia Ave, Chicago, IL 60614 structural engineer: civil engineer: consultant: project name: Griffin Residence 7655 Lilly Lake Rd. Burlington, WI 53105 project number: PG-2023-001 seal & signature: **Not For Construction Rennovation Drawings V5** sheet number: 9 of 35 sheet revisions: No. Date Description

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key plan:

Level 1 Demolition Floor Plan

drawn by: Patrick G
scale: 1/4" = 1'-0"
size: 24 in × 36 in
date: 12/19/2023 12:52:11 PM

Do not scale. Check all dimensions on site.

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A-101.00

RENOVATION DRAWINGS 9 -(G)(A)19' - 5" 0' - 7" CRAWLSPACE ACCESS TO CRAWLSPACE (B)**STORAGE** 122 (122A) A-301.00 ELECTRICAL BREAKER WORK ROOM PANEL 121 (D)A-303.00 **COVERED PATIO** (E) EXPOSED PATIO 17' - 0 3/8"

1 Proposed - L01 - Basement 1/4" = 1'-0"

Robert & Sally Griffin 2712 N Magnolia Ave, Chicago, IL 60614 architectural designer:
Patrick Griffin 2712 N Magnolia Ave, Chicago, IL 60614 structural engineer: civil engineer: consultant: project name: Griffin Residence 7655 Lilly Lake Rd. Burlington, WI 53105 project number: PG-2023-001 seal & signature: **Not For Construction** Rennovation Drawings V5 sheet number: 10 of 35 sheet revisions: No. Date Description

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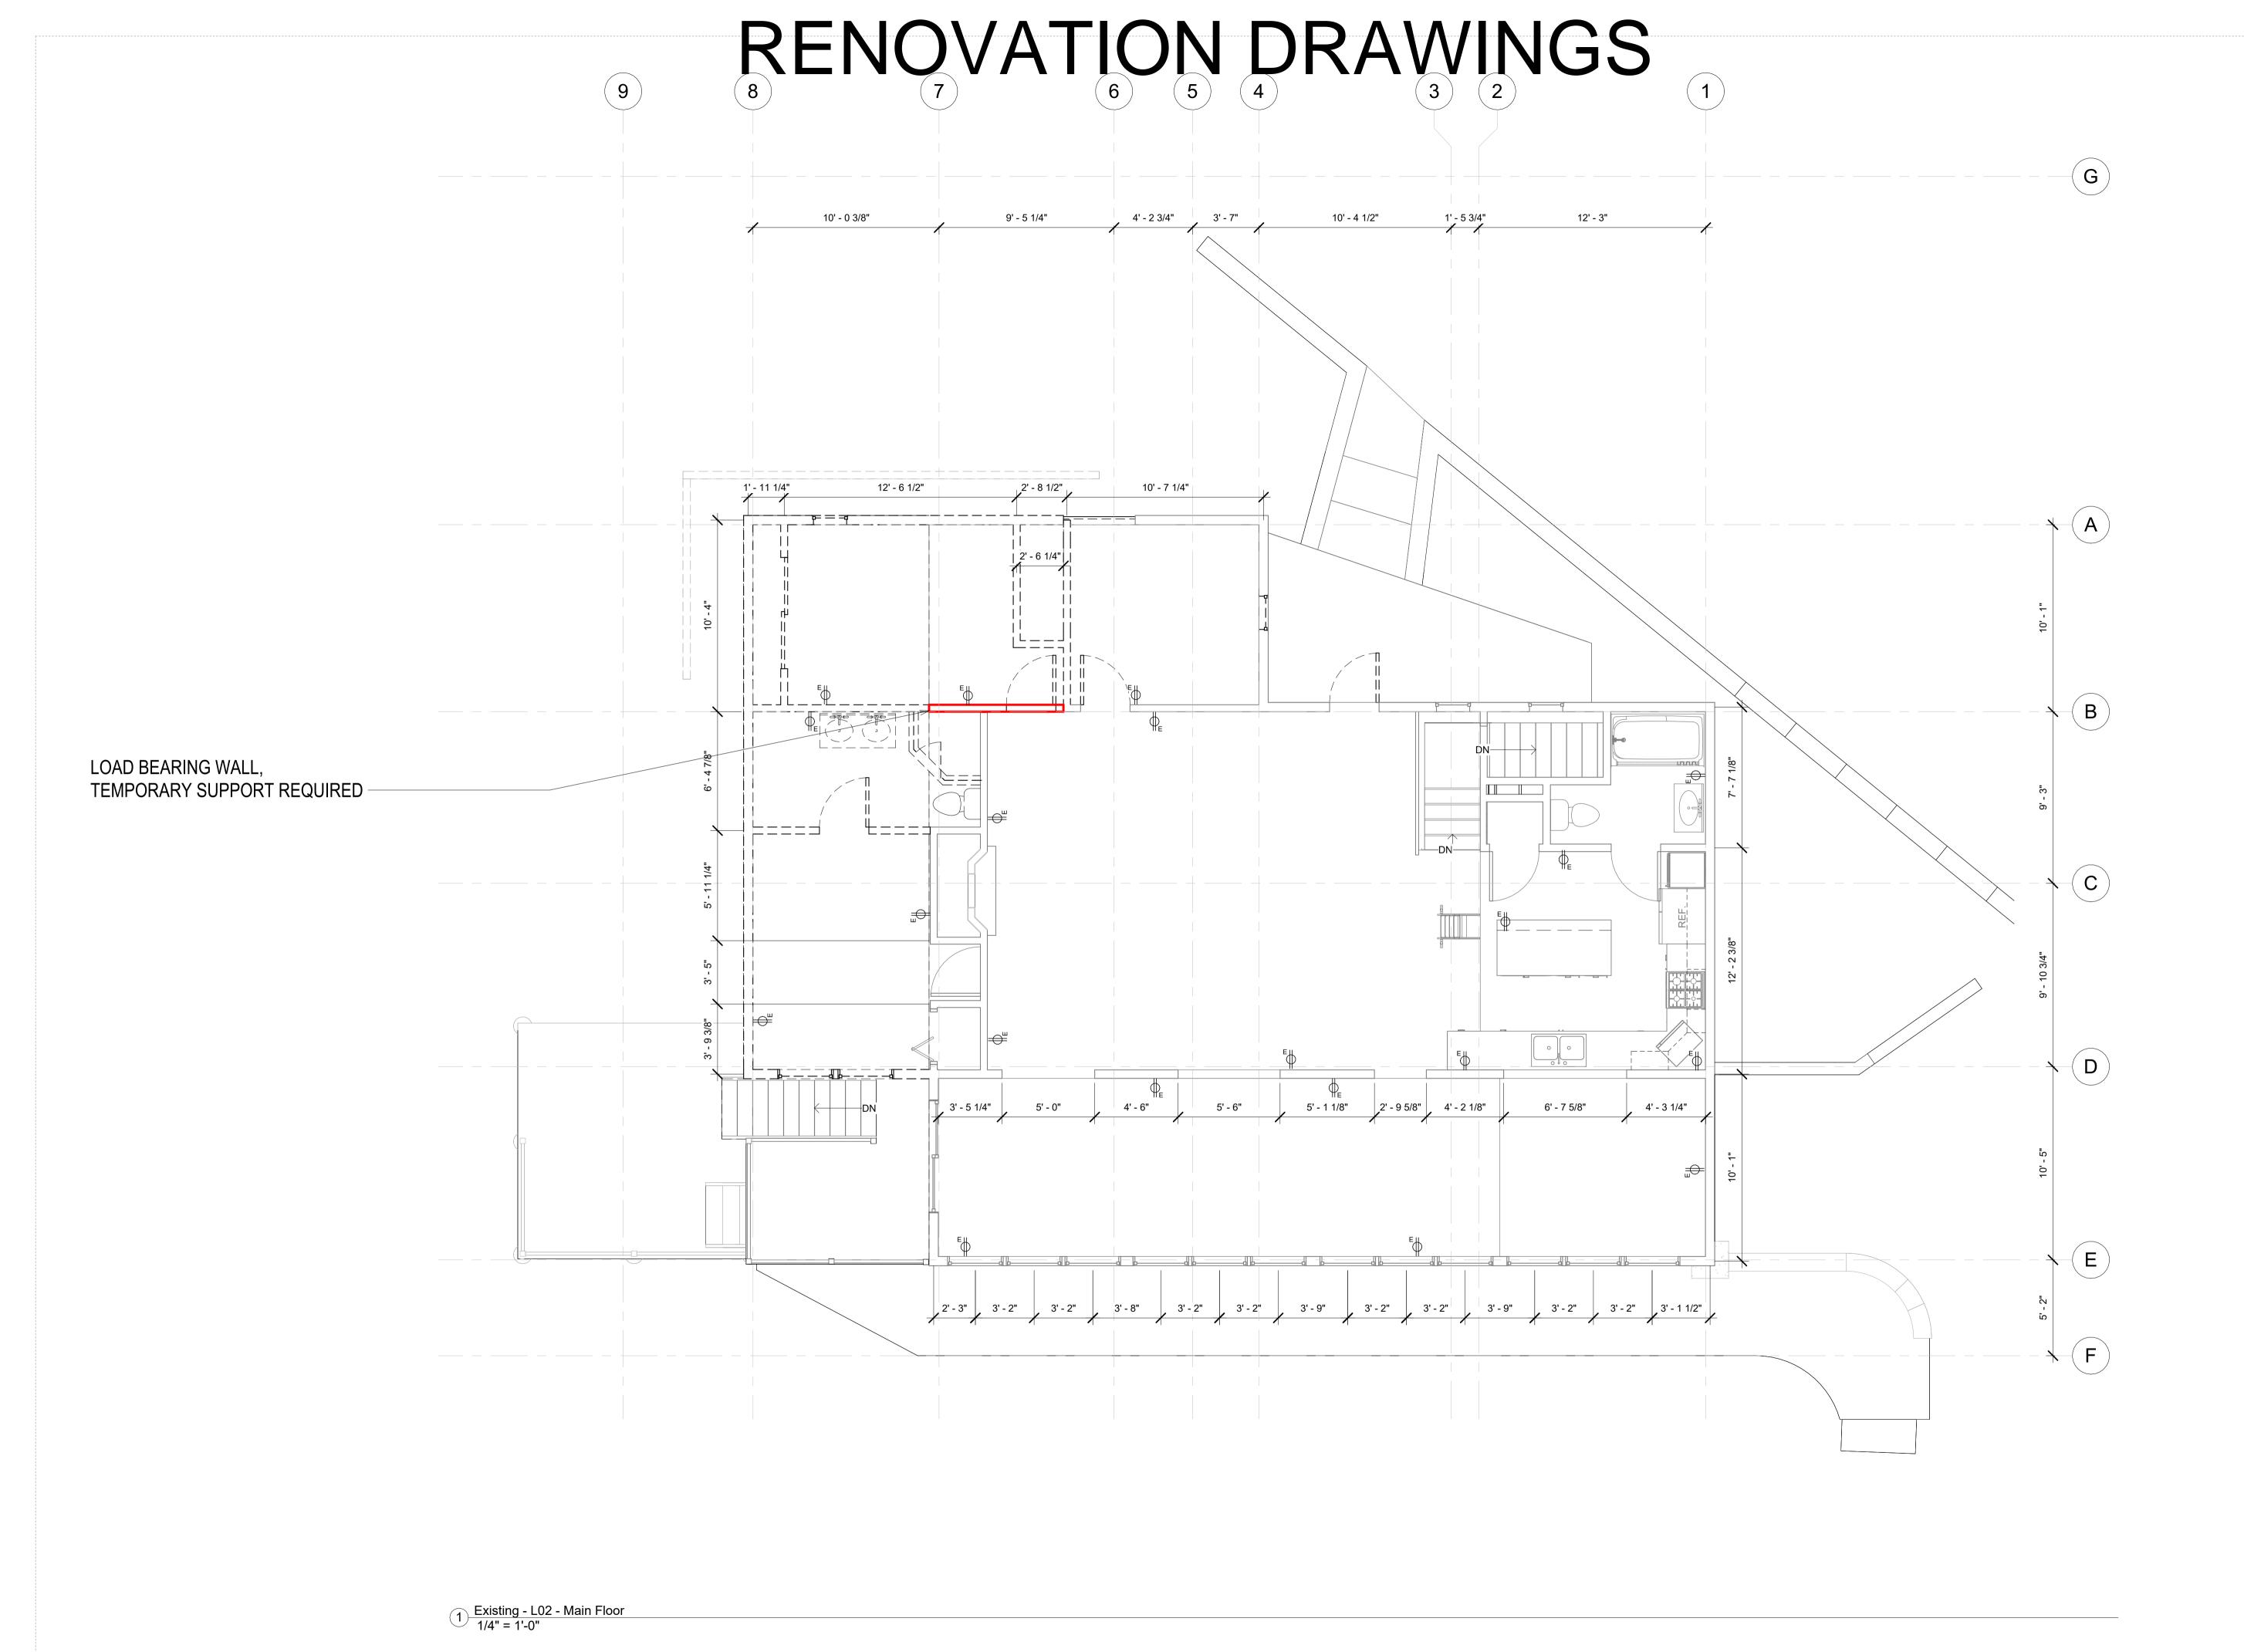
Level 1 Renovated Floor Plan

drawn by: Patrick G
scale: 1/4" = 1'-0"
size: 24 in × 36 in
date: 12/19/2023 12:52:13 PM

Do not scale. Check all dimensions on site.

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A-101.01



Robert & Sally Griffin 2712 N Magnolia Ave, Chicago, IL 60614 architectural designer:
Patrick Griffin 2712 N Magnolia Ave, Chicago, IL 60614 structural engineer: civil engineer: consultant: project name: Griffin Residence 7655 Lilly Lake Rd. Burlington, WI 53105 project number: PG-2023-001 seal & signature: **Not For Construction** Rennovation Drawings V5

11 of 35

sheet revisions:

sheet number:

No. Date Description


key plan:

Level 2 Demolition Floor Plan

Patrick G 1/4" = 1'-0" 24 in × 36 in

12/19/2023 12:52:14 PM Do not scale. Check all dimensions on site.

A-102.00

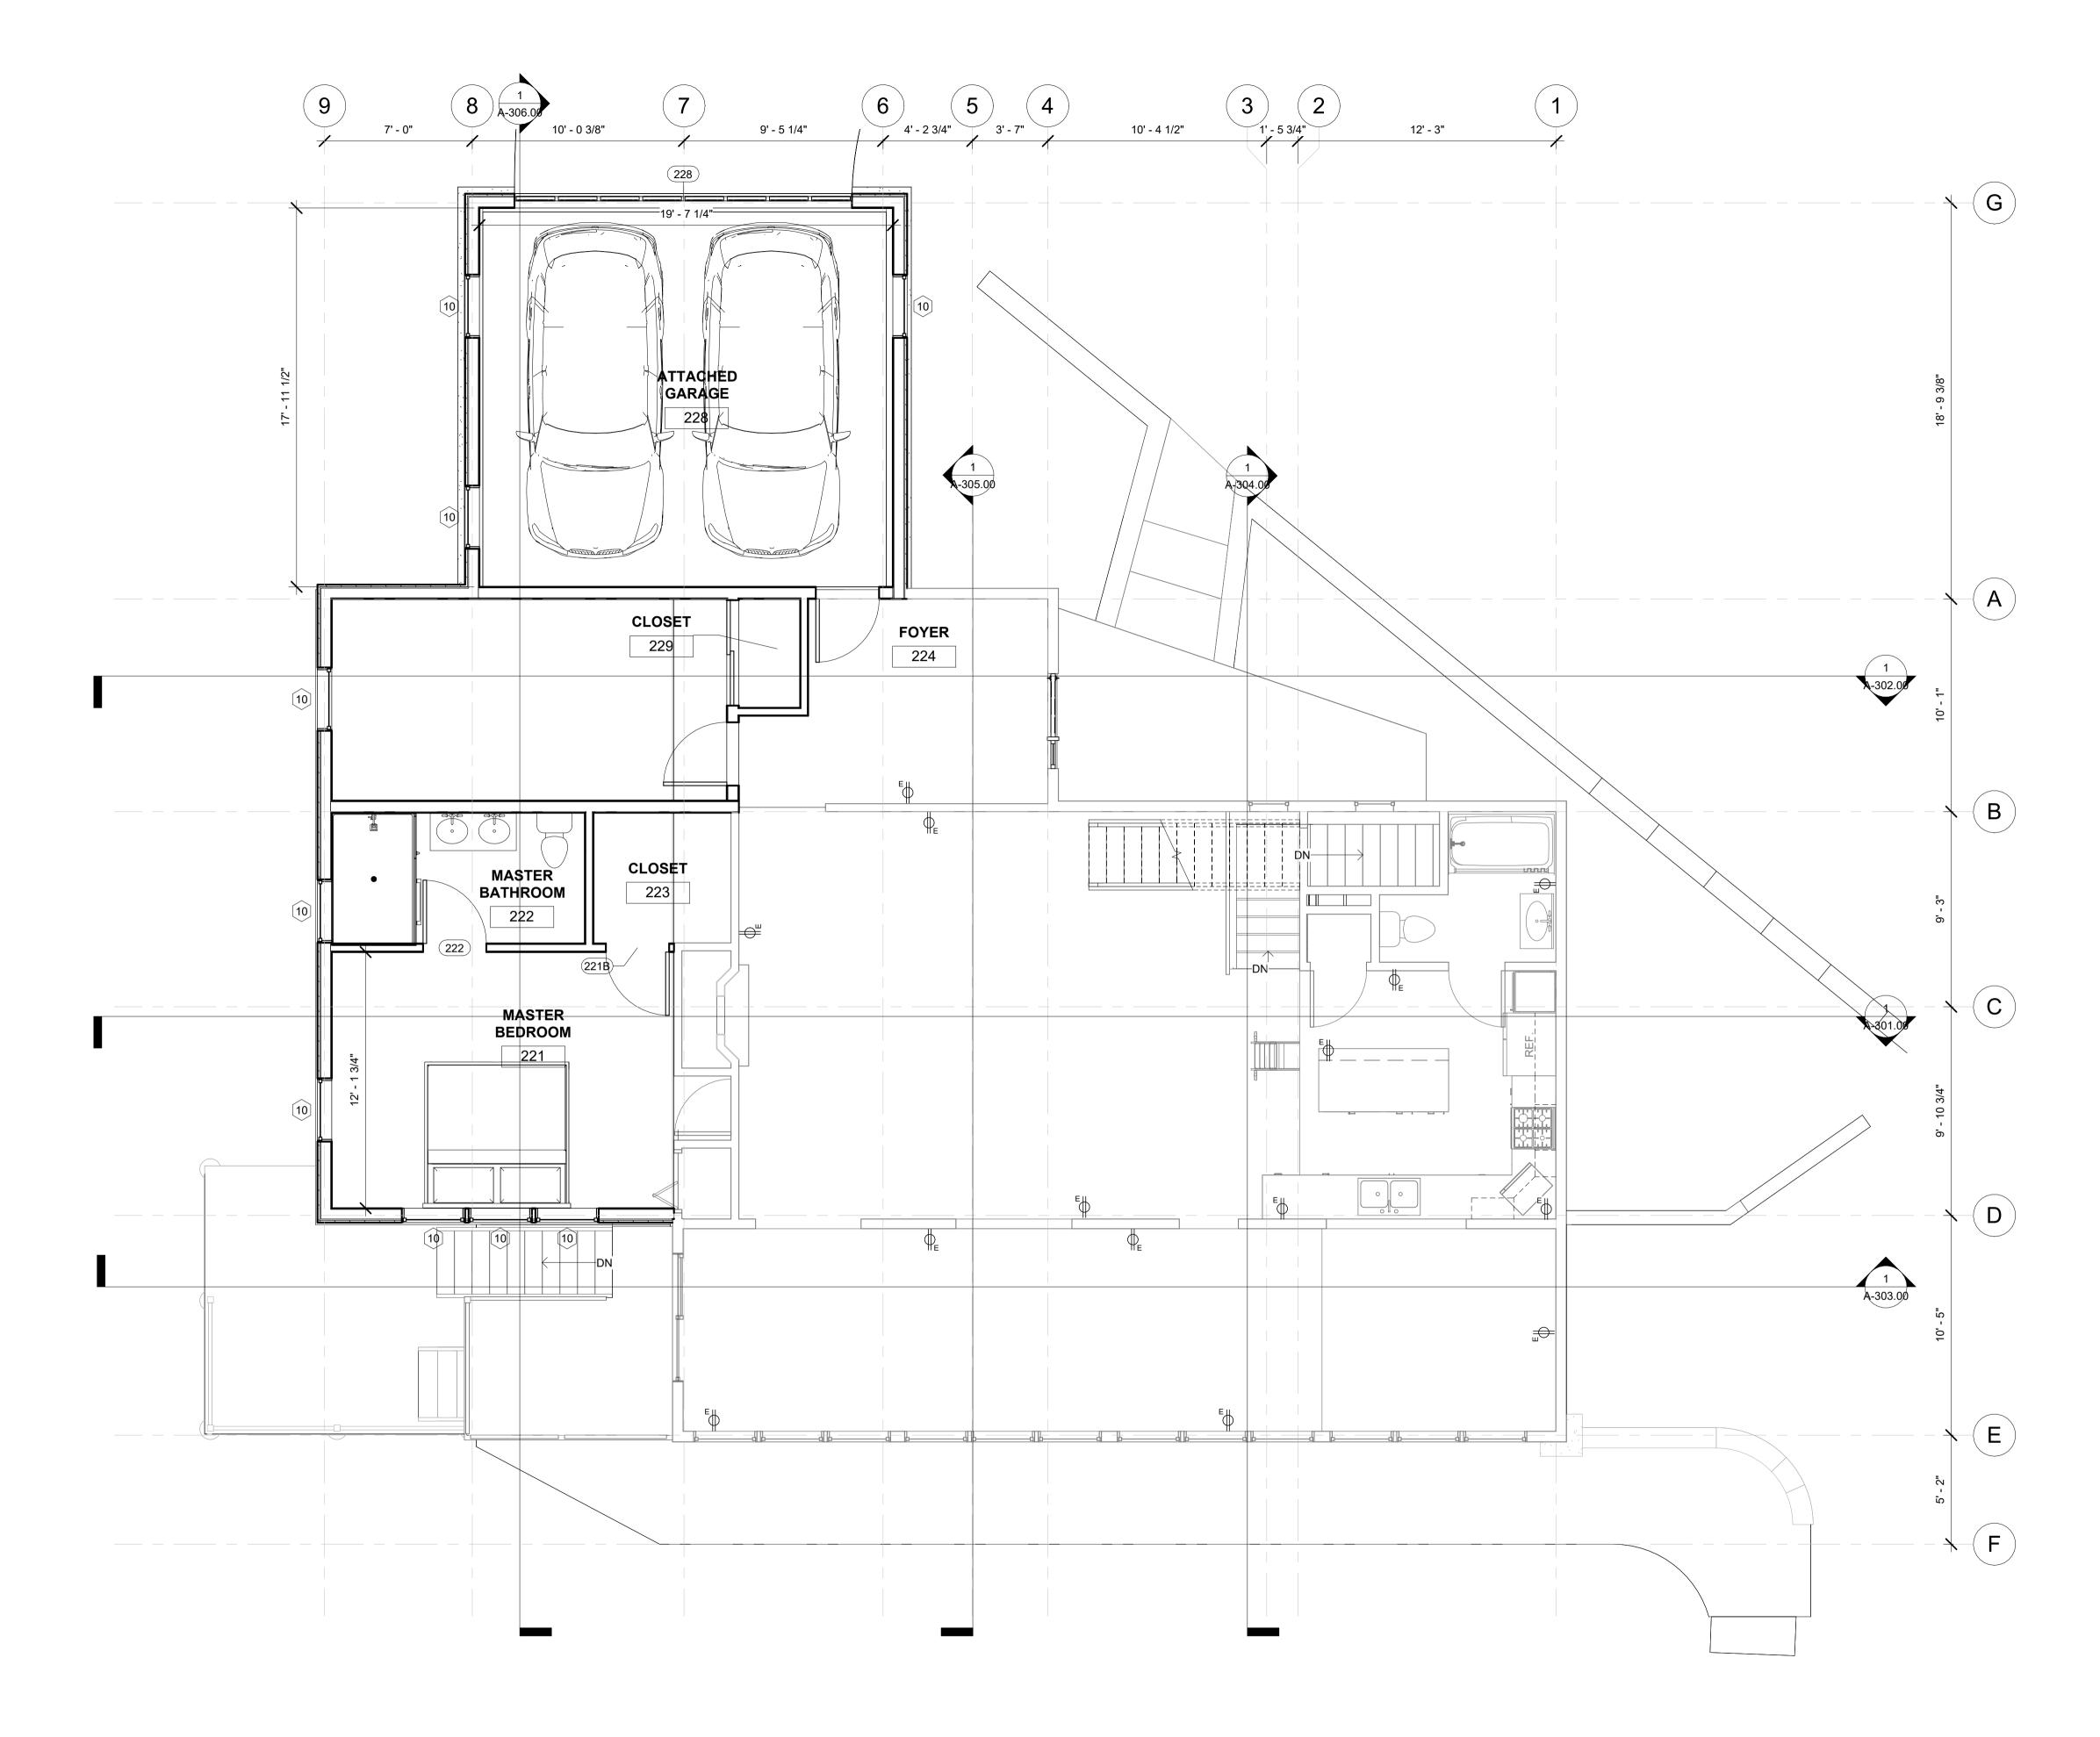

1 Proposed - L02 - Main Floor 1/4" = 1'-0"

Robert & Sally Griffin 2712 N Magnolia Ave, Chicago, IL 60614

architectural designer:
Patrick Griffin 2712 N Magnolia Ave, Chicago, IL 60614


structural engineer:

civil engineer:

consultant:

project name: Griffin Residence 7655 Lilly Lake Rd. Burlington, WI 53105

project number: PG-2023-001

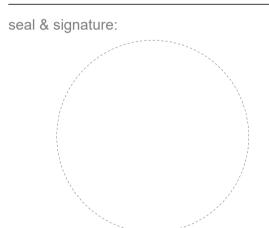

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Rennovation Drawings V5

No. Date Description

sheet number: 12 of 35

sheet revisions:


key plan:

Level 2 Renovated Floor Plan

Patrick G 1/4" = 1'-0" 24 in × 36 in 12/19/2023 12:52:17 PM

Do not scale. Check all dimensions on site.

A-102.01

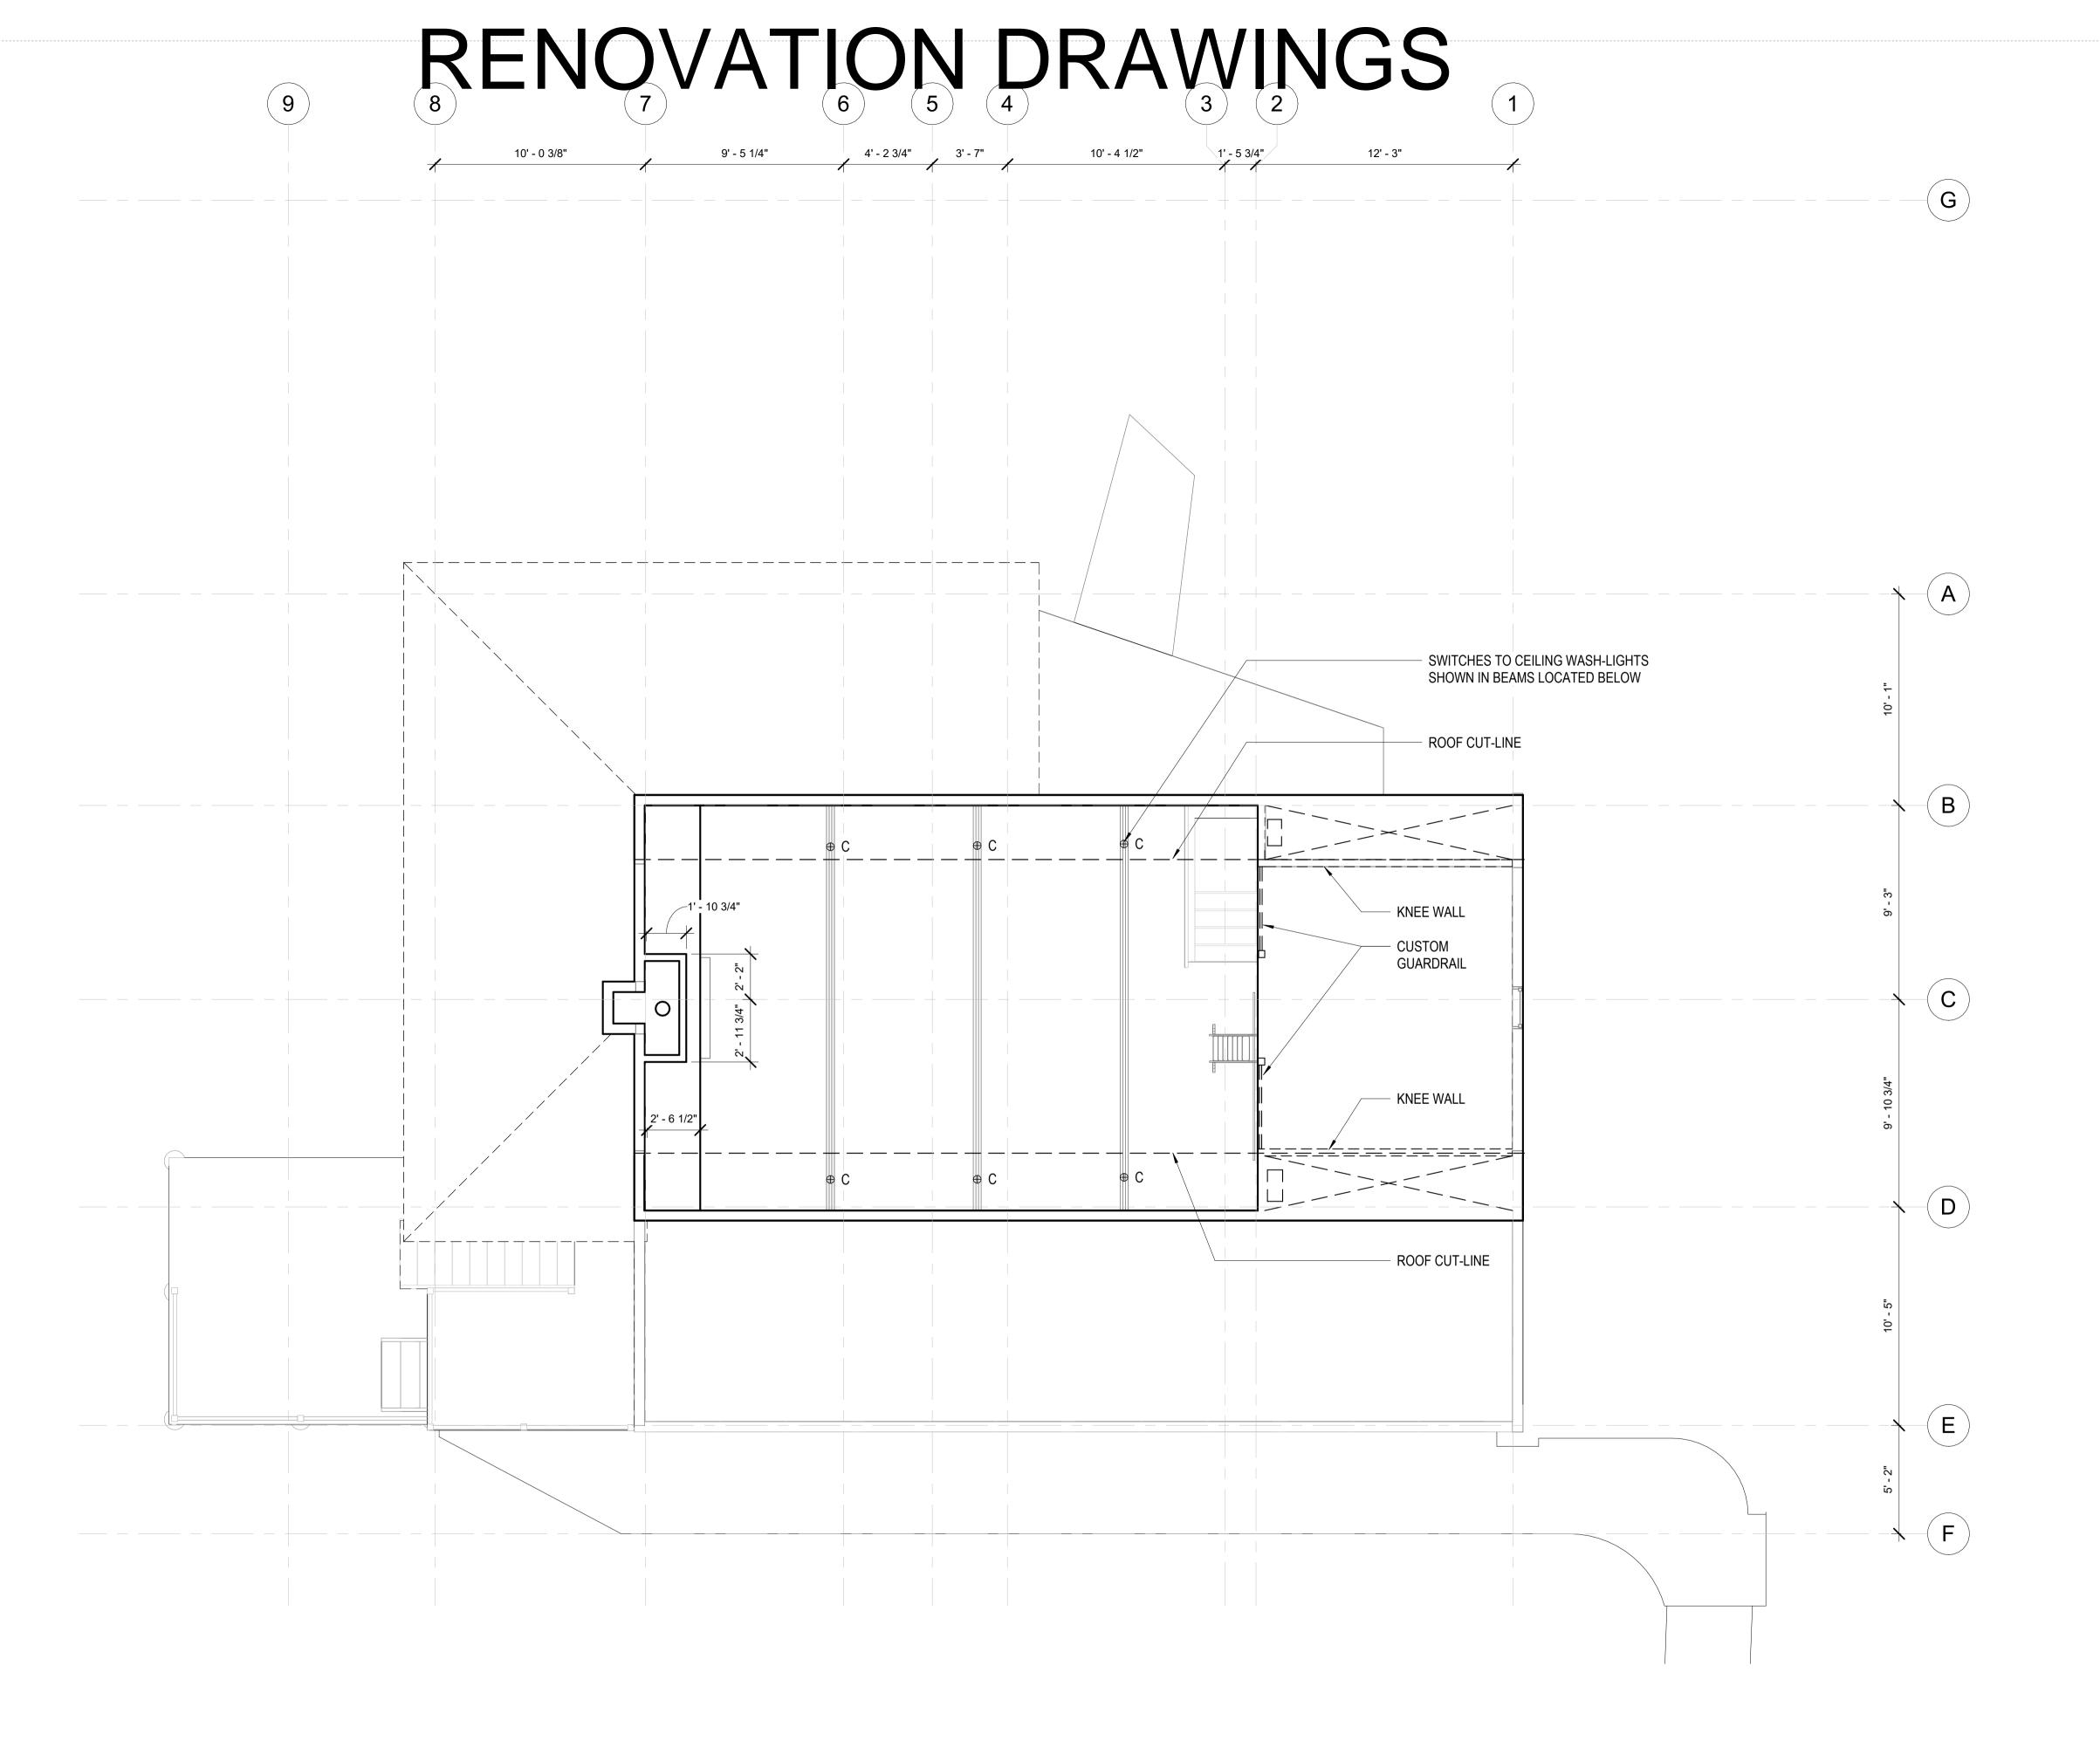

1 Existing - L03 - Upper Floor 1/4" = 1'-0"

client:

Robert & Sally Griffin 2712 N Magnolia Ave, Chicago, IL 60614

architectural designer: **Patrick Griffin**2712 N Magnolia Ave,
Chicago, IL 60614

structural engineer:

civil engineer:


consultant:

project name: **Griffin Residence**7655 Lilly Lake Rd.

Burlington, WI 53105

project number: **PG-2023-001**

seal & signature:

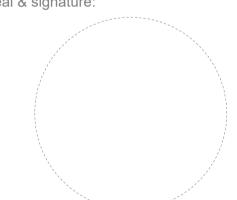

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Rennovation Drawings V5

sheet number: 13 of 35

sheet revisions:

No. Date Description

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Level 3 Demolition Floor Plan


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size: 24 in × 36 in

date: 12/19/2023 12:52:18 PM

Do not scale. Check all dimensions on site.

sheet number:

A-103.00

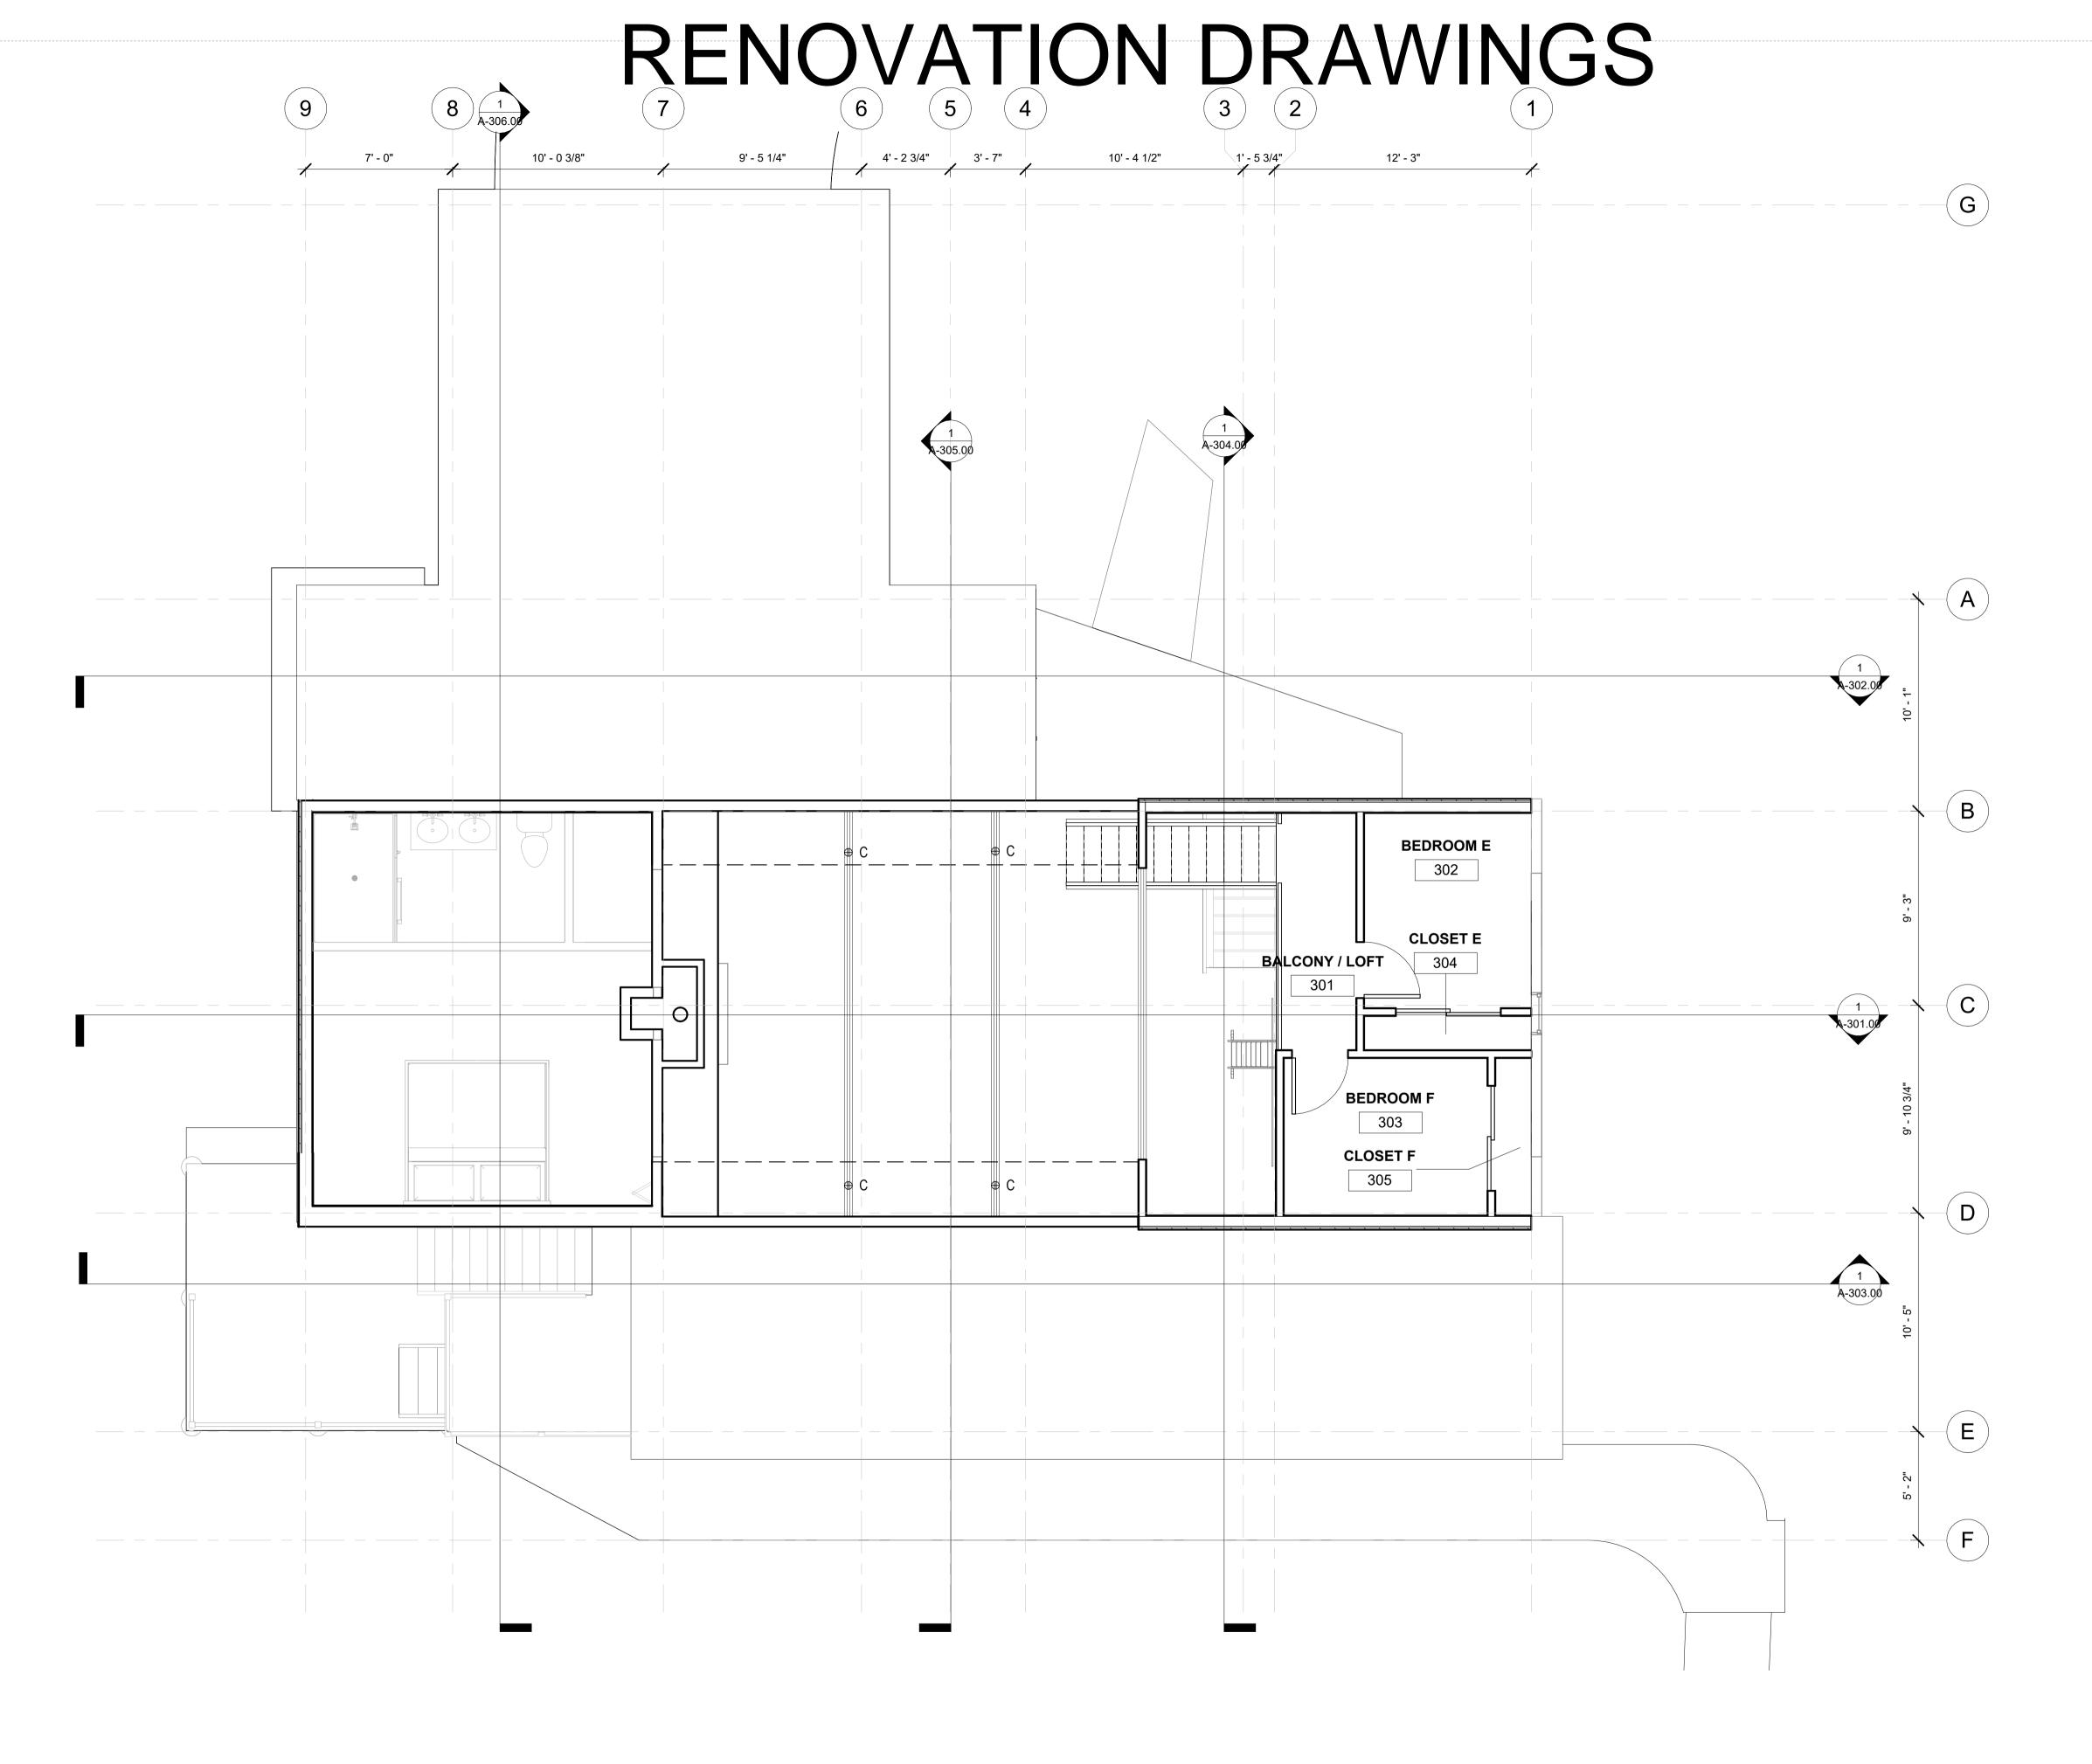

Proposed - L03 - Upper Floor 1/4" = 1'-0" client:

Robert & Sally Griffin 2712 N Magnolia Ave, Chicago, IL 60614

architectural designer: **Patrick Griffin**2712 N Magnolia Ave,
Chicago, IL 60614

structural engineer:

civil engineer:

consultant:

project name: **Griffin Residence**

7655 Lilly Lake Rd. Burlington, WI 53105 project number:

PG-2023-001



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Rennovation Drawings V5

sheet number: 14 of 35

sheet revisions:

No. Date Description

key plan:

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Level 3 Renovated Floor Plan


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scale: 1/4" = 1'-0"
size: 24 in × 36 in

date: 12/19/2023 12:52:20 PM

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A-103.01



2 Existing - Roof Plan 1/4" = 1'-0"

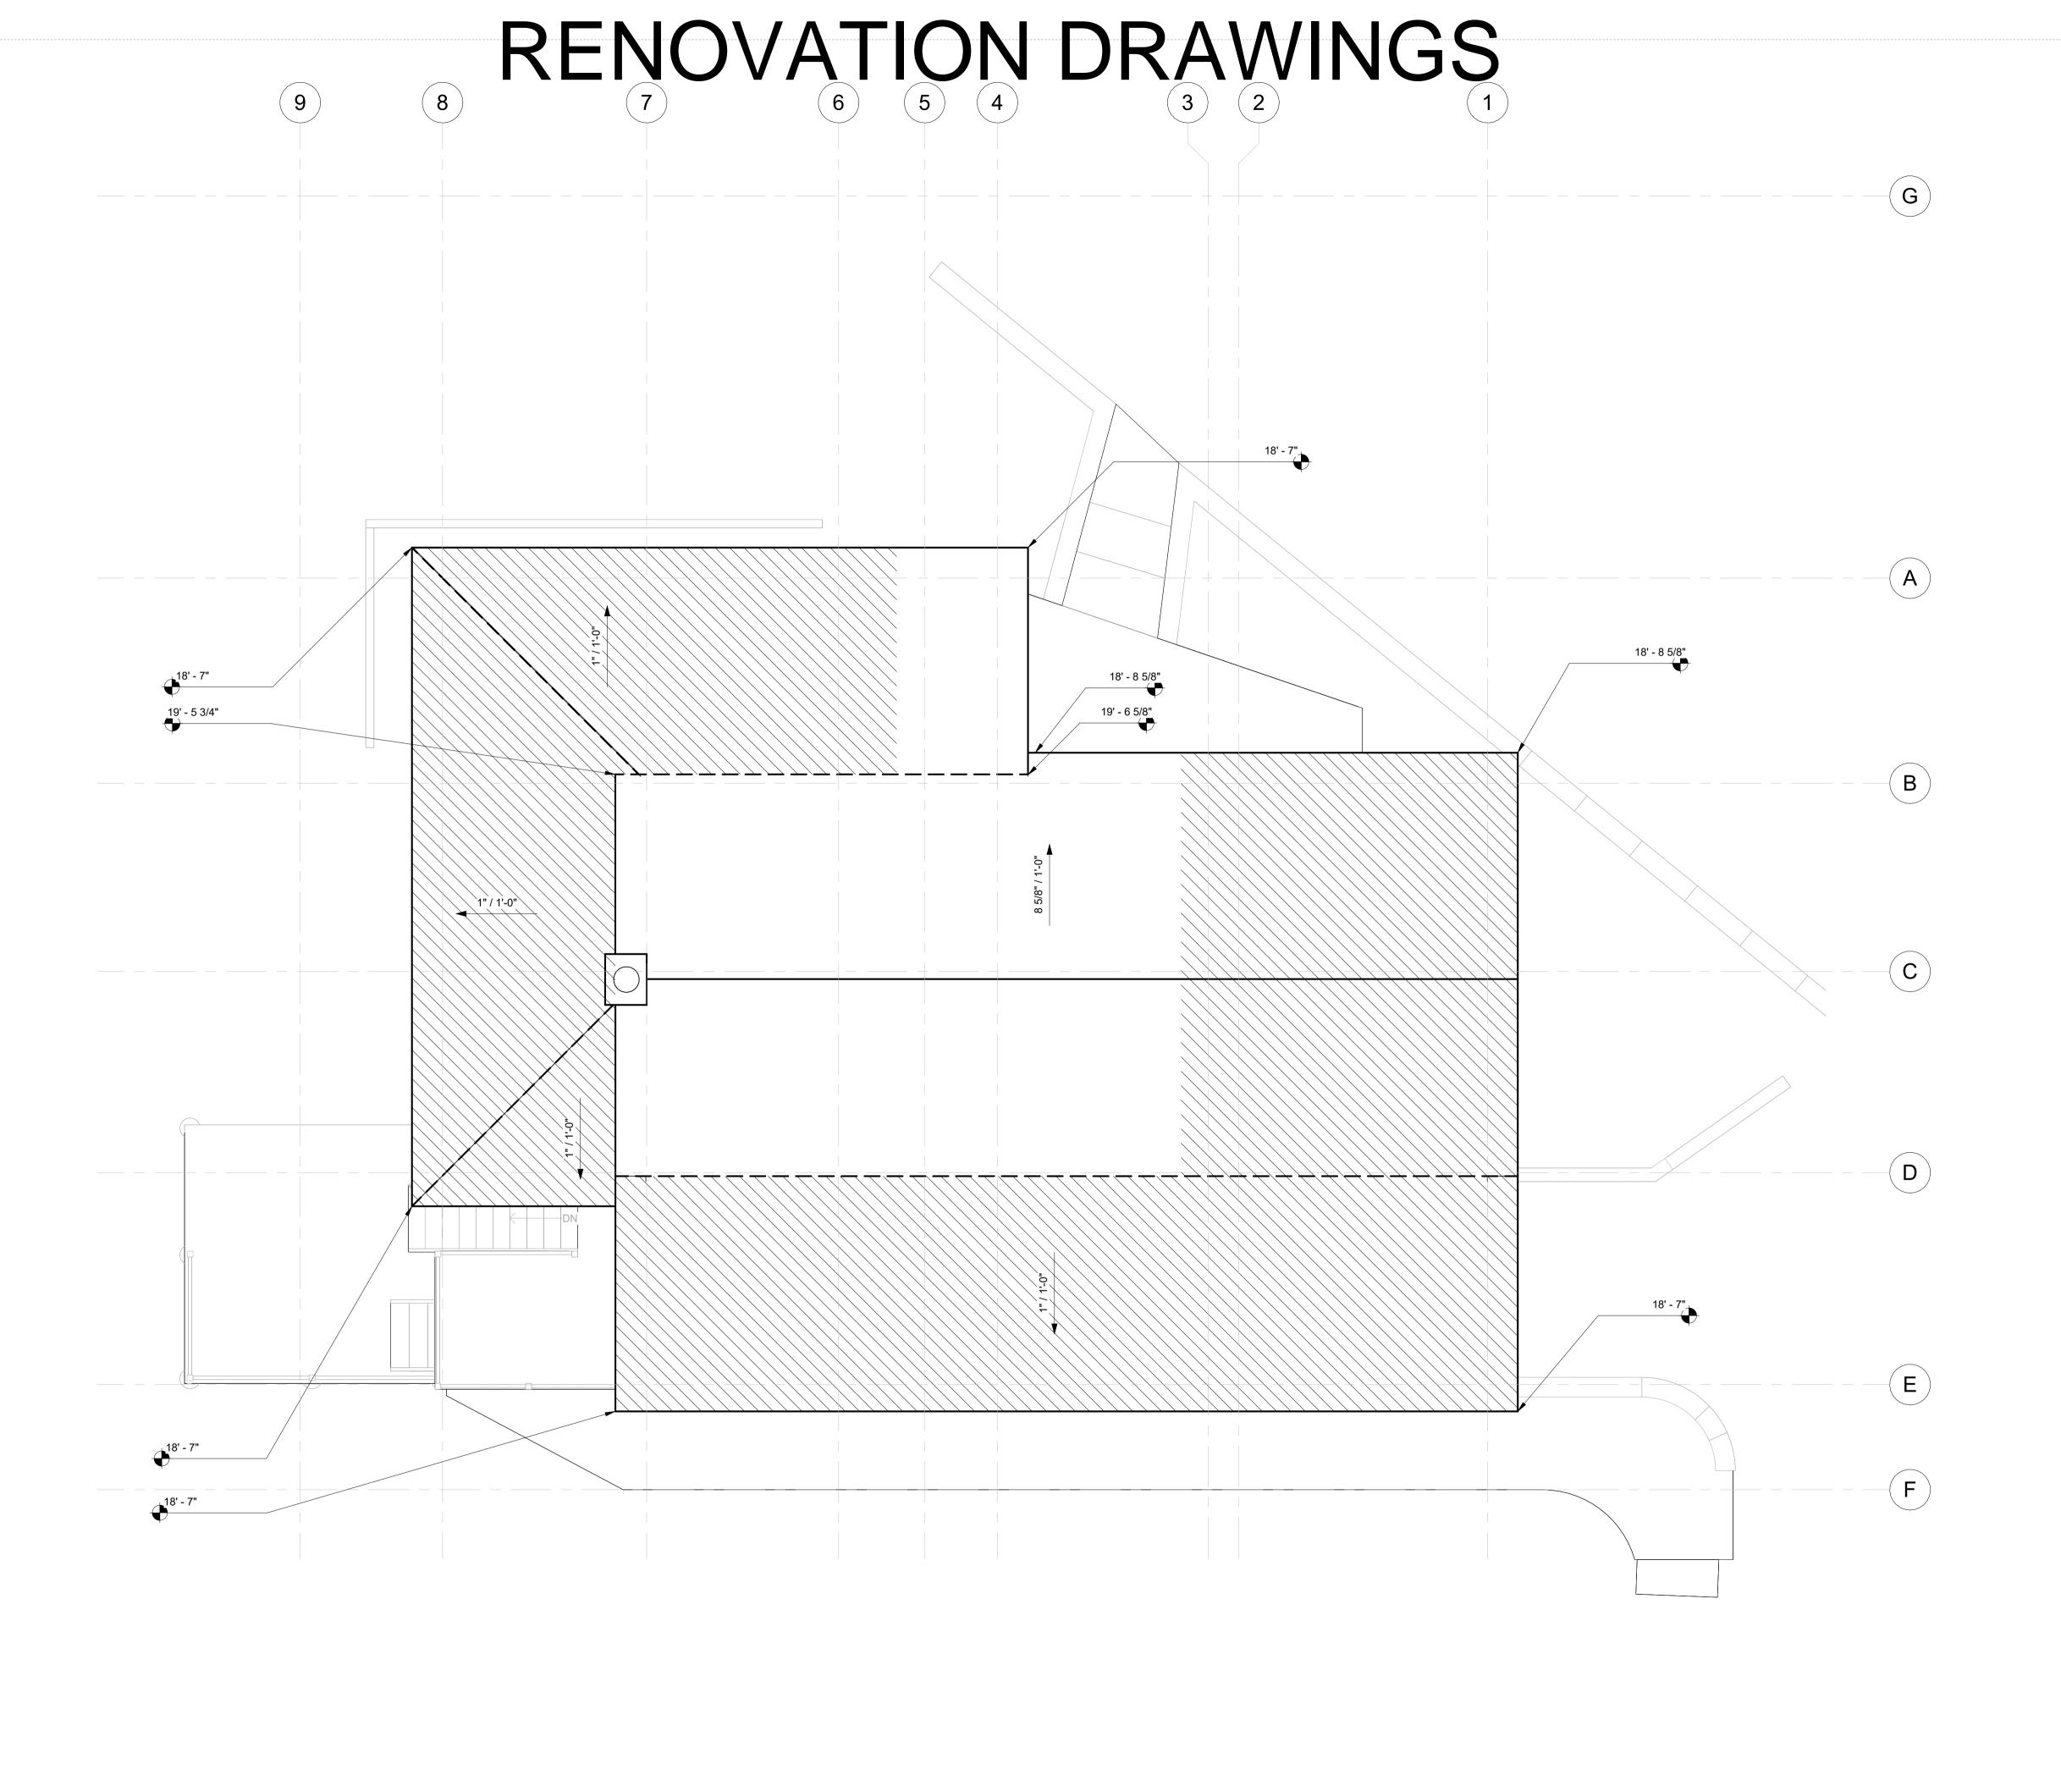Robert & Sally Griffin 2712 N Magnolia Ave, Chicago, IL 60614 architectural designer:
Patrick Griffin 2712 N Magnolia Ave, Chicago, IL 60614


structural engineer:

consultant:

civil engineer:

project name: **Griffin Residence**7655 Lilly Lake Rd.
Burlington, WI 53105

project number: PG-2023-001

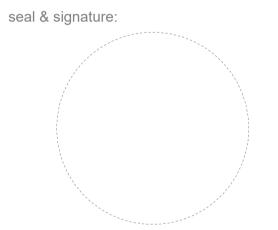

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Rennovation Drawings V5

No. Date Description

sheet number: 15 of 35

sheet revisions:


key plan:

Demolition Roof Plan

Patrick G 1/4" = 1'-0" 24 in × 36 in 12/19/2023 12:52:21 PM

Do not scale. Check all dimensions on site.

A-104.00

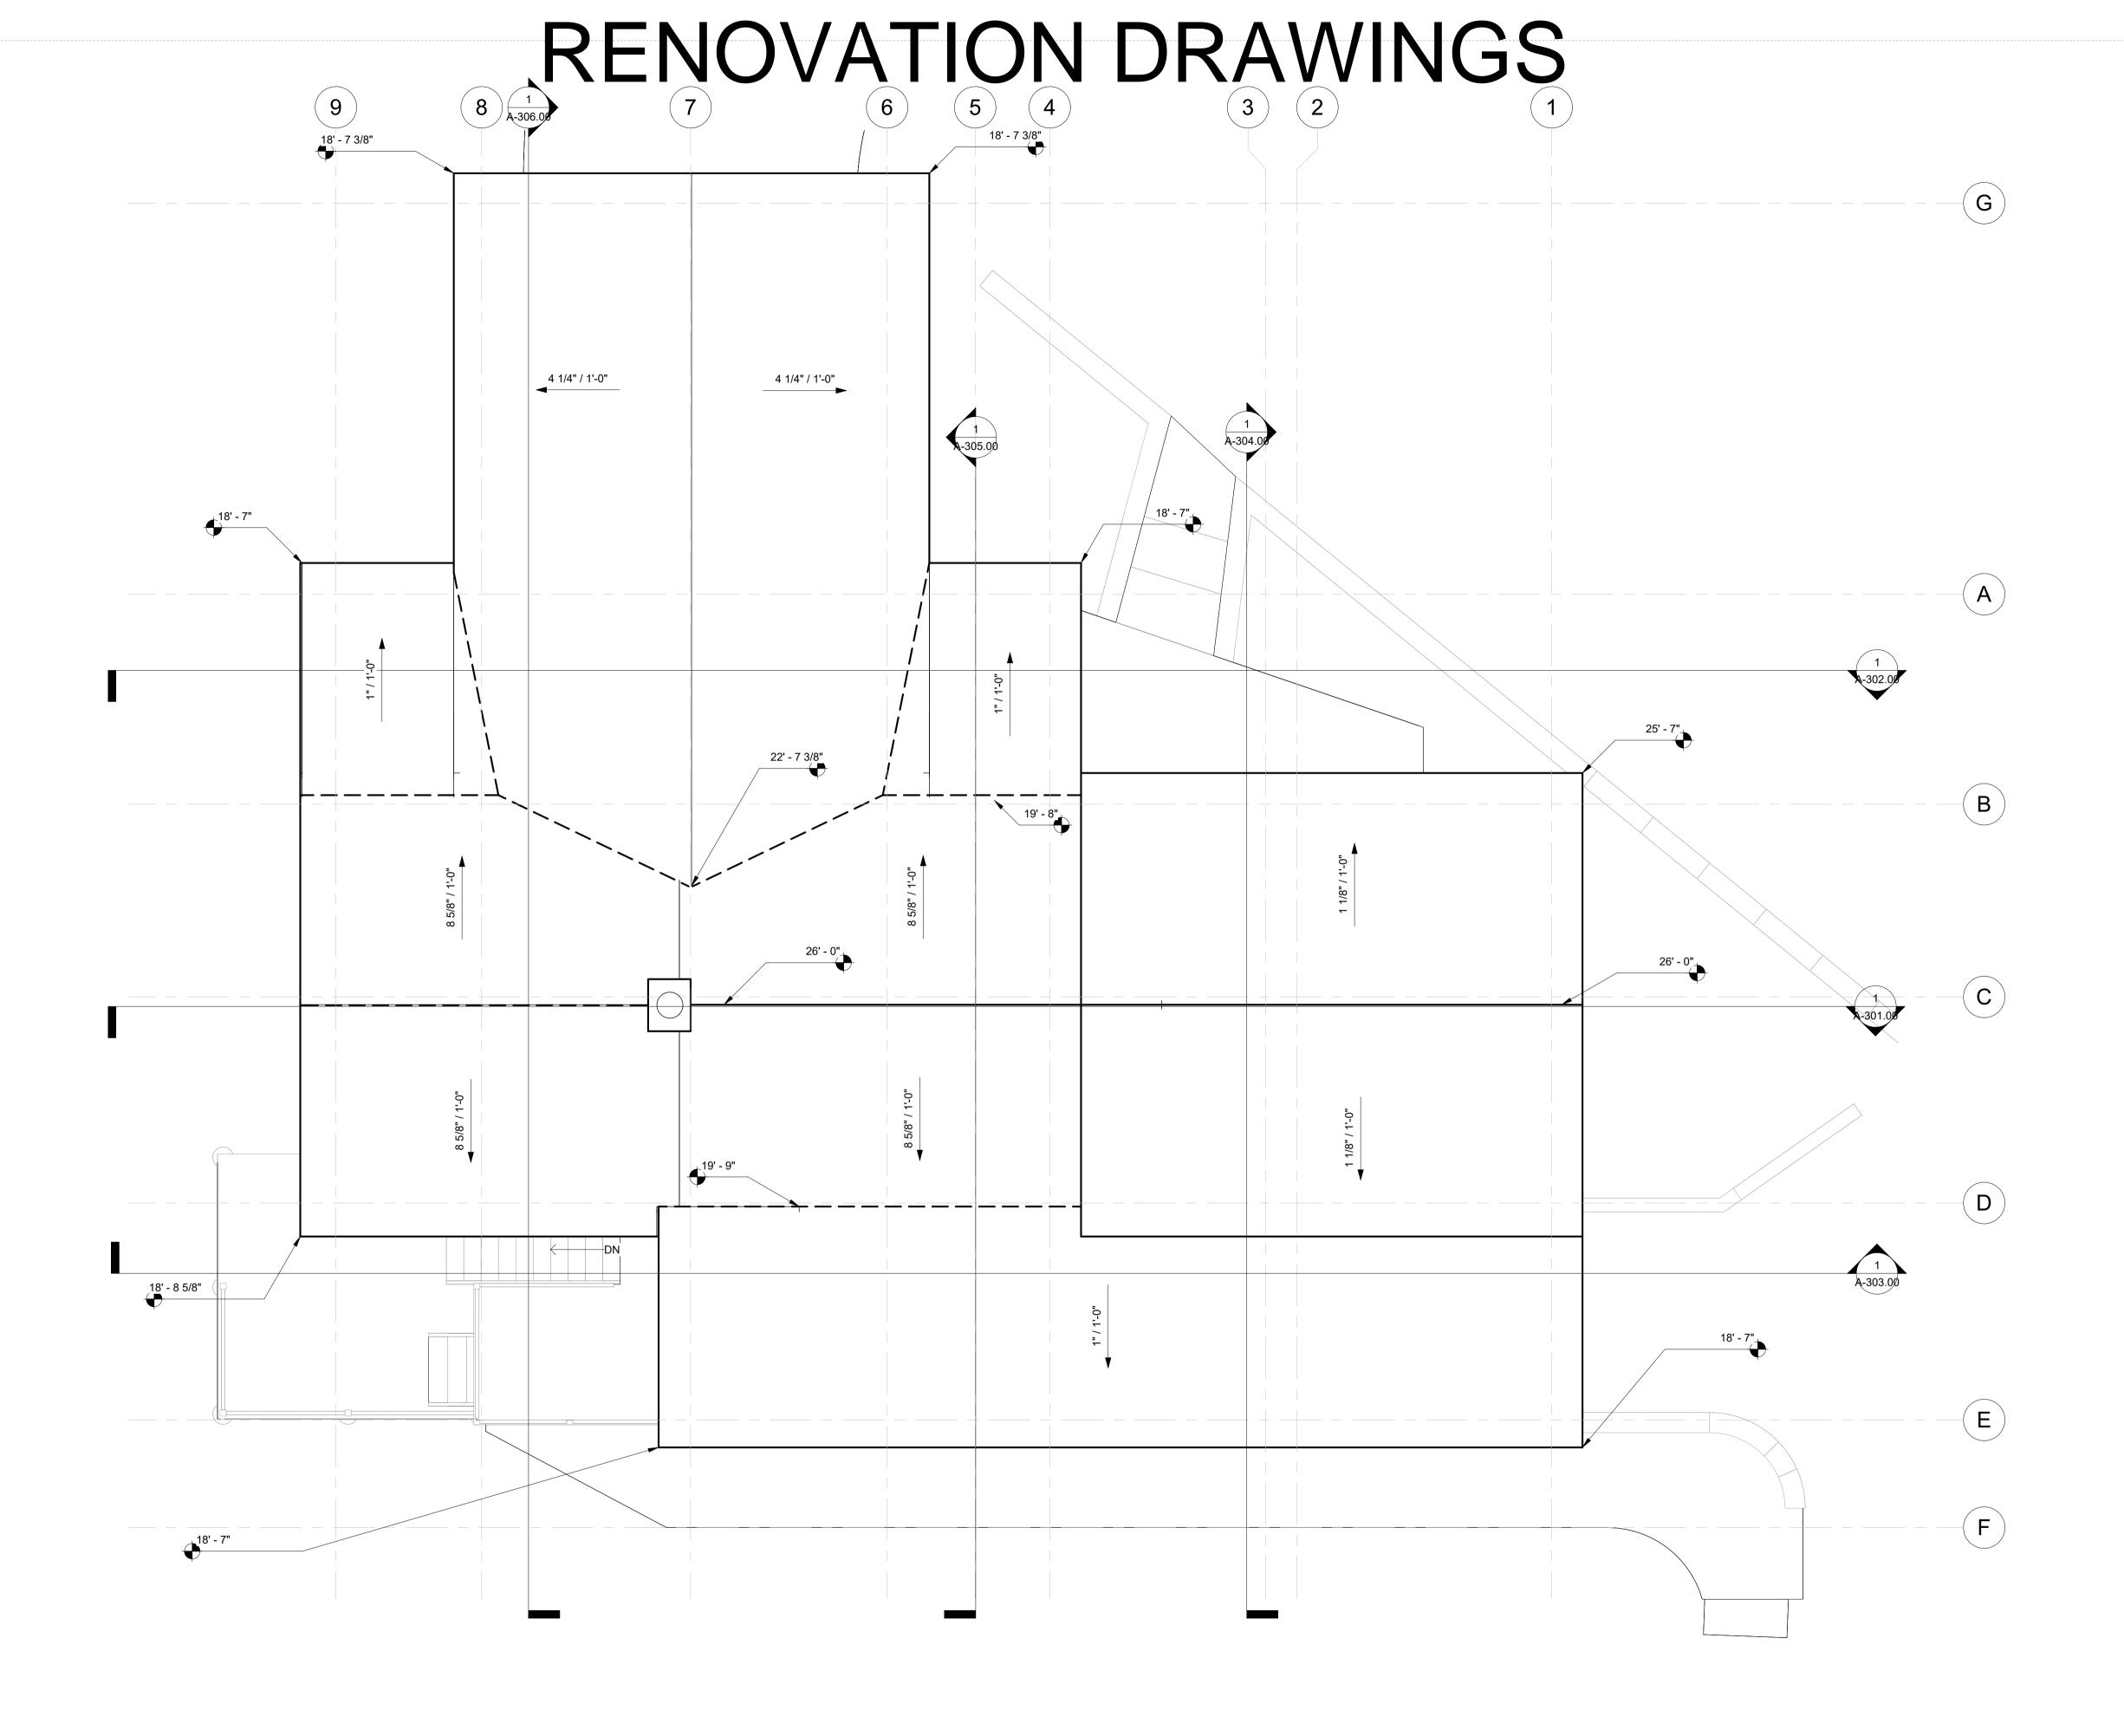

Proposed - Roof Plan 1/4" = 1'-0"

client: **Robert & Sally Griffin**2712 N Magnolia Ave,

Chicago, IL 60614

architectural designer:
Patrick Griffin 2712 N Magnolia Ave, Chicago, IL 60614


structural engineer:

civil engineer:

consultant:

project name: **Griffin Residence**7655 Lilly Lake Rd.
Burlington, WI 53105

project number: PG-2023-001

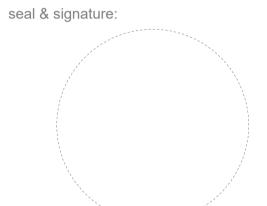

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Rennovation Drawings V5

sheet number: 16 of 35

sheet revisions:

No. Date Description

key plan:

Renovated Roof Plan

Patrick G 1/4" = 1'-0" 24 in × 36 in

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A-104.01

RENOVATION DRAWINGS 8 1 9 G A B 9 D **EXISTING DUCT** E F 1 L01 - Basement 1/4" = 1'-0"

client:

Robert & Sally Griffin 2712 N Magnolia Ave, Chicago, IL 60614

architectural designer: **Patrick Griffin**2712 N Magnolia Ave,
Chicago, IL 60614

structural engineer:

civil engineer:


consultant:

project name: **Griffin Residence**

7655 Lilly Lake Rd.
Burlington, WI 53105
project number:

PG-2023-001

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Rennovation Drawings V5

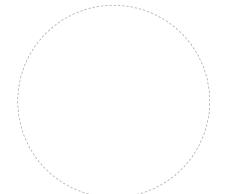sheet number: 17 of 35

sheet revisions:

No. Date Description

key plan:


sheet

Level 1 Reflected Ceiling Plan

drawn by: Patrick G
scale: 1/4" = 1'-0"
size: 24 in × 36 in
date: 12/19/2023 12:52:25 PM

Do not scale. Check all dimensions on site.

sheet number: **A-111.00**

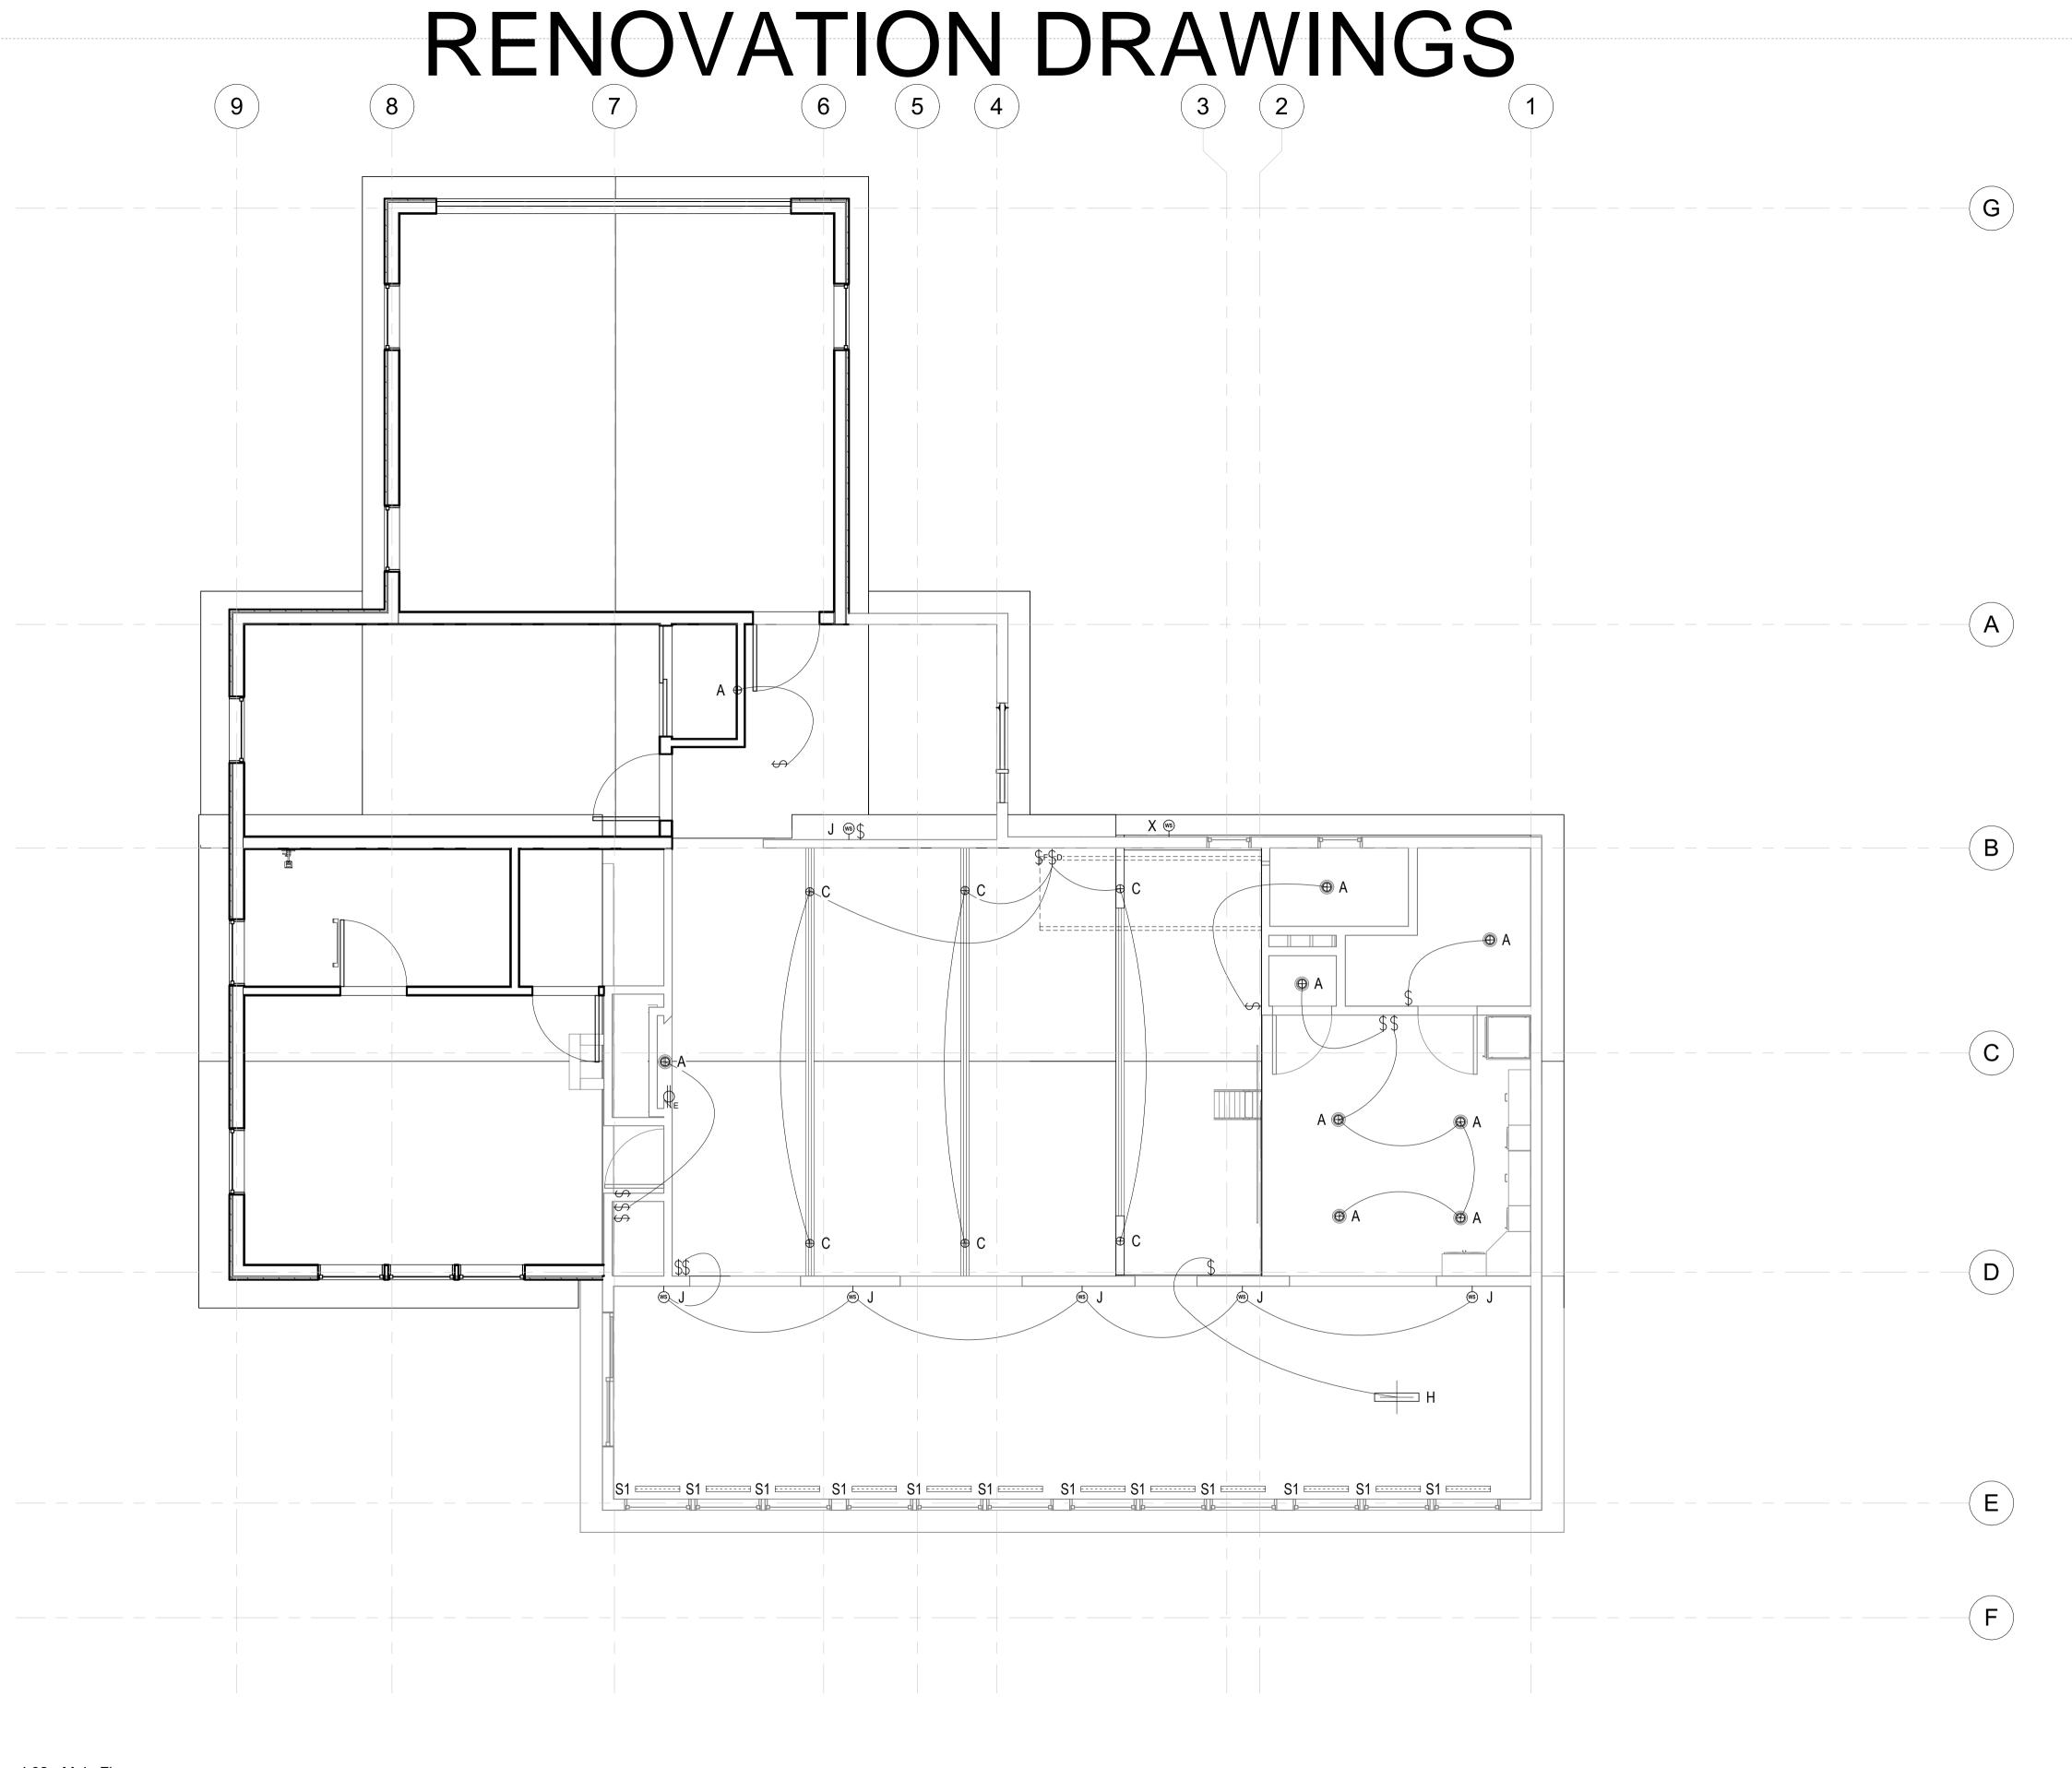

1) L02 - Main Floor 1/4" = 1'-0"

Robert & Sally Griffin 2712 N Magnolia Ave, Chicago, IL 60614

architectural designer:
Patrick Griffin 2712 N Magnolia Ave, Chicago, IL 60614

structural engineer:

civil engineer:

consultant:

project name: **Griffin Residence** 7655 Lilly Lake Rd. Burlington, WI 53105

project number: PG-2023-001



Not For Construction

Rennovation Drawings V5

sheet number: 18 of 35

sheet revisions:

No. Date Description


key plan:

Level 2 Reflected Ceiling Plan

drawn by: Patrick G 1/4" = 1'-0" 24 in × 36 in 12/19/2023 12:52:26 PM

Do not scale. Check all dimensions on site.

A-112.00

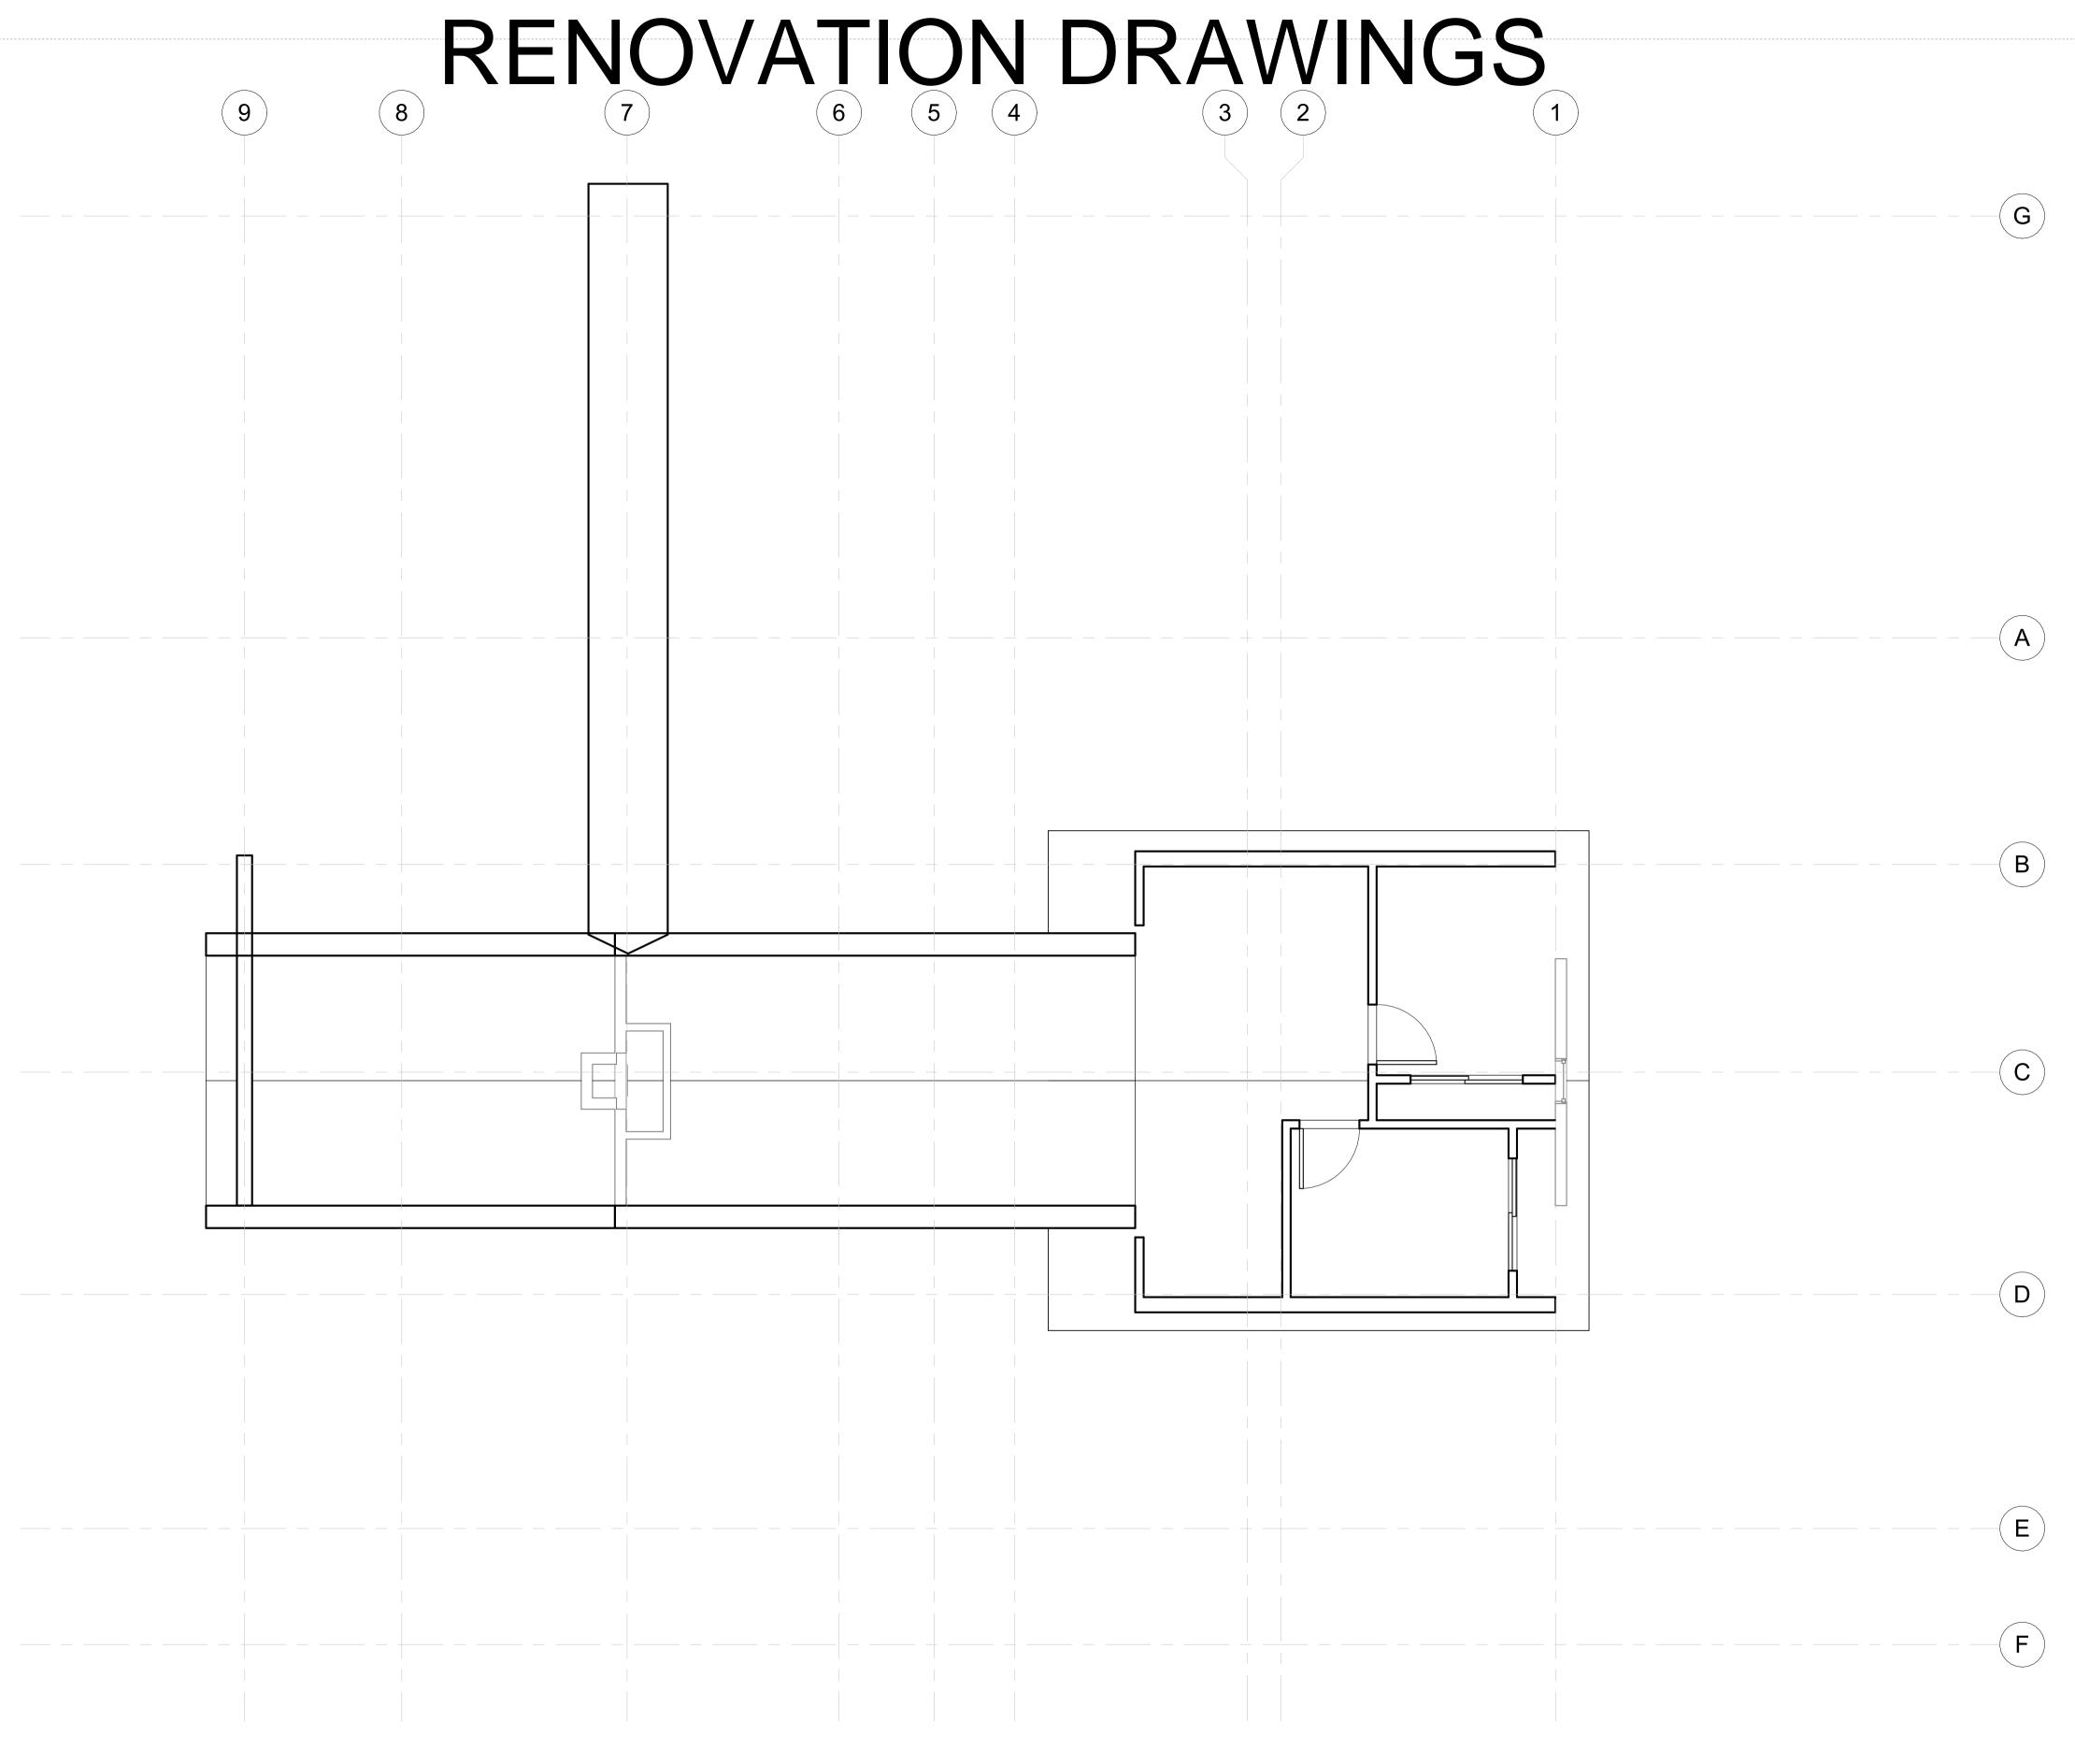

1 L03 - Upper Floor 1/4" = 1'-0" client: **Robert & Sally Griffin**2712 N Magnolia Ave,
Chicago, IL 60614

architectural designer: **Patrick Griffin**2712 N Magnolia Ave,
Chicago, IL 60614

structural engineer:


civil engineer:

consultant:

project name: **Griffin Residence**7655 Lilly Lake Rd.
Burlington, WI 53105

project number: **PG-2023-001**

seal & signature:

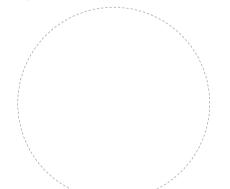

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Rennovation Drawings V5

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sheet revisions:No. Date Description

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key plan:

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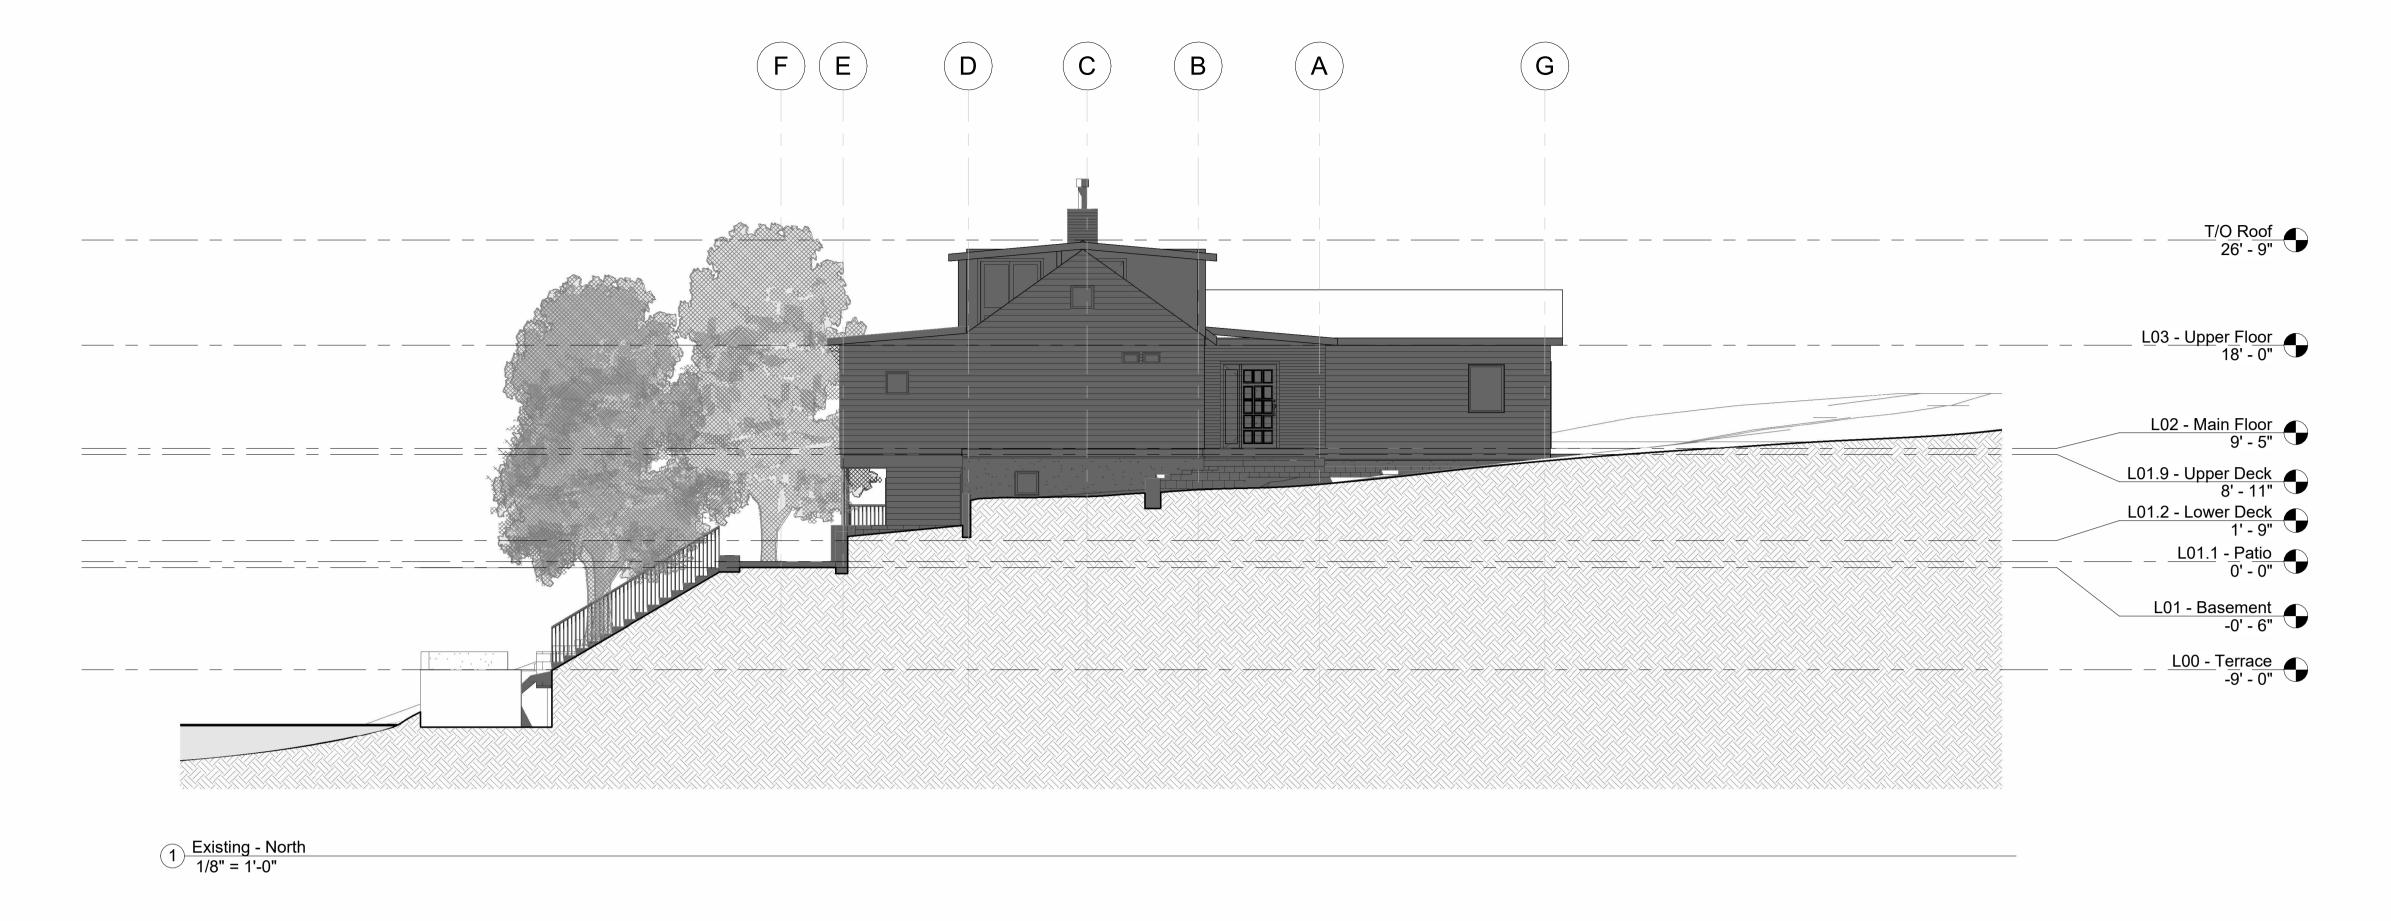
Level 3 Reflected Ceiling Plan


drawn by: Patrick G
scale: 1/4" = 1'-0"
size: 24 in × 36 in
date: 12/19/2023 12:52:27 PM

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eet number:

A-113.00



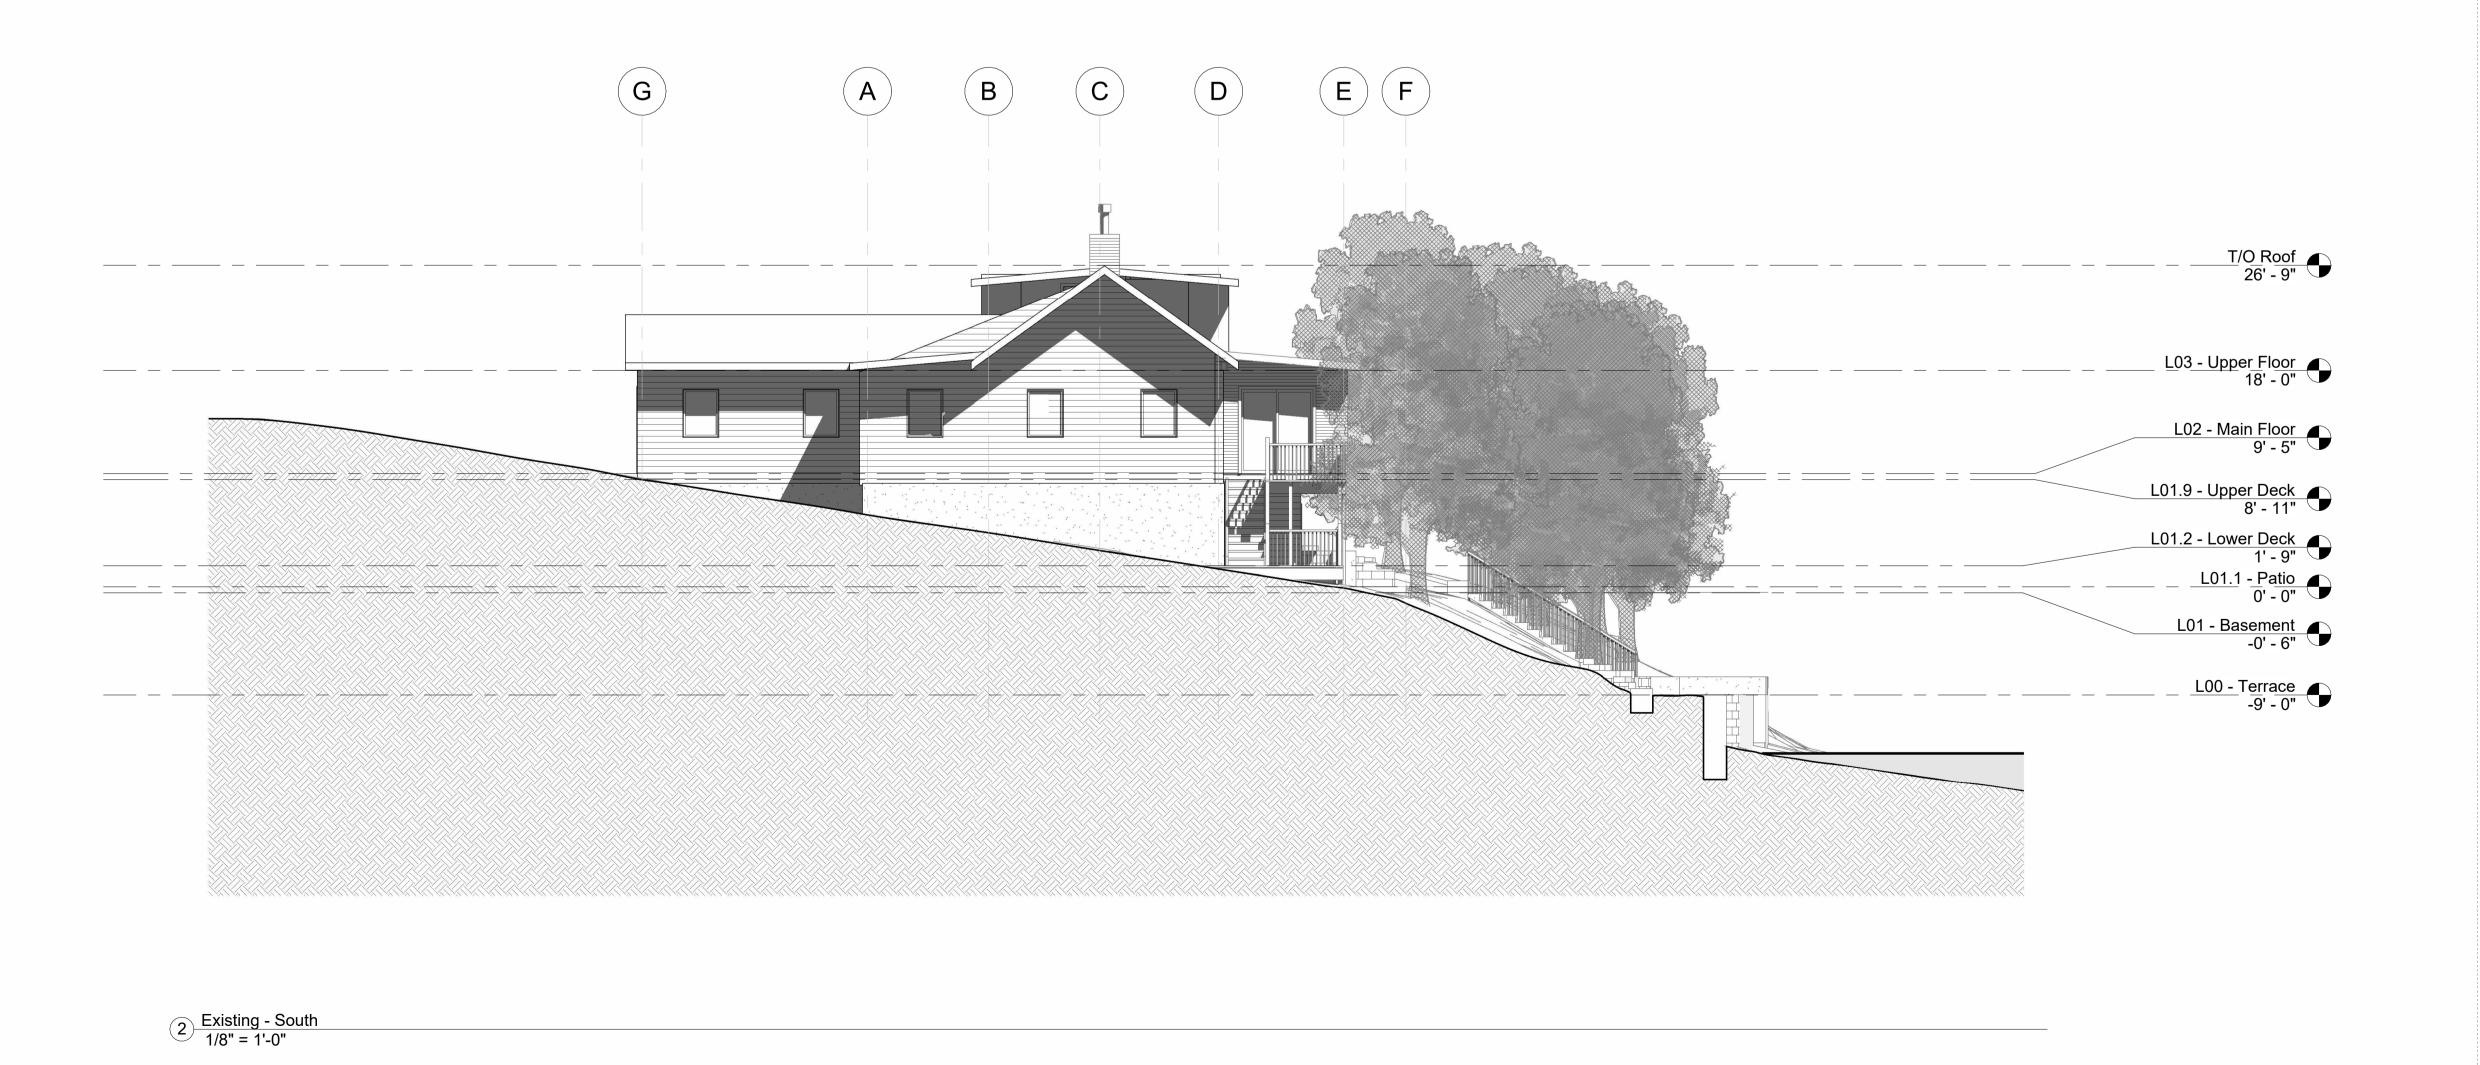

Robert & Sally Griffin 2712 N Magnolia Ave, Chicago, IL 60614

architectural designer:
Patrick Griffin 2712 N Magnolia Ave, Chicago, IL 60614

structural engineer:

civil engineer:

consultant:

project name: Griffin Residence 7655 Lilly Lake Rd. Burlington, WI 53105

project number: PG-2023-001



Not For Construction

Rennovation Drawings V5

sheet number: 20 of 35

sheet revisions:

No. Date Description

key plan:


North & South **Exterior Elevations**

drawn by: Patrick G 1/8" = 1'-0" 24 in × 36 in

12/19/2023 12:53:06 PM Do not scale. Check all dimensions on site.

A-201.00



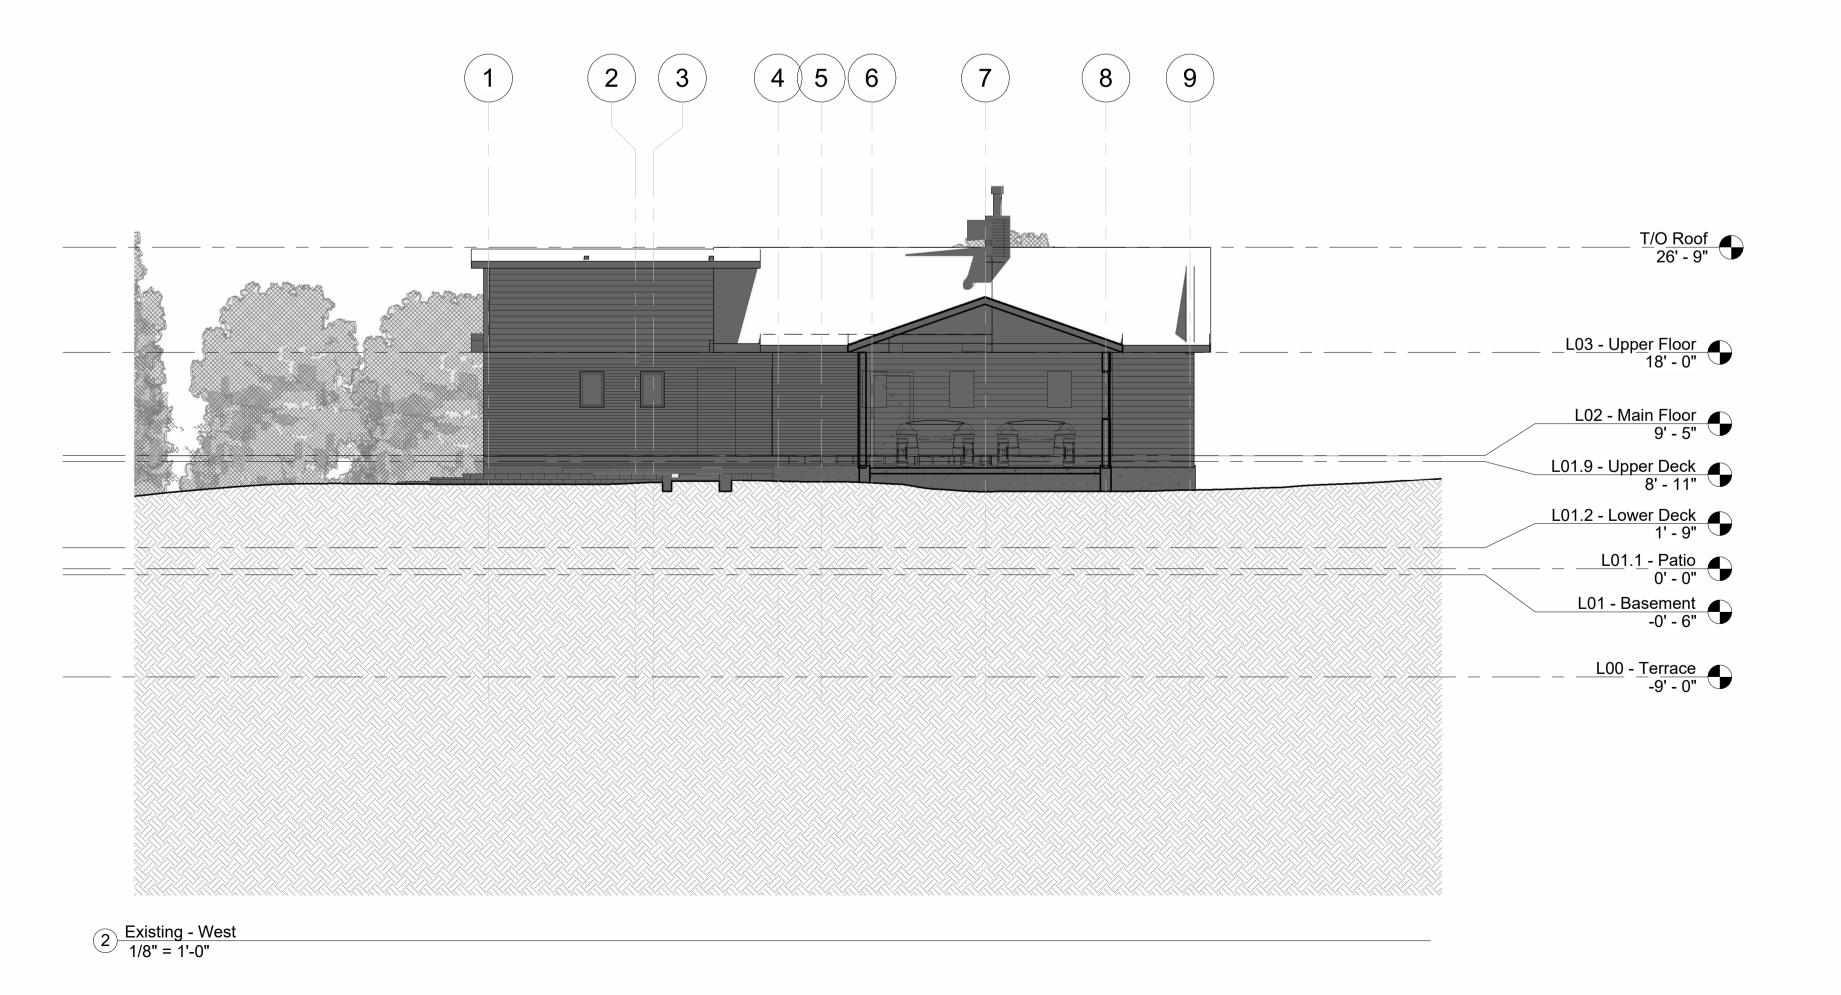

Robert & Sally Griffin 2712 N Magnolia Ave, Chicago, IL 60614

architectural designer:
Patrick Griffin 2712 N Magnolia Ave, Chicago, IL 60614

structural engineer:


civil engineer:

consultant:

project name: Griffin Residence 7655 Lilly Lake Rd. Burlington, WI 53105

project number: PG-2023-001

seal & signature:

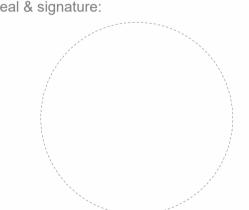

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Rennovation Drawings V5

sheet number: 21 of 35

sheet revisions:

Description No. Date

key plan:


sheet title:

East & West Exterior Elevations

drawn by: Patrick G 1/8" = 1'-0" 24 in × 36 in 12/19/2023 12:53:39 PM

Do not scale. Check all dimensions on site.

A-202.00

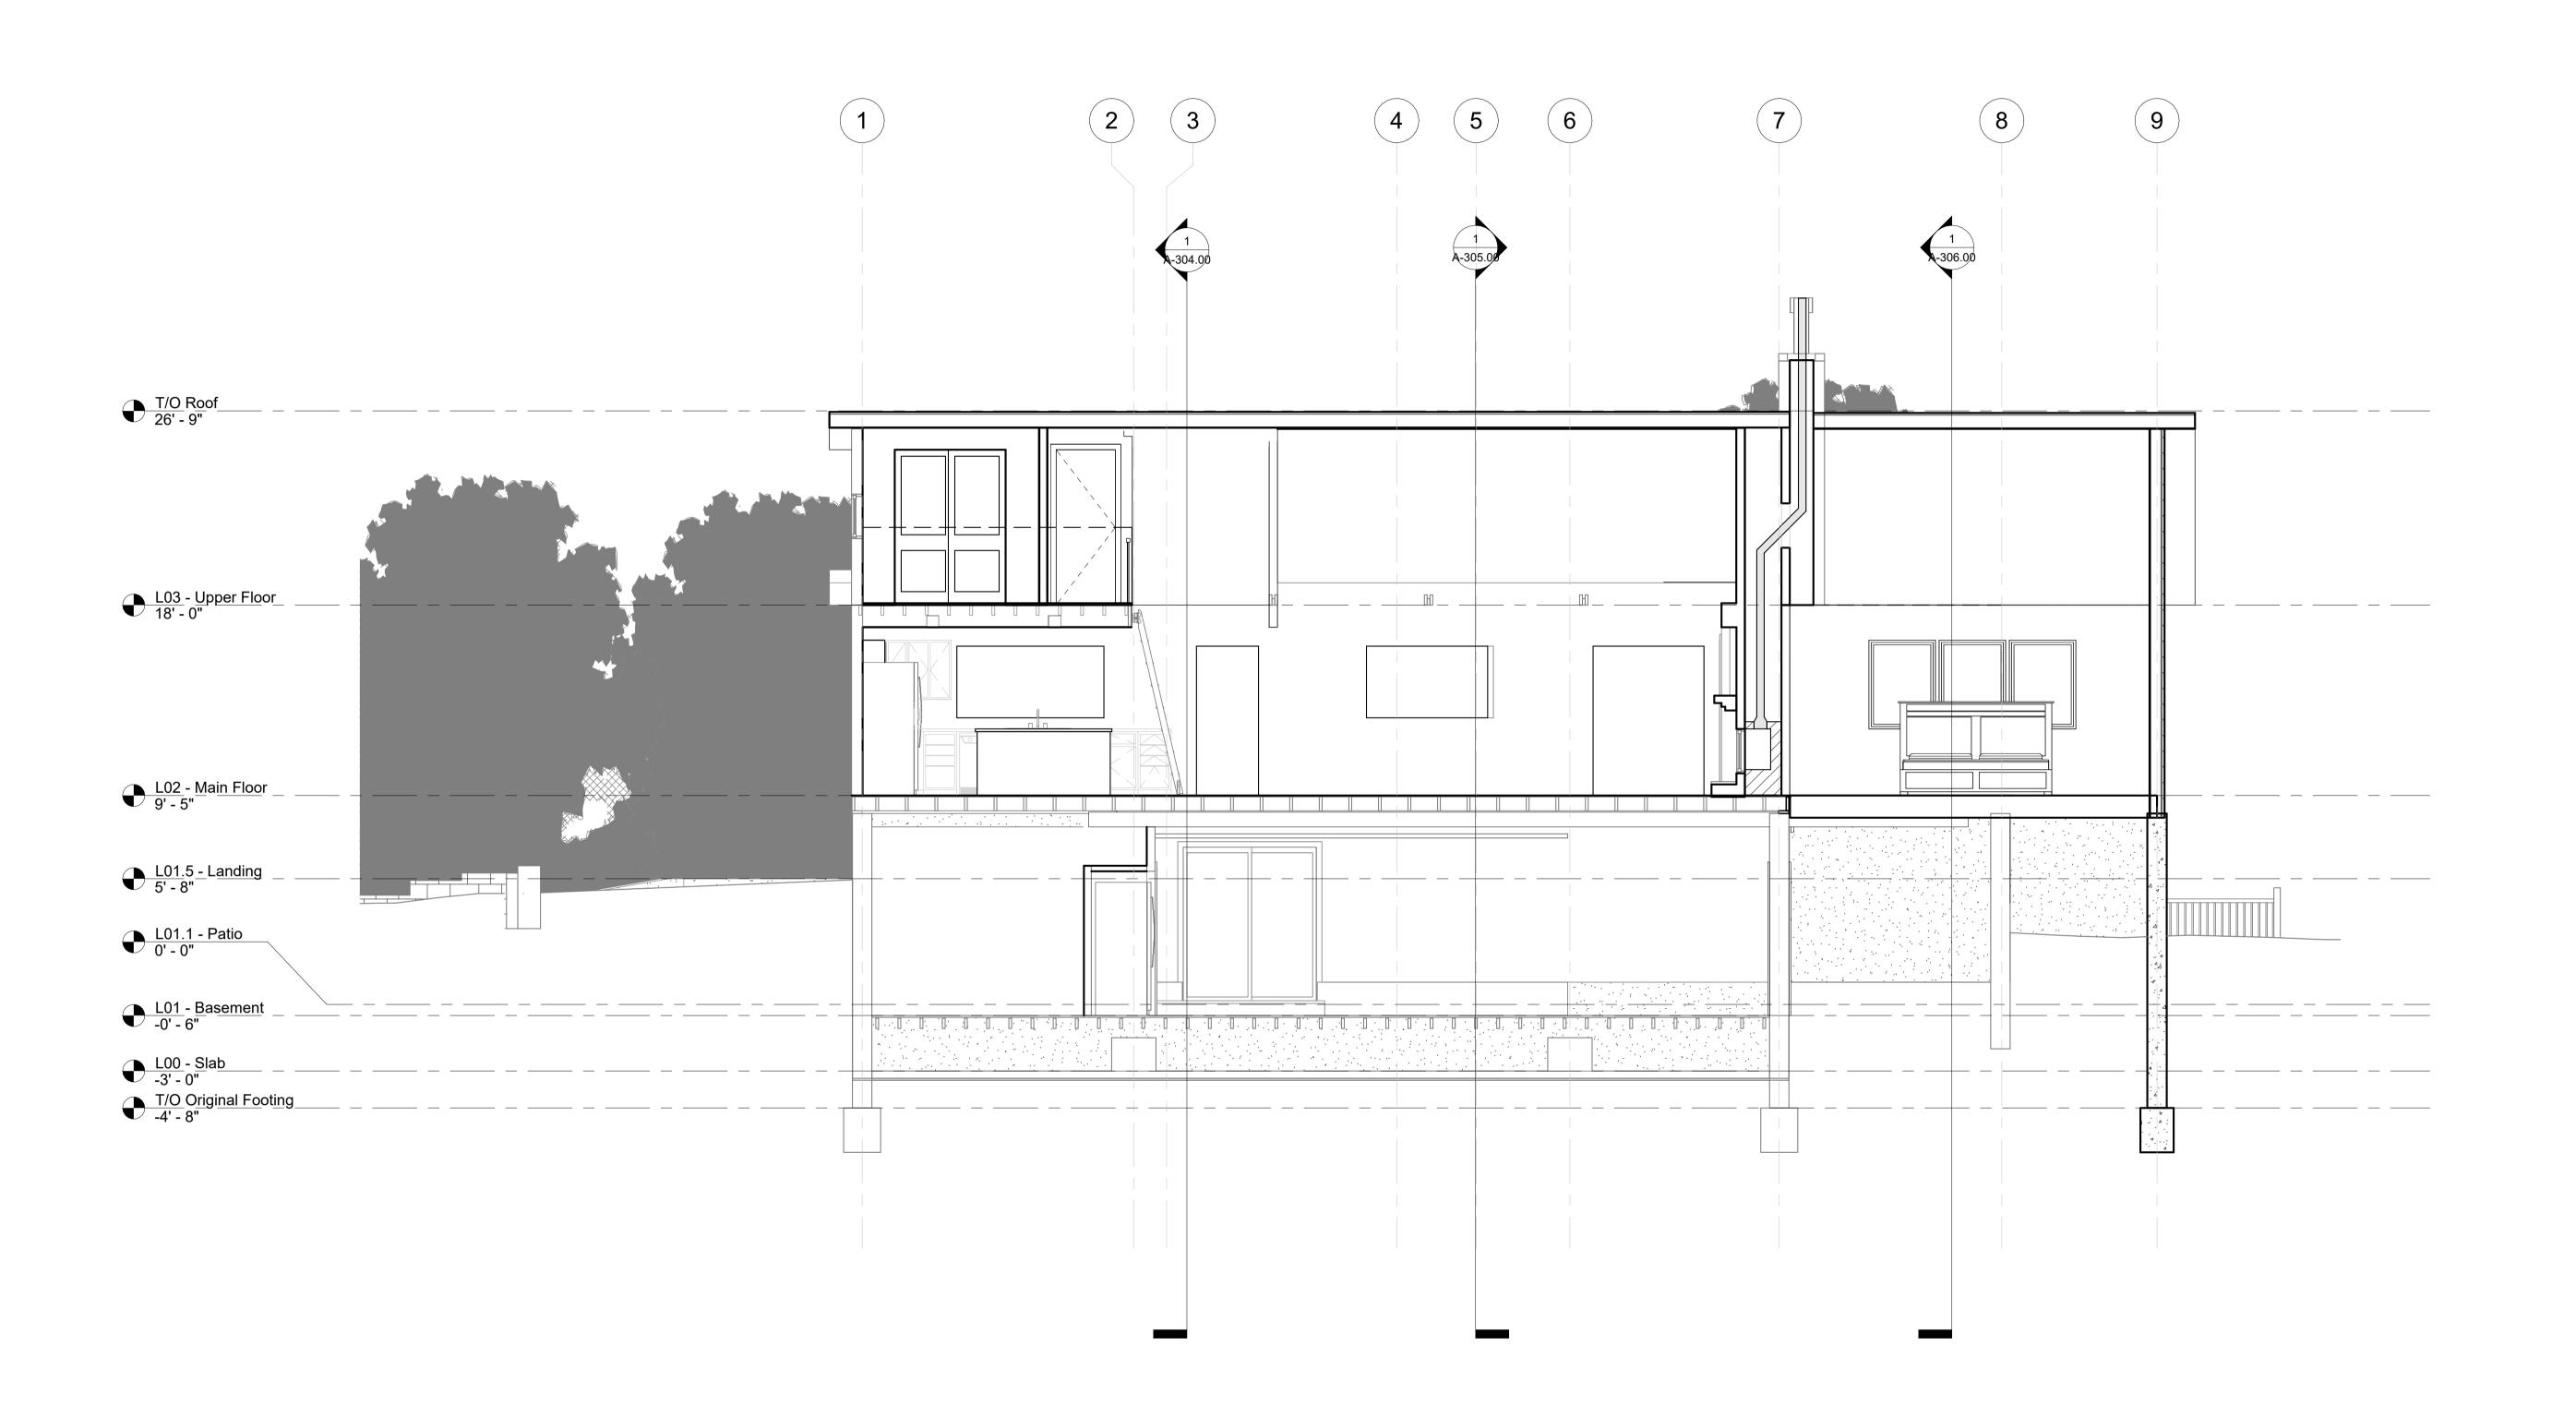

1) Existing - Longitudinal Section 1 - Chimney 1/4" = 1'-0"

Robert & Sally Griffin 2712 N Magnolia Ave, Chicago, IL 60614

architectural designer:
Patrick Griffin 2712 N Magnolia Ave, Chicago, IL 60614

structural engineer:

civil engineer:


consultant:

Griffin Residence

7655 Lilly Lake Rd. Burlington, WI 53105

project number: **PG-2023-001**

seal & signature:

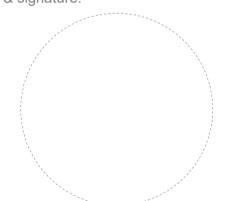

Not For Construction

Rennovation Drawings V5

sheet number: 22 of 35

sheet revisions:

No. Date Description


key plan:

sheet title: Longitudinal **Building Section 1**

Patrick G 1/4" = 1'-0" 24 in × 36 in

12/19/2023 12:53:42 PM Do not scale. Check all dimensions on site.

A-301.00

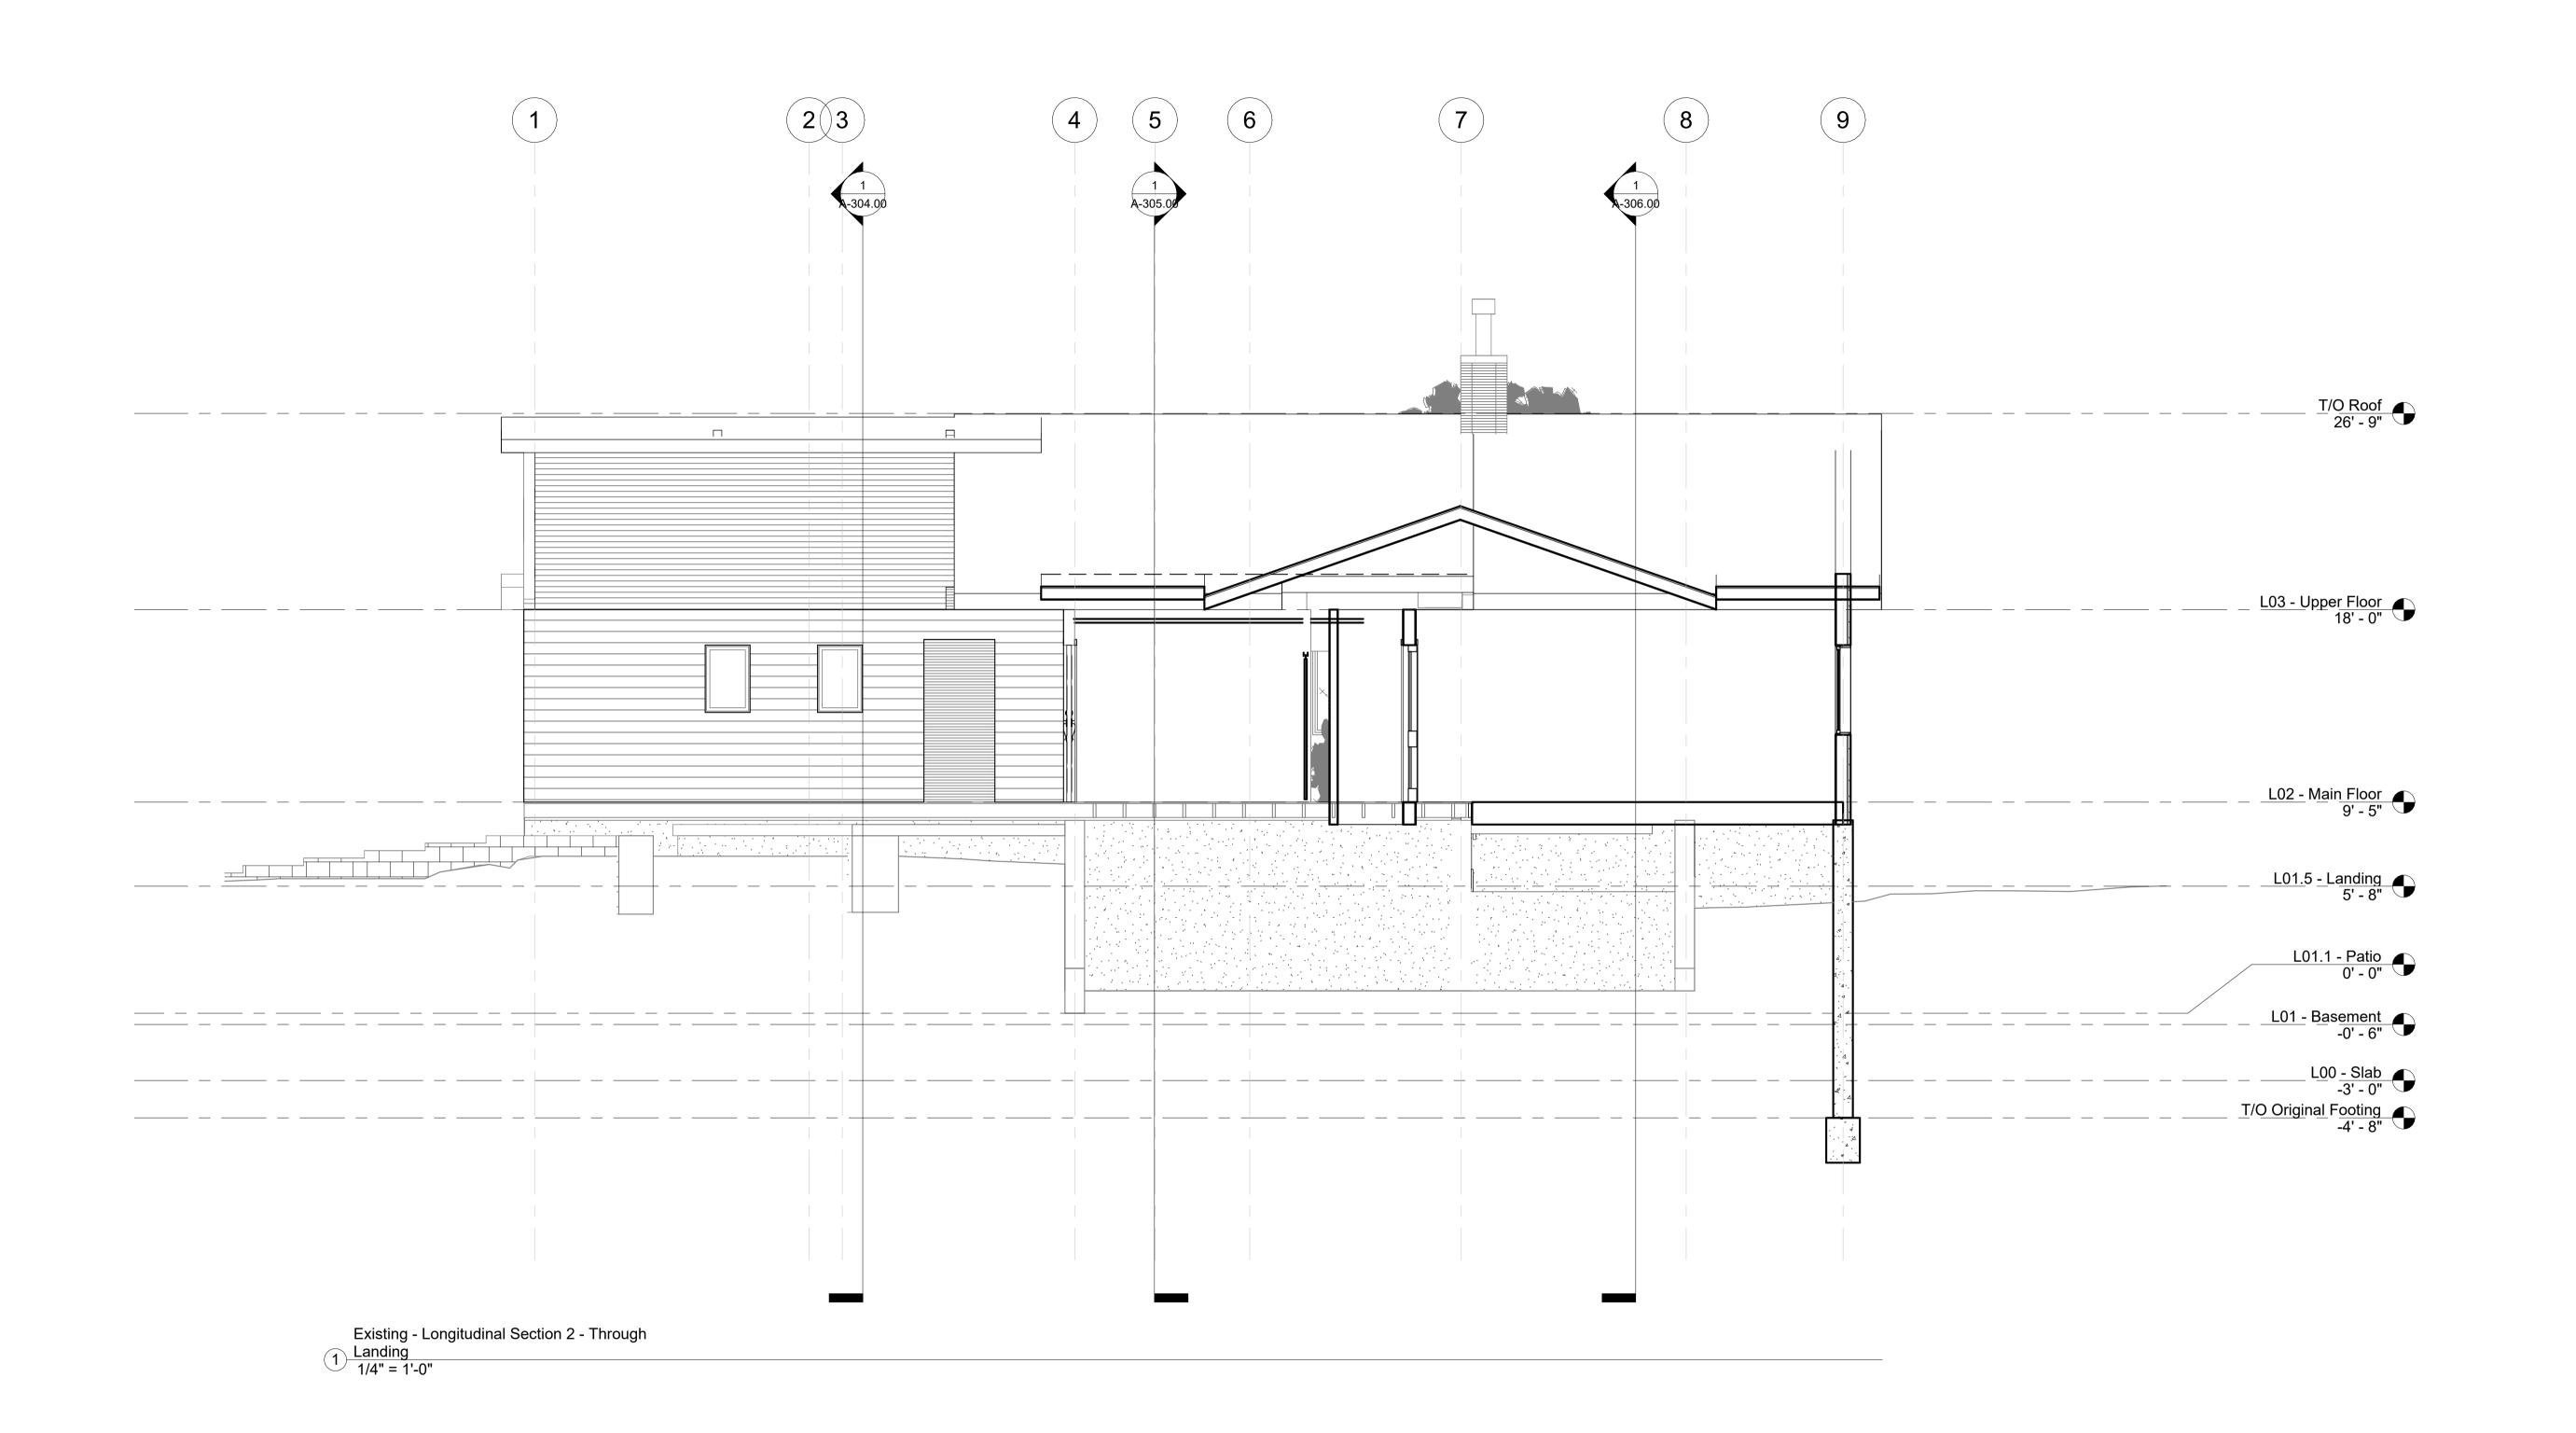

Robert & Sally Griffin 2712 N Magnolia Ave, Chicago, IL 60614

architectural designer:
Patrick Griffin 2712 N Magnolia Ave, Chicago, IL 60614

structural engineer:


civil engineer:

consultant:

project name: **Griffin Residence**7655 Lilly Lake Rd.
Burlington, WI 53105

project number: PG-2023-001

seal & signature:

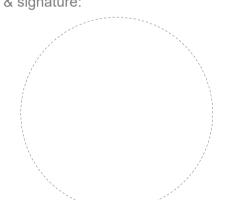

Not For Construction

Rennovation Drawings V5

sheet number: 23 of 35

sheet revisions: No. Date Description


key plan:

Longitudinal **Building Section 2**

Patrick G 1/4" = 1'-0" 24 in × 36 in 12/19/2023 12:53:44 PM

Do not scale. Check all dimensions on site.

A-302.00

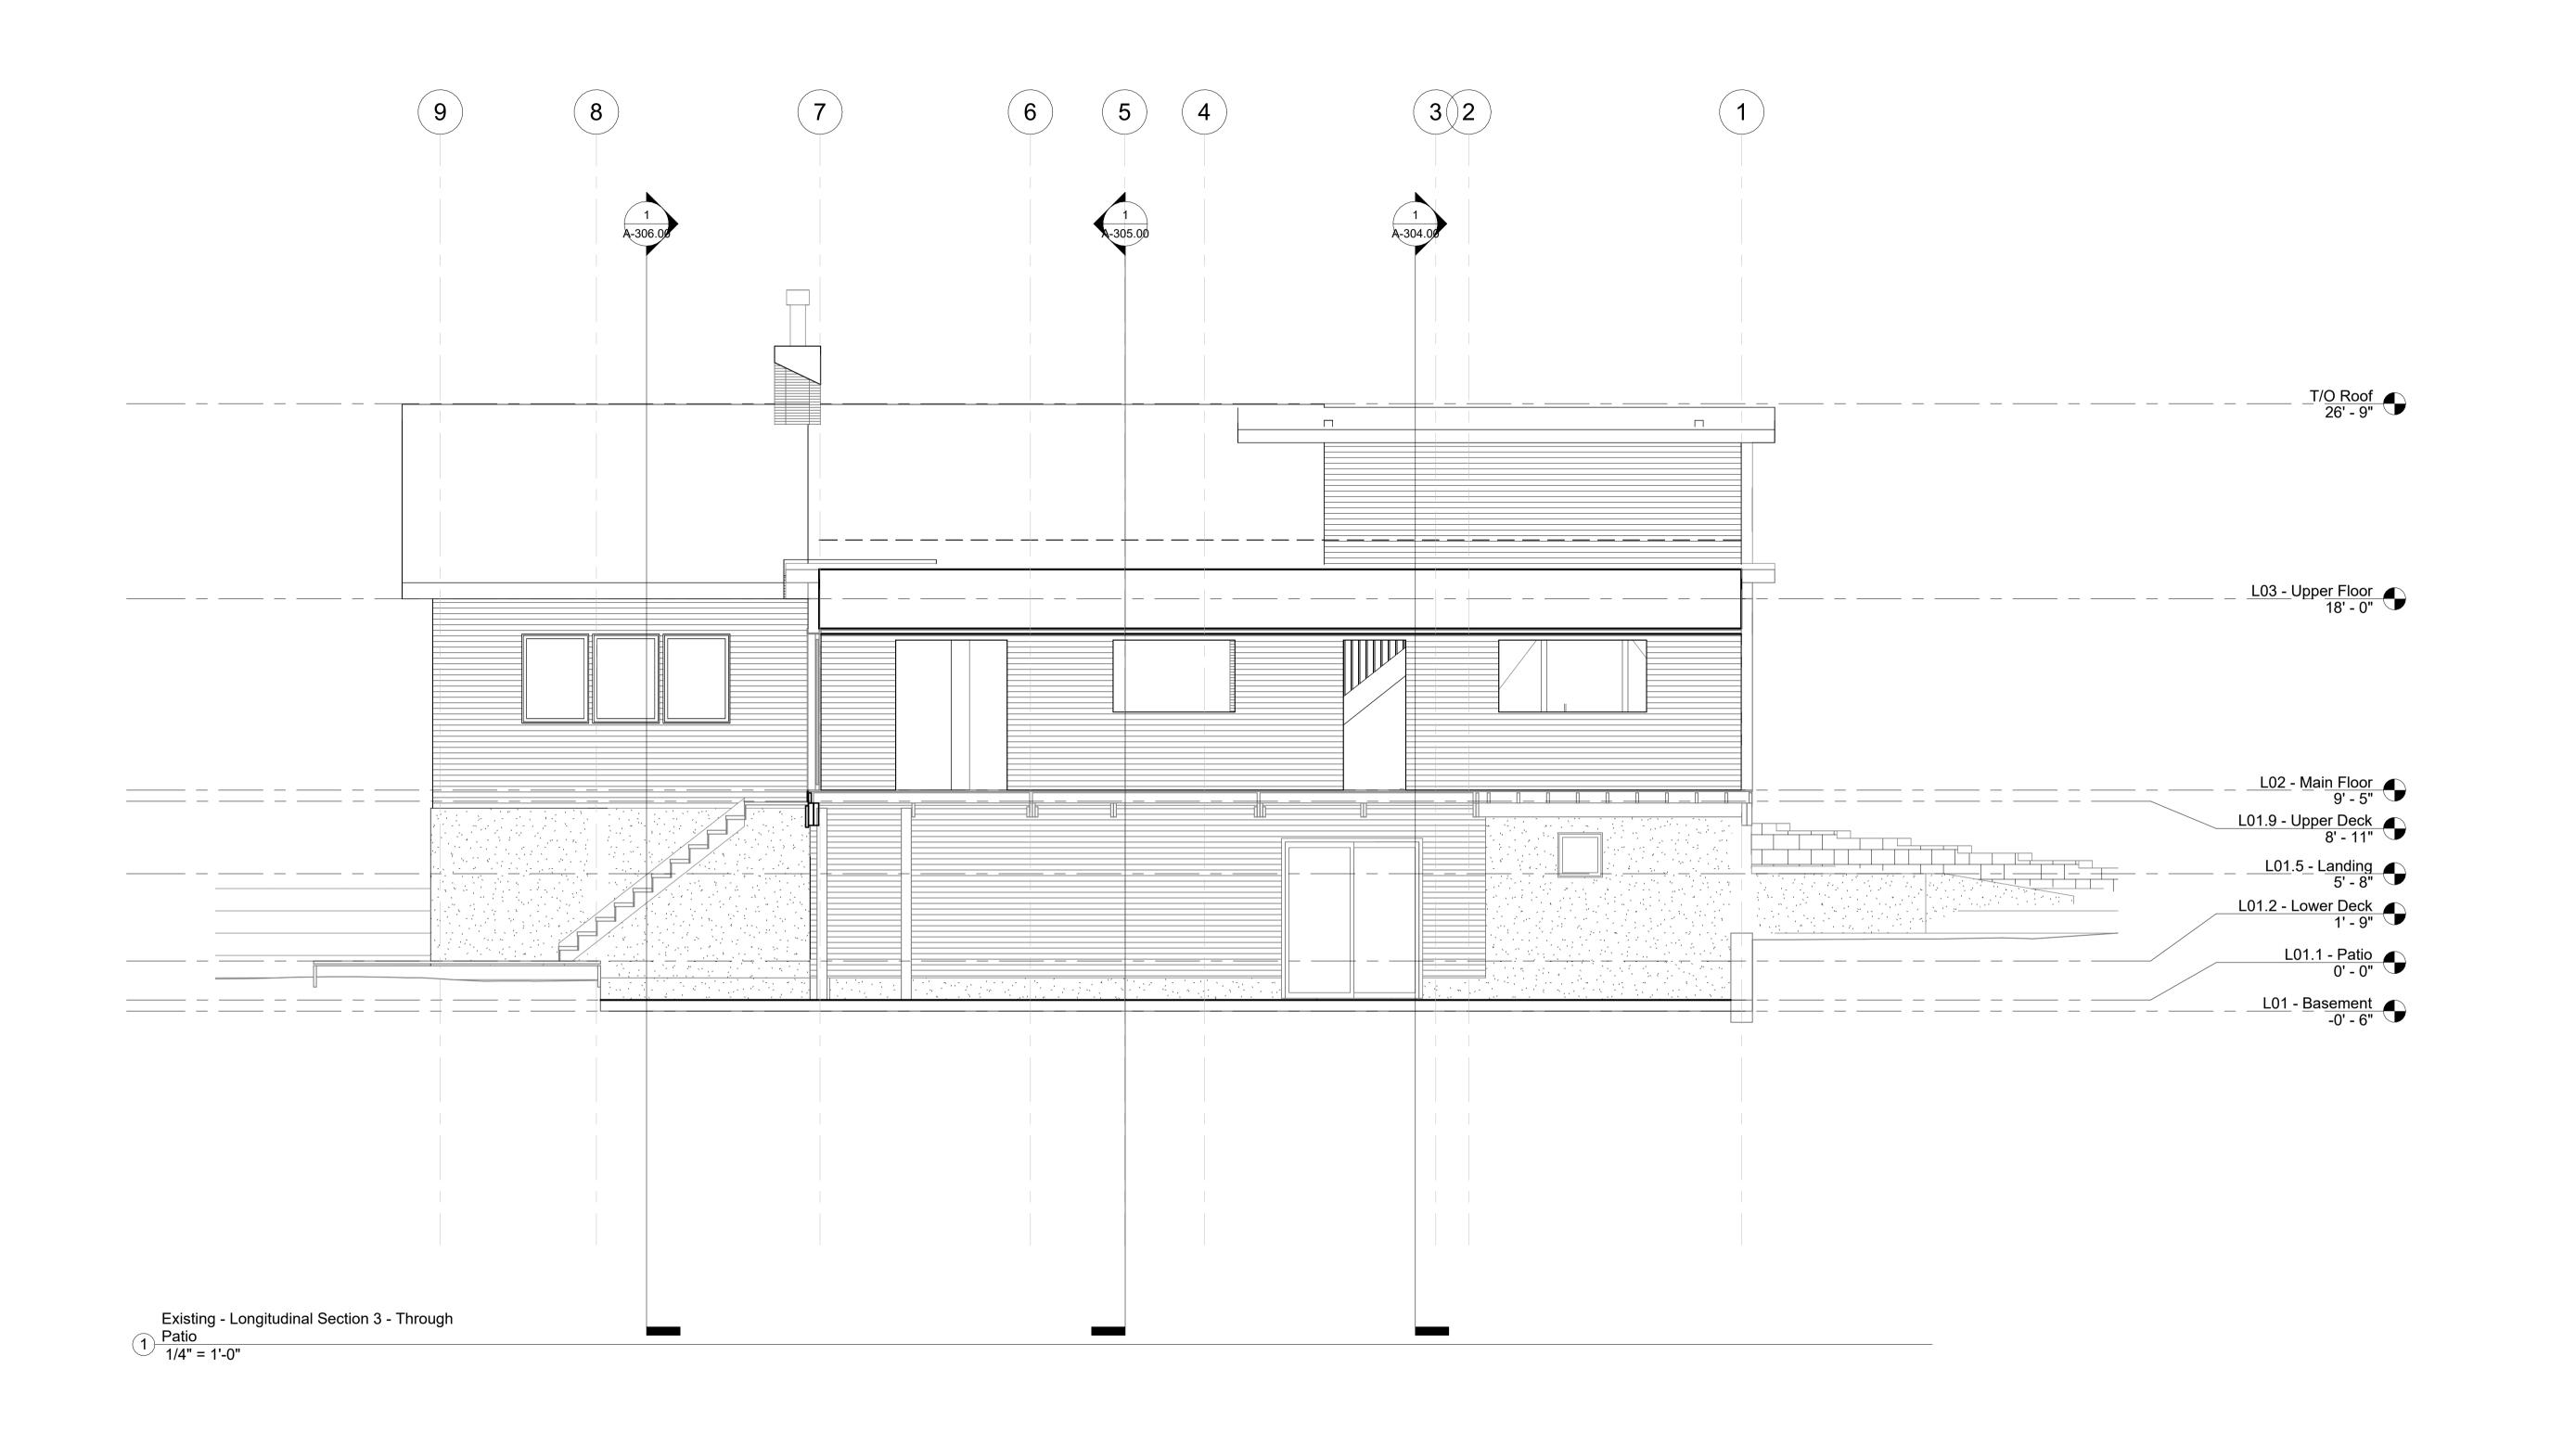

Robert & Sally Griffin 2712 N Magnolia Ave, Chicago, IL 60614

architectural designer:
Patrick Griffin 2712 N Magnolia Ave, Chicago, IL 60614


structural engineer:

civil engineer:

consultant:

Griffin Residence 7655 Lilly Lake Rd. Burlington, WI 53105

project number: PG-2023-001

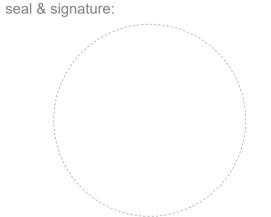

status: Not For Construction

issuance:
Rennovation Drawings V5

sheet number: 24 of 35

sheet revisions:

No. Date Description


key plan:

Longitudinal **Building Section 3**

drawn by: Patrick G 1/4" = 1'-0" 24 in × 36 in

12/19/2023 12:53:46 PM Do not scale. Check all dimensions on site.

A-303.00

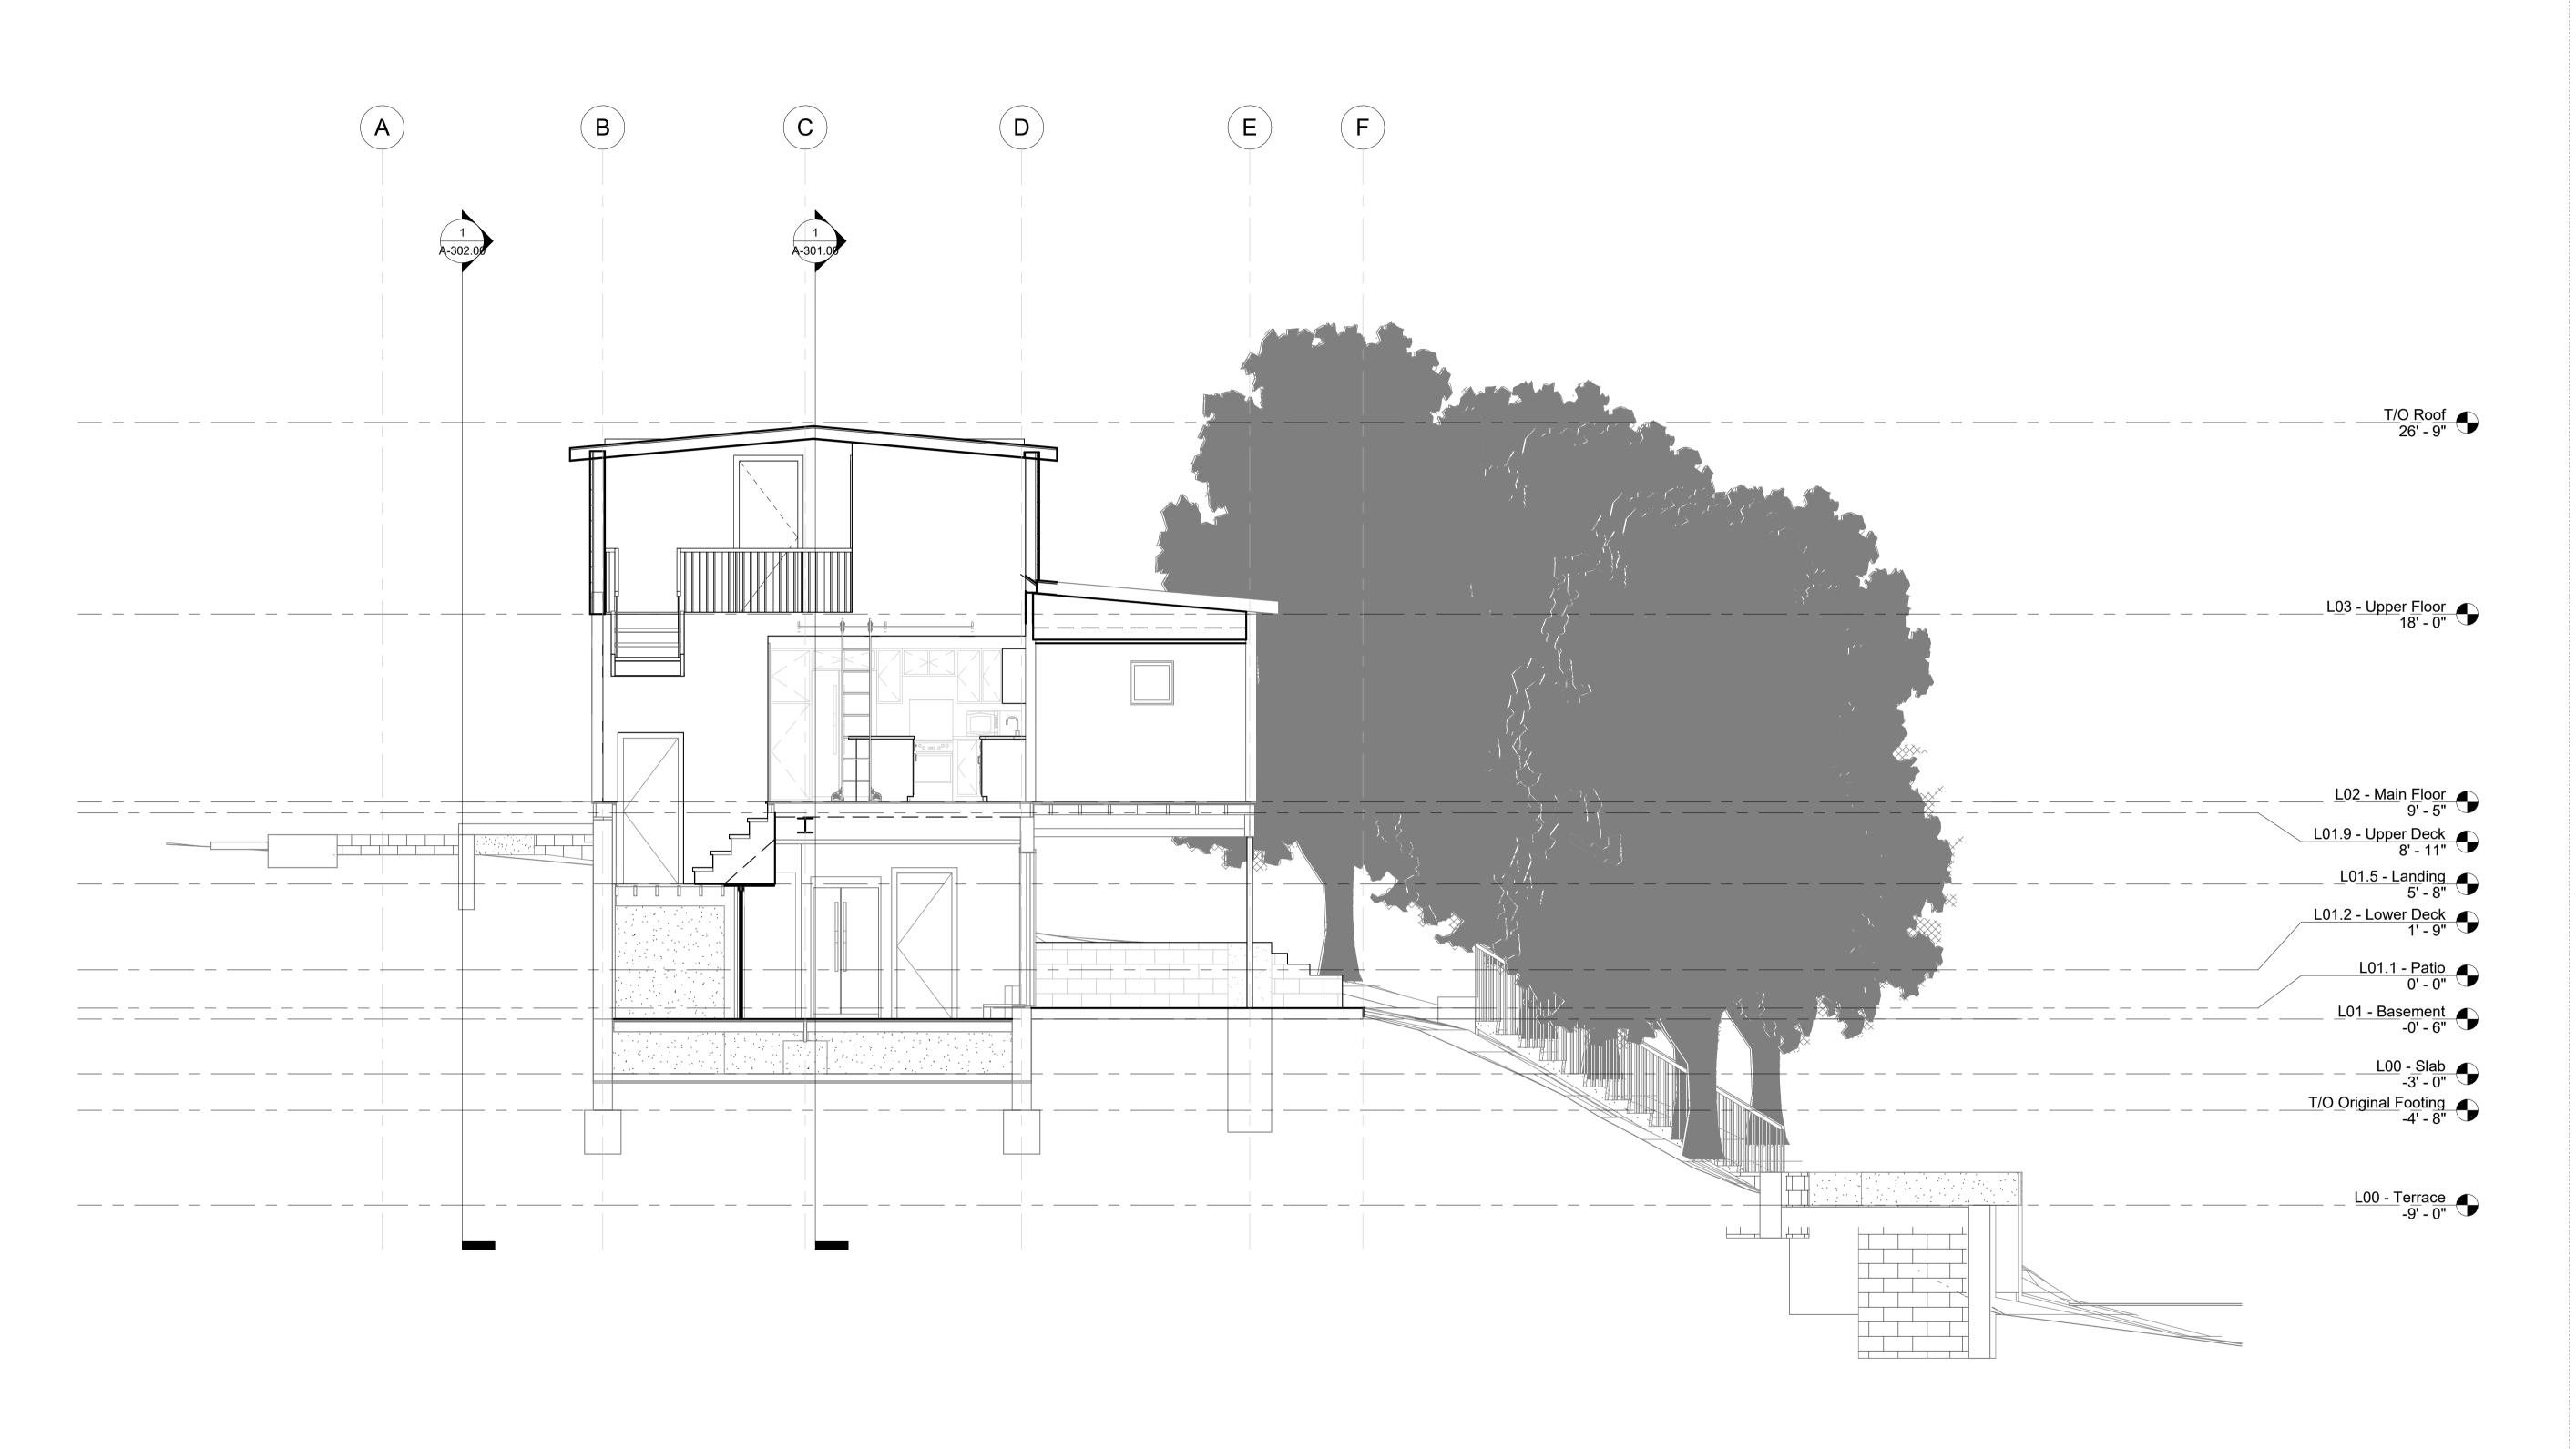

Existing - Transverse Section 1 - Through

Landing

1/4" = 1'-0"

Robert & Sally Griffin 2712 N Magnolia Ave, Chicago, IL 60614

architectural designer:
Patrick Griffin 2712 N Magnolia Ave, Chicago, IL 60614


structural engineer:

civil engineer:

consultant:

Griffin Residence 7655 Lilly Lake Rd. Burlington, WI 53105

project number: PG-2023-001

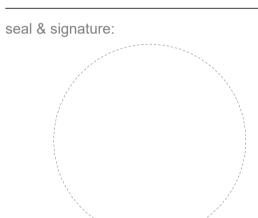

status:
Not For Construction

issuance:
Rennovation Drawings V5

sheet number: 25 of 35

sheet revisions:

No. Date Description


key plan:

Transverse Building Section 1

Patrick G 1/4" = 1'-0" 24 in × 36 in

12/19/2023 12:53:49 PM Do not scale. Check all dimensions on site.

A-304.00

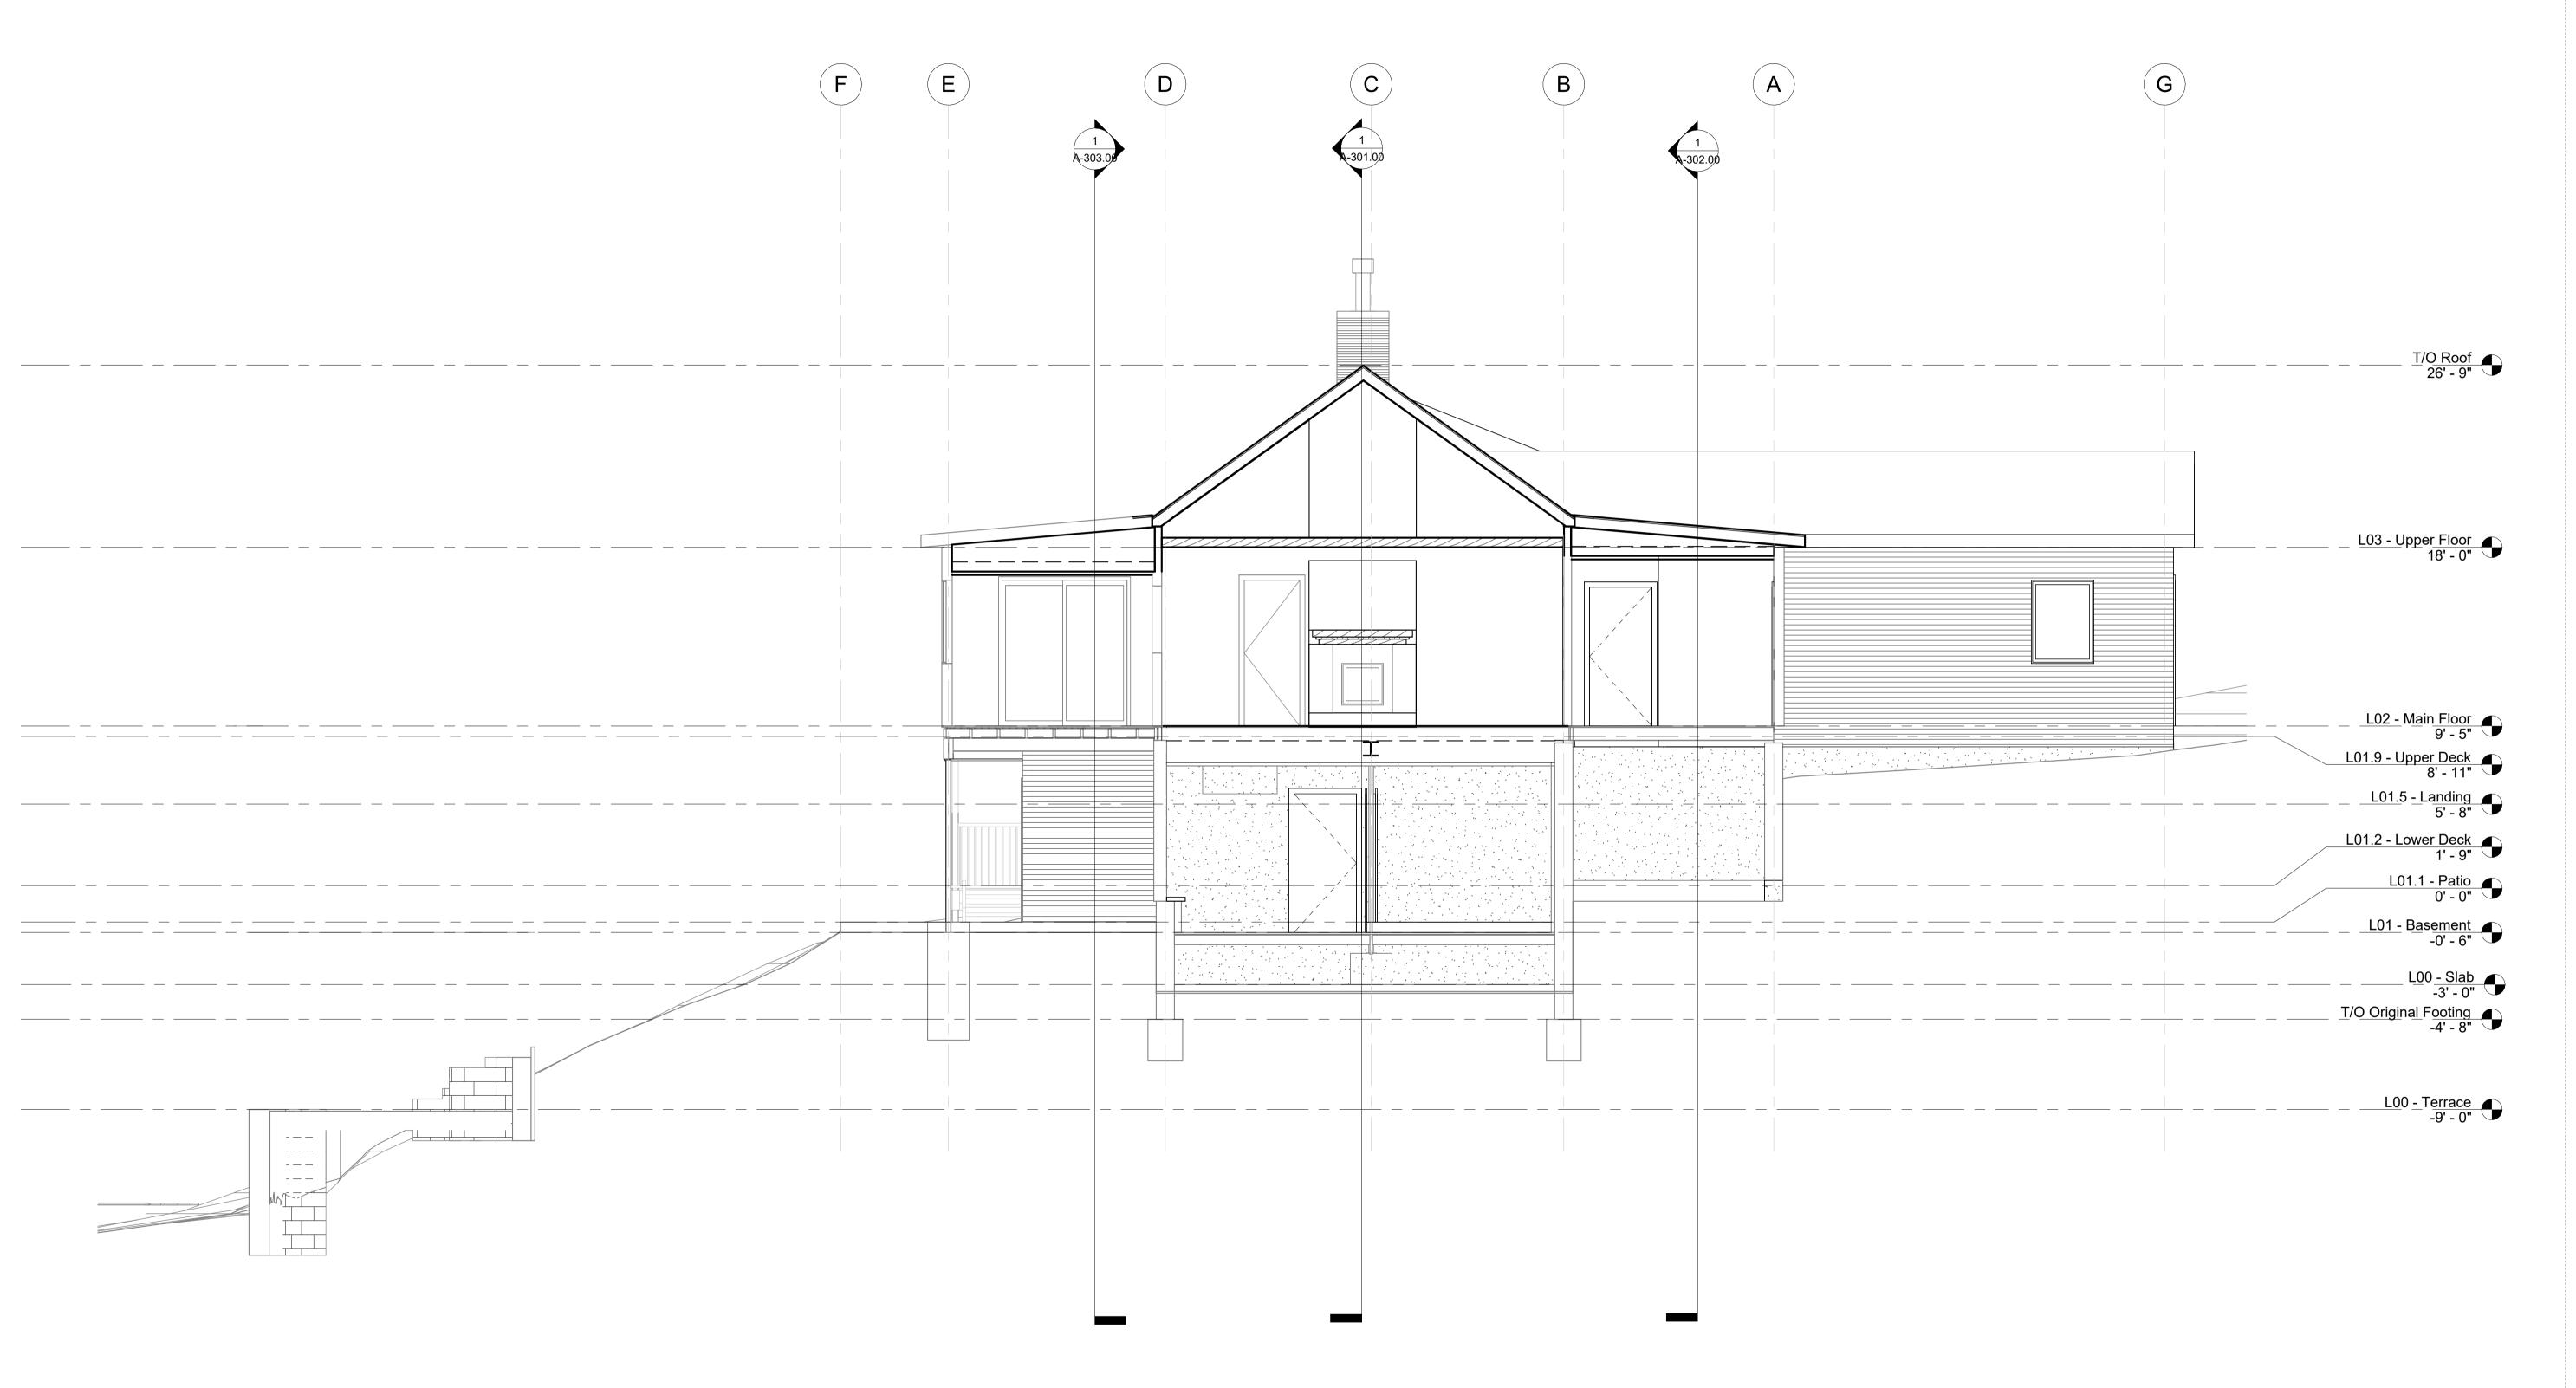

Existing - Transverse Section 2 - Showing

Mantle

1/4" = 1'-0"

client:

Robert & Sally Griffin 2712 N Magnolia Ave, Chicago, IL 60614

architectural designer: **Patrick Griffin**2712 N Magnolia Ave,
Chicago, IL 60614

structural engineer:


civil engineer:

consultant:

project name: **Griffin Residence**7655 Lilly Lake Rd.
Burlington, WI 53105

project number: **PG-2023-001**

seal & signature:

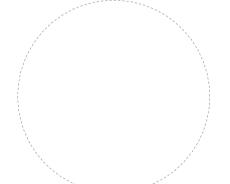

status:
Not For Construction

Rennovation Drawings V5

sheet number: 26 of 35

sheet revisions:

No. Date Description

key plan:

sheet ti

Transverse Building Section 2

drawn by: Patrick G
scale: 1/4" = 1'-0"
size: 24 in × 36 in
date: 12/19/2023 12:53:51 PM

Do not scale. Check all dimensions on site.

sheet number: **A-305.00**



Existing - Transverse Section 2 - Showing

Mantle Copy 1

1/4" = 1'-0"

Robert & Sally Griffin 2712 N Magnolia Ave, Chicago, IL 60614

architectural designer:
Patrick Griffin 2712 N Magnolia Ave, Chicago, IL 60614


structural engineer:

civil engineer:

consultant:

Griffin Residence 7655 Lilly Lake Rd. Burlington, WI 53105

project number: PG-2023-001

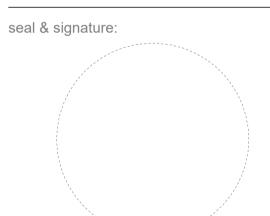

status:
Not For Construction

issuance:
Rennovation Drawings V5

sheet number: 27 of 35

sheet revisions:

No. Date Description

key plan:

Transverse Building Section 3

Patrick G 24 in × 36 in

12/19/2023 12:53:54 PM Do not scale. Check all dimensions on site.

A-306.00

RENOVATIONDRAWINGS $\left(\mathbf{C}\right)$ \circ \circ $\left(\mathsf{D}\right)$ 1 Existing - L02 - Enlarged Kitchen Plan 1" = 1'-0"

client: **Robert & Sally Griffin**2712 N Magnolia Ave,

Chicago, IL 60614

chicago, IL 60614

architectural designer:

Patrick Griffin

2712 N Magnolia Ave, Chicago, IL 60614

structural engineer:

civil engineer:


consultant:

project name:

Griffin Residence 7655 Lilly Lake Rd. Burlington, WI 53105

project number: **PG-2023-001**

seal & signature:

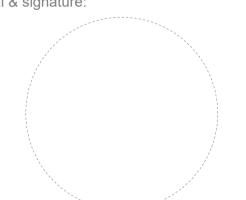

status:
Not For Construction

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Rennovation Drawings V5
sheet number:
28 of 35

sheet revision

sheet revisions:

No. Date Description

key plan:

sheet title

Enlarged Plans & Details


drawn by: Patrick G scale: 1" = 1'-0" size: 24 in × 36 in

te: 12/19/2023 12:53:55 PM

Do not scale. Check all dimensions on site.

eet number:

A-401.00

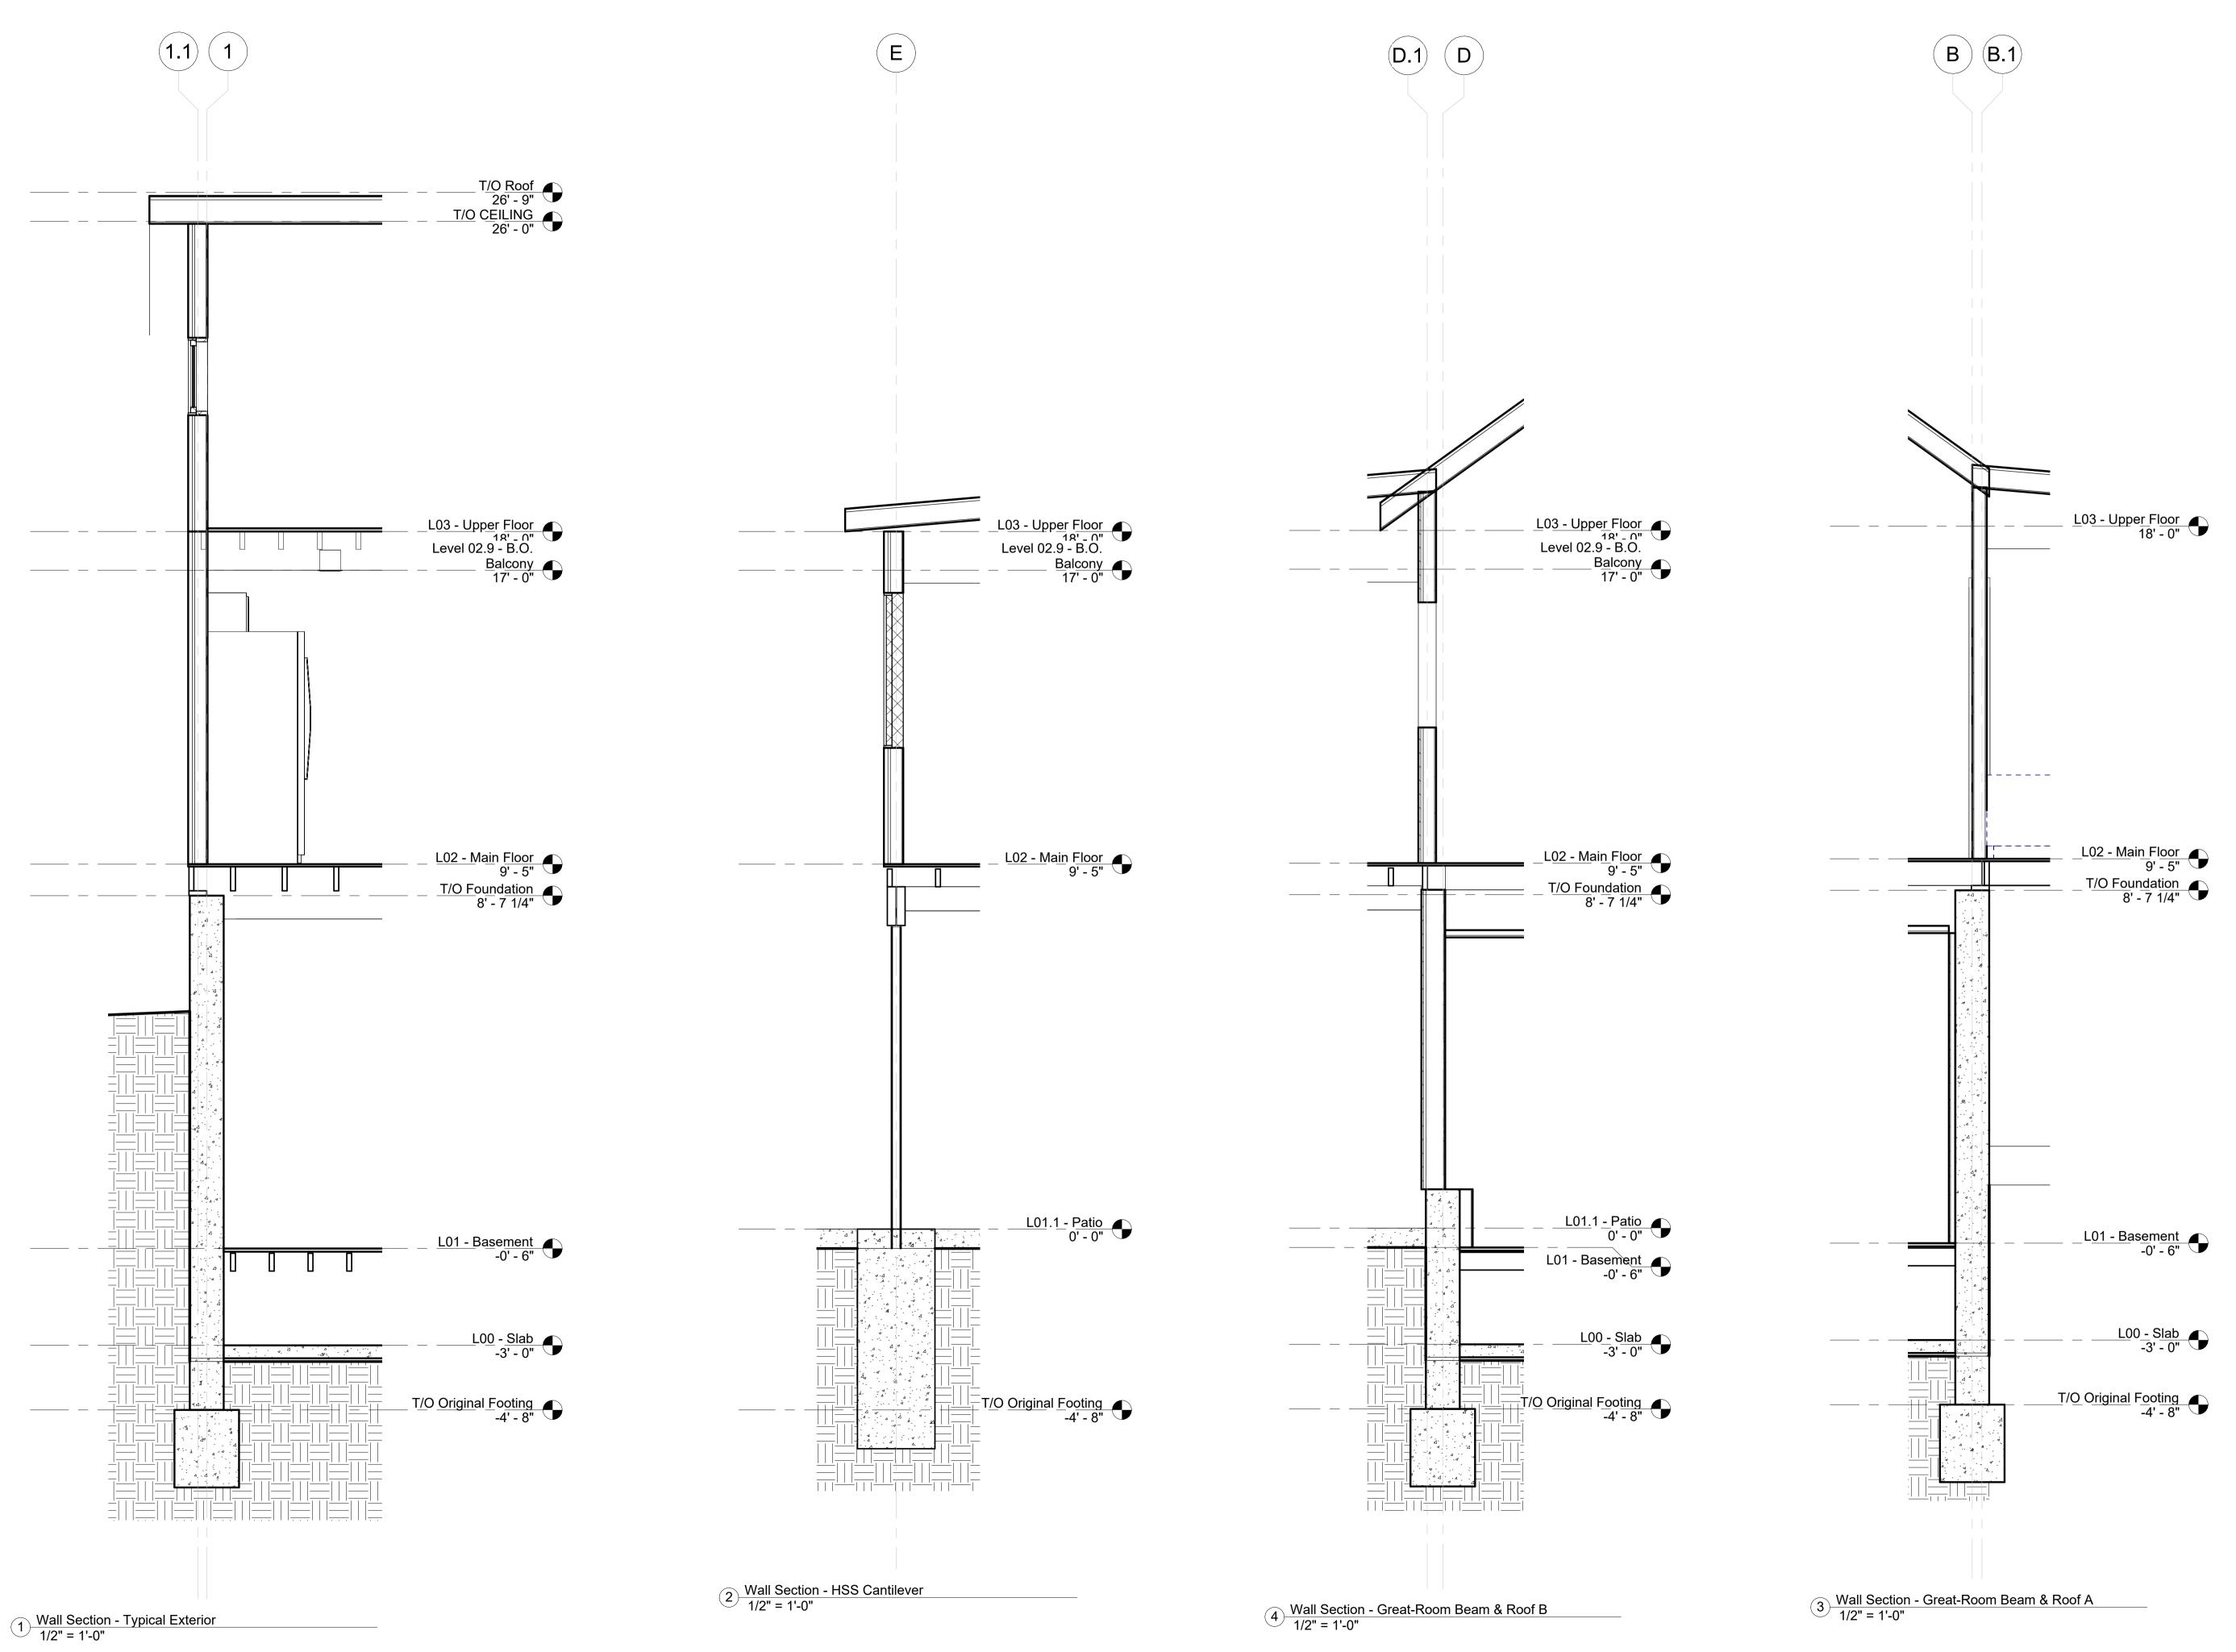

Robert & Sally Griffin 2712 N Magnolia Ave, Chicago, IL 60614 architectural designer:
Patrick Griffin 2712 N Magnolia Ave, Chicago, IL 60614 structural engineer: civil engineer: consultant: project name: Griffin Residence 7655 Lilly Lake Rd. Burlington, WI 53105 project number: PG-2023-001 seal & signature: **Not For Construction** Rennovation Drawings V5 sheet number: 29 of 35 sheet revisions: No. Date Description

key plan:

Wall Sections and Details

drawn by: Patrick G
scale: 1/2" = 1'-0"
size: 24 in × 36 in
date: 12/19/2023 12:53:57 PM

Do not scale. Check all dimensions on site.

sheet nun

A-501.00

Robert & Sally Griffin 2712 N Magnolia Ave, Chicago, IL 60614

architectural designer:
Patrick Griffin 2712 N Magnolia Ave, Chicago, IL 60614

structural engineer:


civil engineer:

consultant:

project name: Griffin Residence 7655 Lilly Lake Rd. Burlington, WI 53105

project number: PG-2023-001

seal & signature:

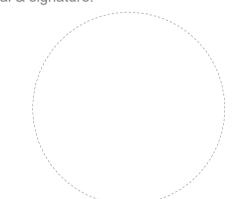

Not For Construction

issuance:
Rennovation Drawings V5

sheet number: 30 of 35

sheet revisions:

No. Date Description

key plan:

Assorted Detail Drawings

drawn by: Patrick G

24 in × 36 in 12/19/2023 12:53:57 PM

Do not scale. Check all dimensions on site.

A-502.00

DOOR SCHEDULE (RENOVATED)

MARK	USE	TYPE	WIDTH	HEIGHT	FRAME TYPE	DOOR HARDWARE	NOTES
121A	Interior Door	Single Flush 36"x80"	3' - 0"	6' - 8"			
122A	Interior Door	Single Flush 36"x80"	3' - 0"	6' - 8"			
L01 - Ba	asement: 2						
221B	Interior Door	Single Flush 36"x80"	3' - 0"	6' - 8"			
222	Interior Door	Single Flush 36"x80"	3' - 0"	6' - 8"			
228	Exterior Door	Overhead Rolling: 192'x80"	16' - 0"	7' - 0"			
323B	Interior Door	Single Flush 36"x80"	3' - 0"	6' - 8"			
323C	Interior Door	Dual Sliding: 60"x80"	5' - 0"	7' - 0"			
323D	Interior Door	Single Flush 36"x80"	3' - 0"	6' - 8"			
323E			4' - 6"	7' - 0"			
L02 - M	ain Floor: 7						"
323F			2' - 8"	7' - 0"			
323G			2' - 8"	7' - 0"			
323H	Interior Door	Dual Sliding: 60"x80"	5' - 0"	7' - 0"			
323I	Interior Door	Dual Sliding: 60"x80"	5' - 0"	7' - 0"			
_03 - U	pper Floor: 4						<u>'</u>

RENOVATION DRAWINGS

WINDOW SCHEDULE (RENOVATED)

					,					
MARK	TAG	SIZE	TYPE	WIDTH	HEIGHT	Thermal Resistance (R)	Heat Transfer Coefficient (U)	Solar Heat Gain Coefficient	Visual Light Transmittance	Comments
,										
221A	10	36" x 48"	CASEMENT WINDOW	3' - 0"	4' - 0"	1.5394 (h·ft²·°F)/BTU	0.6496 BTU/(h·ft²·°F)	0.78	0.9	
221B	10	36" x 48"	CASEMENT WINDOW	3' - 0"	4' - 0"	1.5394 (h·ft²·°F)/BTU	0.6496 BTU/(h·ft²·°F)	0.78	0.9	
221C	10	36" x 48"	CASEMENT WINDOW	3' - 0"	4' - 0"	1.5394 (h·ft²·°F)/BTU	0.6496 BTU/(h·ft²·°F)	0.78	0.9	
221D	10	36" x 48"	CASEMENT WINDOW	3' - 0"	4' - 0"	1.5394 (h·ft²·°F)/BTU	0.6496 BTU/(h·ft²·°F)	0.78	0.9	
222A	10	36" x 48"	CASEMENT WINDOW	3' - 0"	4' - 0"	1.5394 (h·ft²·°F)/BTU	0.6496 BTU/(h·ft²·°F)	0.78	0.9	
228A	10	36" x 48"	CASEMENT WINDOW	3' - 0"	4' - 0"	1.5394 (h·ft²·°F)/BTU	0.6496 BTU/(h·ft²·°F)	0.78	0.9	
228B	10	36" x 48"	CASEMENT WINDOW	3' - 0"	4' - 0"	1.5394 (h·ft²·°F)/BTU	0.6496 BTU/(h·ft²·°F)	0.78	0.9	
228C	10	36" x 48"	CASEMENT WINDOW	3' - 0"	4' - 0"	1.5394 (h·ft²·°F)/BTU	0.6496 BTU/(h·ft²·°F)	0.78	0.9	
228D	10	36" x 48"	CASEMENT WINDOW	3' - 0"	4' - 0"	1.5394 (h·ft²·°F)/BTU	0.6496 BTU/(h·ft²·°F)	0.78	0.9	
	-				1	, ,	, ,			

L02 - Main Floor: 9

WALL SCHEDULE (RENOVATED)

BASE LEVEL	MARK TAG	DESCRIPTION	STRUCTURAL	FINISH 1	CORE	FINISH 2	THICKNESS	HEIGHT	LENGTH
T/O Original Footing	03	Concrete Foundation Wall	Bearing	N/A	10.5" Concrete with Rebar	Dampproofing, 2" Rigid Insulation	10.5"	13' - 3 1/4"	6' - 9 7/8"
T/O Original Footing	03	Concrete Foundation Wall	Bearing	N/A	10.5" Concrete with Rebar	Dampproofing, 2" Rigid Insulation	10.5"	13' - 3 1/4"	7' - 0 3/4"
T/O Original Footing	03	Concrete Foundation Wall	Bearing	N/A	10.5" Concrete with Rebar	Dampproofing, 2" Rigid Insulation	10.5"	13' - 3 1/4"	29' - 2 3/4
Γ/O Original Footing: 3			<u> </u>	1.3.2.2					
_01 - Basement	09	Interior Partition	Non-bearing	5/8" Gypsum Boa	ard 4" Wood Stud	5/8" Gypsum Board	4 7/8"	0' - 6"	9' - 5 1/4'
_01 - Basement	09	Interior Partition	Non-bearing	<u> </u>	ard 4" Wood Stud	5/8" Gypsum Board	4 7/8"	0' - 6"	9' - 3"
_01 - Basement: 2				, ,,				l	
Γ/O West Footing	03	Concrete Foundation Wall	Bearing	N/A	10.5" Concrete with Rebar	Dampproofing, 2" Rigid Insulation	10.5"	6' - 7 1/4"	18' - 9 3/8
7/O West Footing	03	Concrete Foundation Wall	Bearing	N/A	10.5" Concrete with Rebar	Dampproofing, 2" Rigid Insulation	10.5"	6' - 1 1/4"	20' - 0"
O West Footing	03	Concrete Foundation Wall	Bearing	N/A	10.5" Concrete with Rebar	Dampproofing, 2" Rigid Insulation	10.5"	6' - 7 1/4"	18' - 9 3/8
7/O West Footing: 3	1	1			'				
.02 - Main Floor			Non-bearing					9' - 7"	3' - 4 5/8
.02 - Main Floor			Non-bearing					9' - 7"	5' - 7 5/8
.02 - Main Floor	06	Exterior Wall	Bearing	5/8" Gypsum Boa	ard 6" Wood Stud / Insulation	3/4" Plywood, Vapor Barrier, Cement-Board Siding	8 1/8"	9' - 7"	16' - 9"
02 - Main Floor	06	Exterior Wall	Non-bearing	5/8" Gypsum Boa	ard 6" Wood Stud / Insulation	3/4" Plywood, Vapor Barrier, Cement-Board Siding	8 1/8"	9' - 7"	29' - 6 3/4
02 - Main Floor	06	Exterior Wall	Non-bearing	5/8" Gypsum Boa	ard 6" Wood Stud / Insulation	3/4" Plywood, Vapor Barrier, Cement-Board Siding	8 1/8"	9' - 7"	20' - 3 3/8
.02 - Main Floor	06	Exterior Wall	Non-bearing	5/8" Gypsum Boa	ard 6" Wood Stud / Insulation	3/4" Plywood, Vapor Barrier, Cement-Board Siding	8 1/8"	9' - 7"	18' - 7"
.02 - Main Floor	06	Exterior Wall	Non-bearing	5/8" Gypsum Boa	ard 6" Wood Stud / Insulation	3/4" Plywood, Vapor Barrier, Cement-Board Siding	8 1/8"	9' - 7"	18' - 7 1/2
.02 - Main Floor	06	Exterior Wall	Non-bearing	5/8" Gypsum Boa	ard 6" Wood Stud / Insulation	3/4" Plywood, Vapor Barrier, Cement-Board Siding	8 1/8"	9' - 7"	7' - 0"
.02 - Main Floor	06	Exteriror Wall (No Siding)	Bearing	5/8" Gypsum Boa	ard 6" Wood Stud / Insulation	N/A	6 7/8"	8' - 7"	20' - 3 3/8
.02 - Main Floor	06	Exteriror Wall (No Siding)	Non-bearing	5/8" Gypsum Boa	ard 6" Wood Stud / Insulation	N/A	6 7/8"	9' - 7"	10' - 1 5/8
.02 - Main Floor	06	Exteriror Wall (No Siding)	Non-bearing	5/8" Gypsum Boa	ard 6" Wood Stud / Insulation	N/A	6 7/8"	8' - 7"	19' - 5 3/8
.02 - Main Floor	09	Interior Partition	Non-bearing	5/8" Gypsum Boa	ard 4" Wood Stud	5/8" Gypsum Board	4 7/8"	8' - 7"	6' - 8 1/4
.02 - Main Floor	09	Interior Partition	Non-bearing	5/8" Gypsum Boa	ard 4" Wood Stud	5/8" Gypsum Board	4 7/8"	8' - 7"	16' - 9"
.02 - Main Floor: 13			-	-	<u>'</u>			1	
.03 - Upper Floor			Non-bearing					8' - 0"	11' - 9 7/8
.03 - Upper Floor			Non-bearing					8' - 0"	8' - 4 3/4
.03 - Upper Floor			Non-bearing					8' - 0"	12' - 2 5/8
.03 - Upper Floor			Non-bearing					7' - 7 1/4"	8' - 0 3/8
03 - Upper Floor			Non-bearing					8' - 0"	8' - 0 3/8
03 - Upper Floor			Non-bearing					9' - 0"	3' - 0"
.03 - Upper Floor			Non-bearing					9' - 0"	2' - 11 5/8
.03 - Upper Floor	06	Exterior Wall	Non-bearing	5/8" Gypsum Boa	ard 6" Wood Stud / Insulation	3/4" Plywood, Vapor Barrier, Cement-Board Siding	8 1/8"	7' - 5 3/8"	18' - 9 1/4
_03 - Upper Floor	06	Exterior Wall	Non-bearing		ard 6" Wood Stud / Insulation	3/4" Plywood, Vapor Barrier, Cement-Board Siding	8 1/8"	7' - 4 3/4"	18' - 9 1/4

Robert & Sally Griffin 2712 N Magnolia Ave, Chicago, IL 60614

architectural designer:
Patrick Griffin 2712 N Magnolia Ave, Chicago, IL 60614

structural engineer:


civil engineer:

consultant:

project name: Griffin Residence 7655 Lilly Lake Rd.

Burlington, WI 53105

project number: PG-2023-001

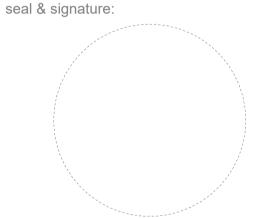

Not For Construction

Rennovation Drawings V5

sheet number: 31 of 35

sheet revisions:

No. Date

Description

key plan:

sheet title:


Wall, Door, & Window Schedules

drawn by: Patrick G

24 in × 36 in 12/19/2023 12:53:58 PM

Do not scale. Check all dimensions on site.

A-601.00

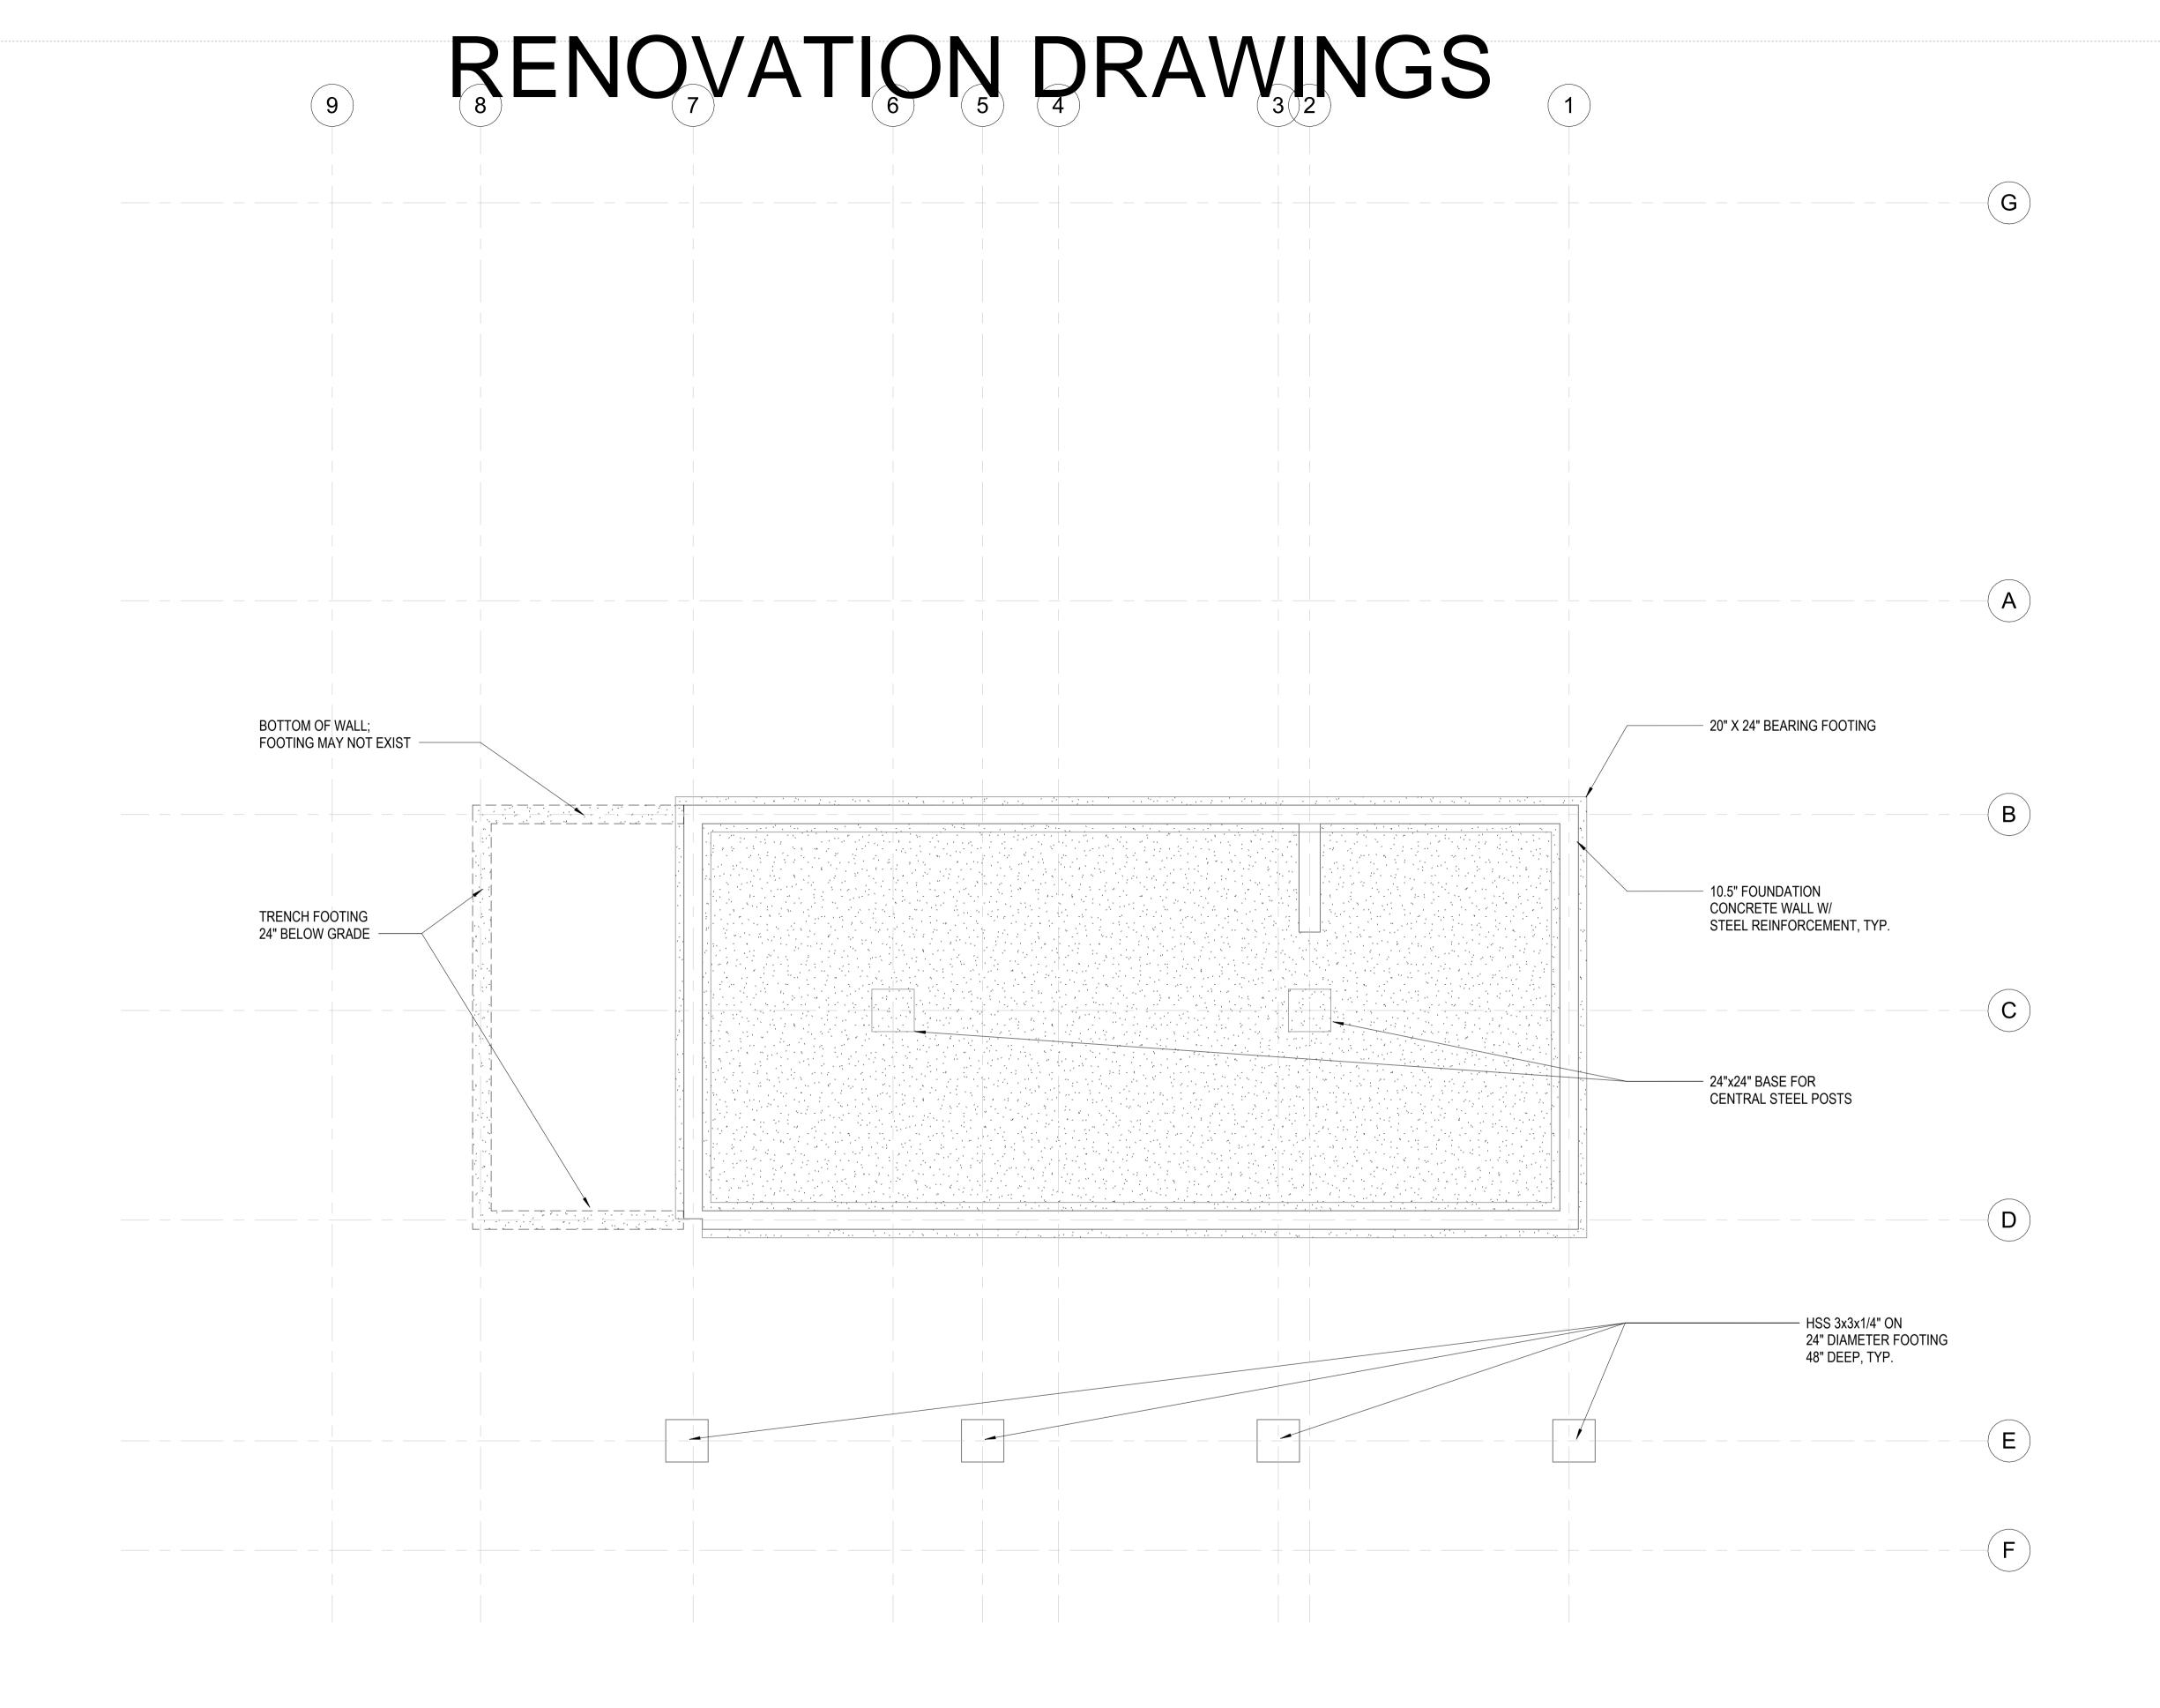

1 L00 - Slab 1/4" = 1'-0"

Robert & Sally Griffin 2712 N Magnolia Ave, Chicago, IL 60614

architectural designer:
Patrick Griffin 2712 N Magnolia Ave, Chicago, IL 60614

structural engineer:


civil engineer:

consultant:

project name: Griffin Residence 7655 Lilly Lake Rd. Burlington, WI 53105

project number: PG-2023-001

seal & signature:

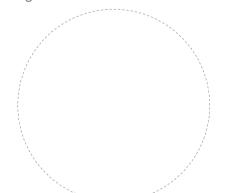

Not For Construction

Rennovation Drawings V5

sheet number: 32 of 35

sheet revisions: No. Date Description

key plan:


sheet title:

Building Foundation Plan

Patrick G drawn by: 1/4" = 1'-0" 24 in × 36 in

12/19/2023 12:54:00 PM Do not scale. Check all dimensions on site.

sheet number: **S-100.00**

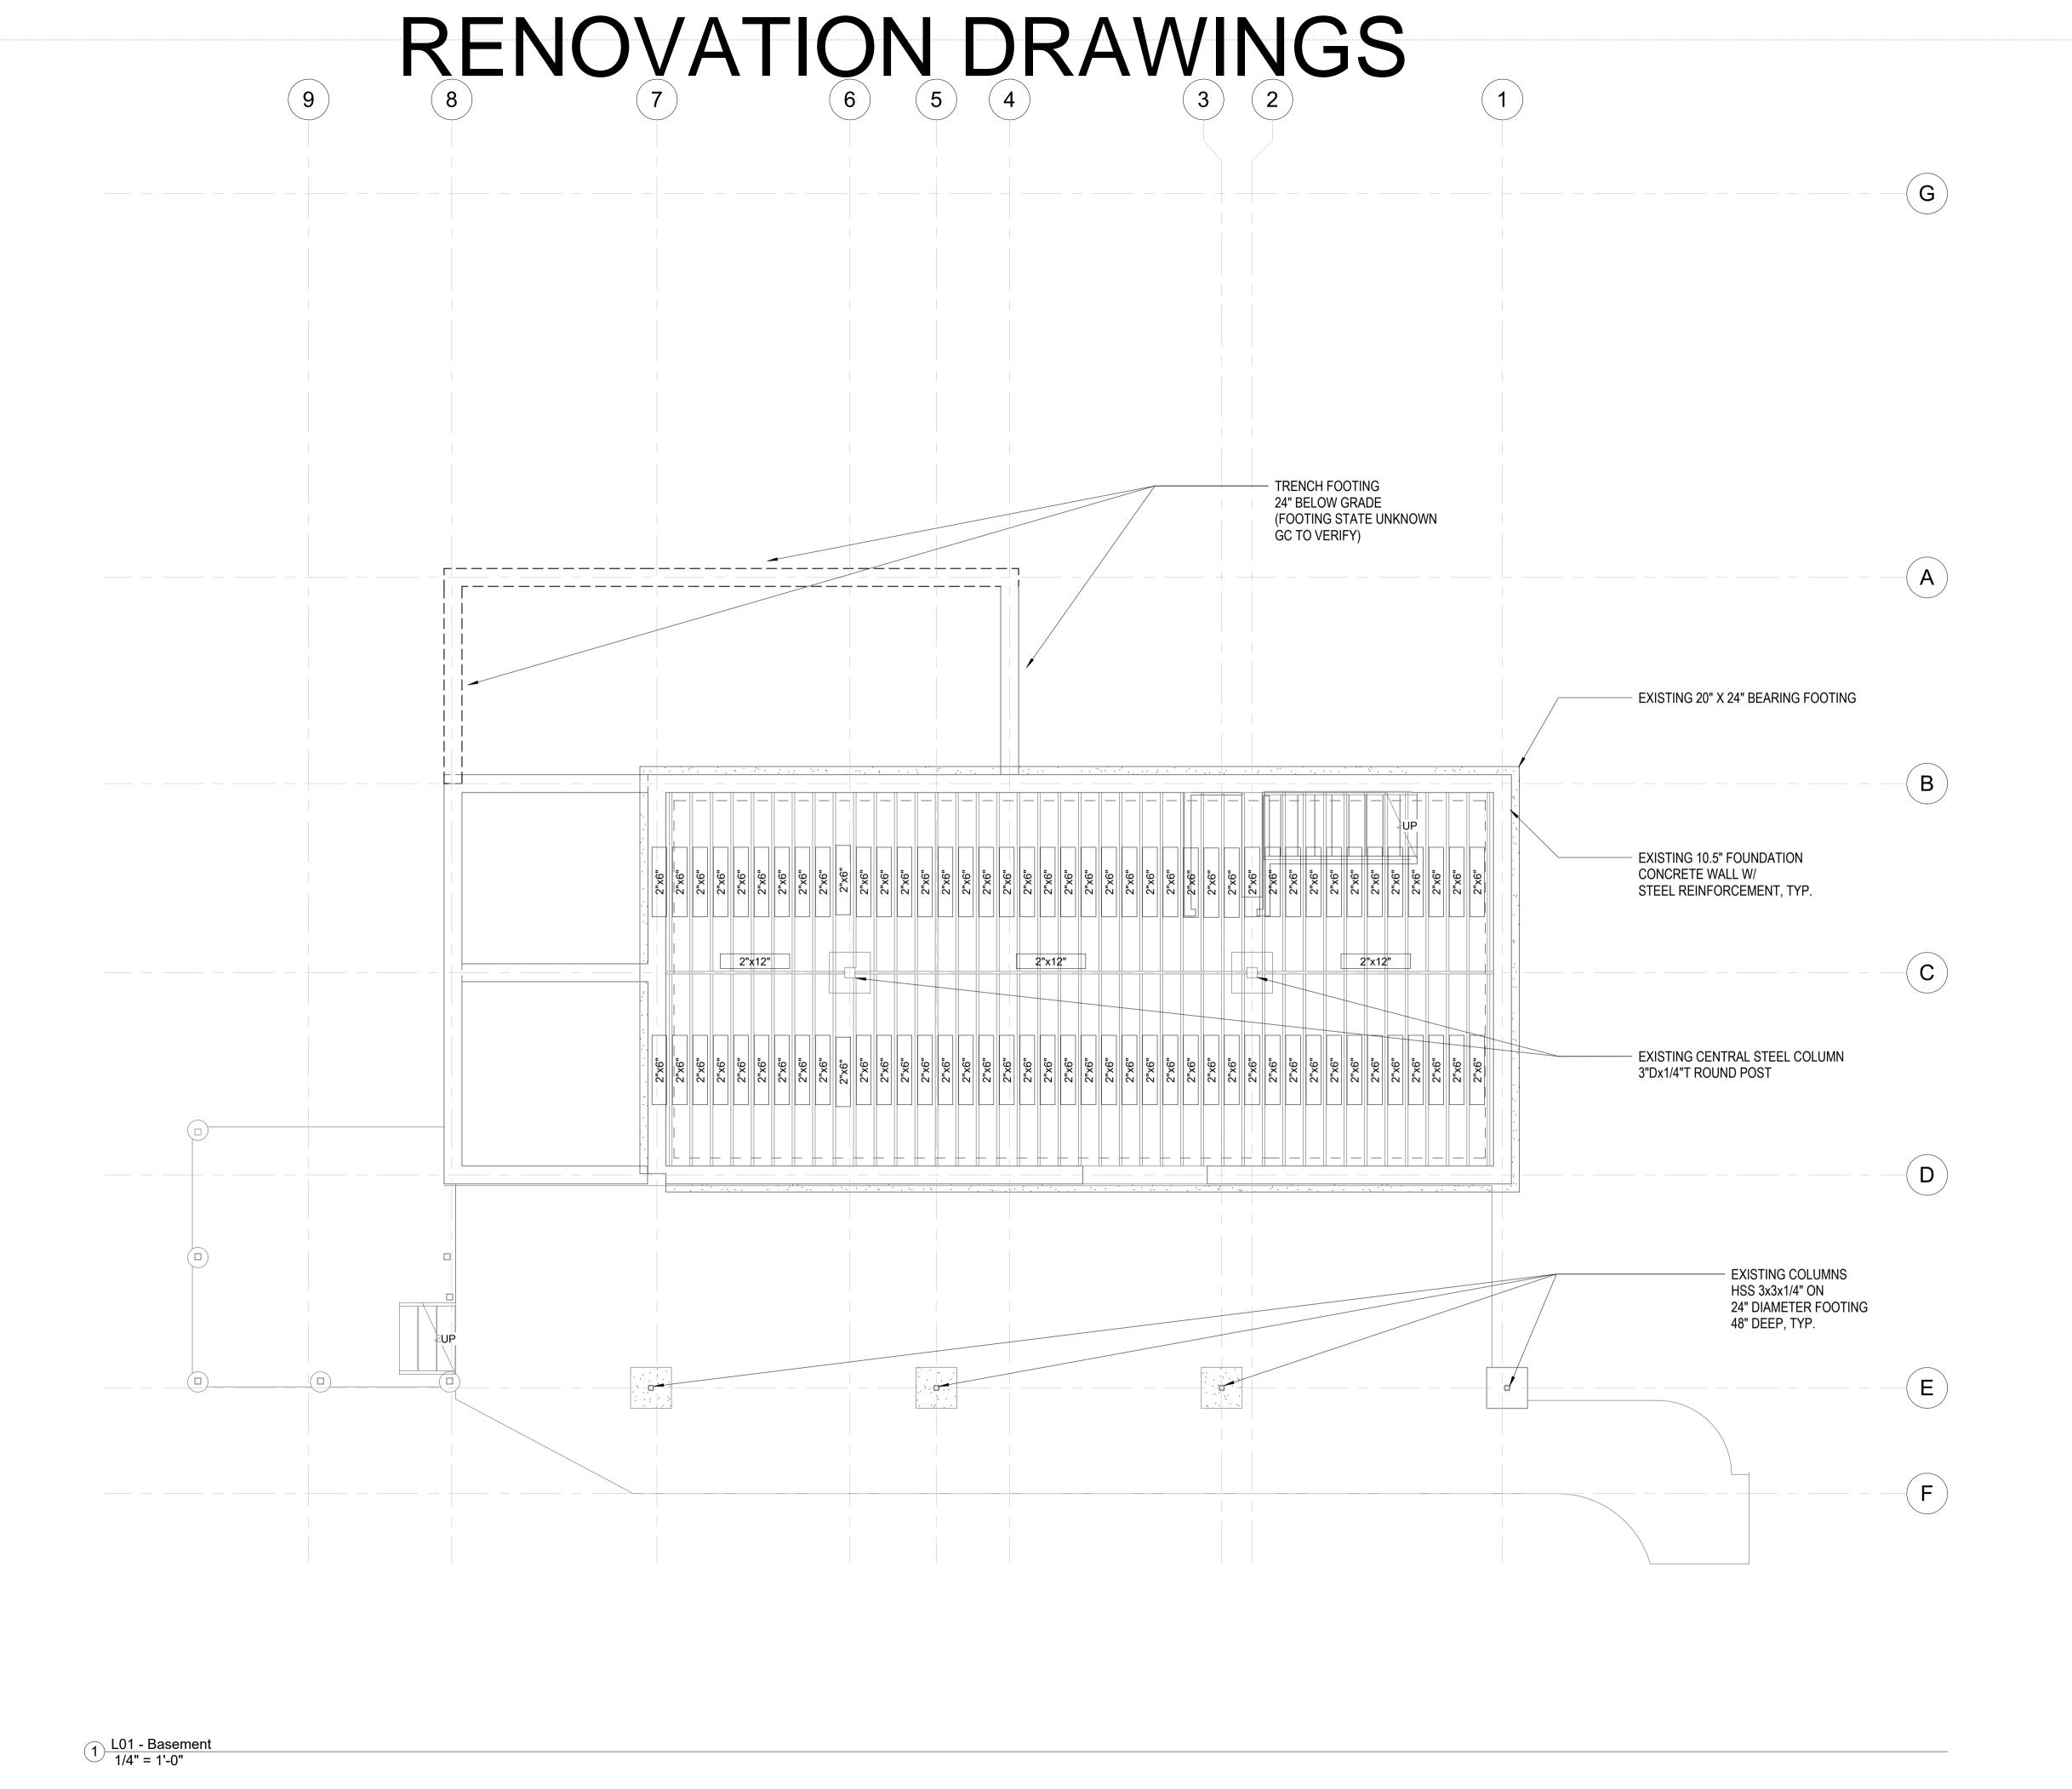

Robert & Sally Griffin 2712 N Magnolia Ave, Chicago, IL 60614 architectural designer:
Patrick Griffin 2712 N Magnolia Ave, Chicago, IL 60614 structural engineer: civil engineer: consultant: project name: Griffin Residence 7655 Lilly Lake Rd. Burlington, WI 53105 project number: PG-2023-001 seal & signature: **Not For Construction** Rennovation Drawings V5 sheet number: 33 of 35 sheet revisions: No. Date Description


key plan:

sheet tit

Level 1 Framing Plan

drawn by: Patrick G
scale: 1/4" = 1'-0"
size: 24 in × 36 in
date: 12/19/2023 12:54:02 PM
Do not scale. Check all dimensions on site.

S-101.00

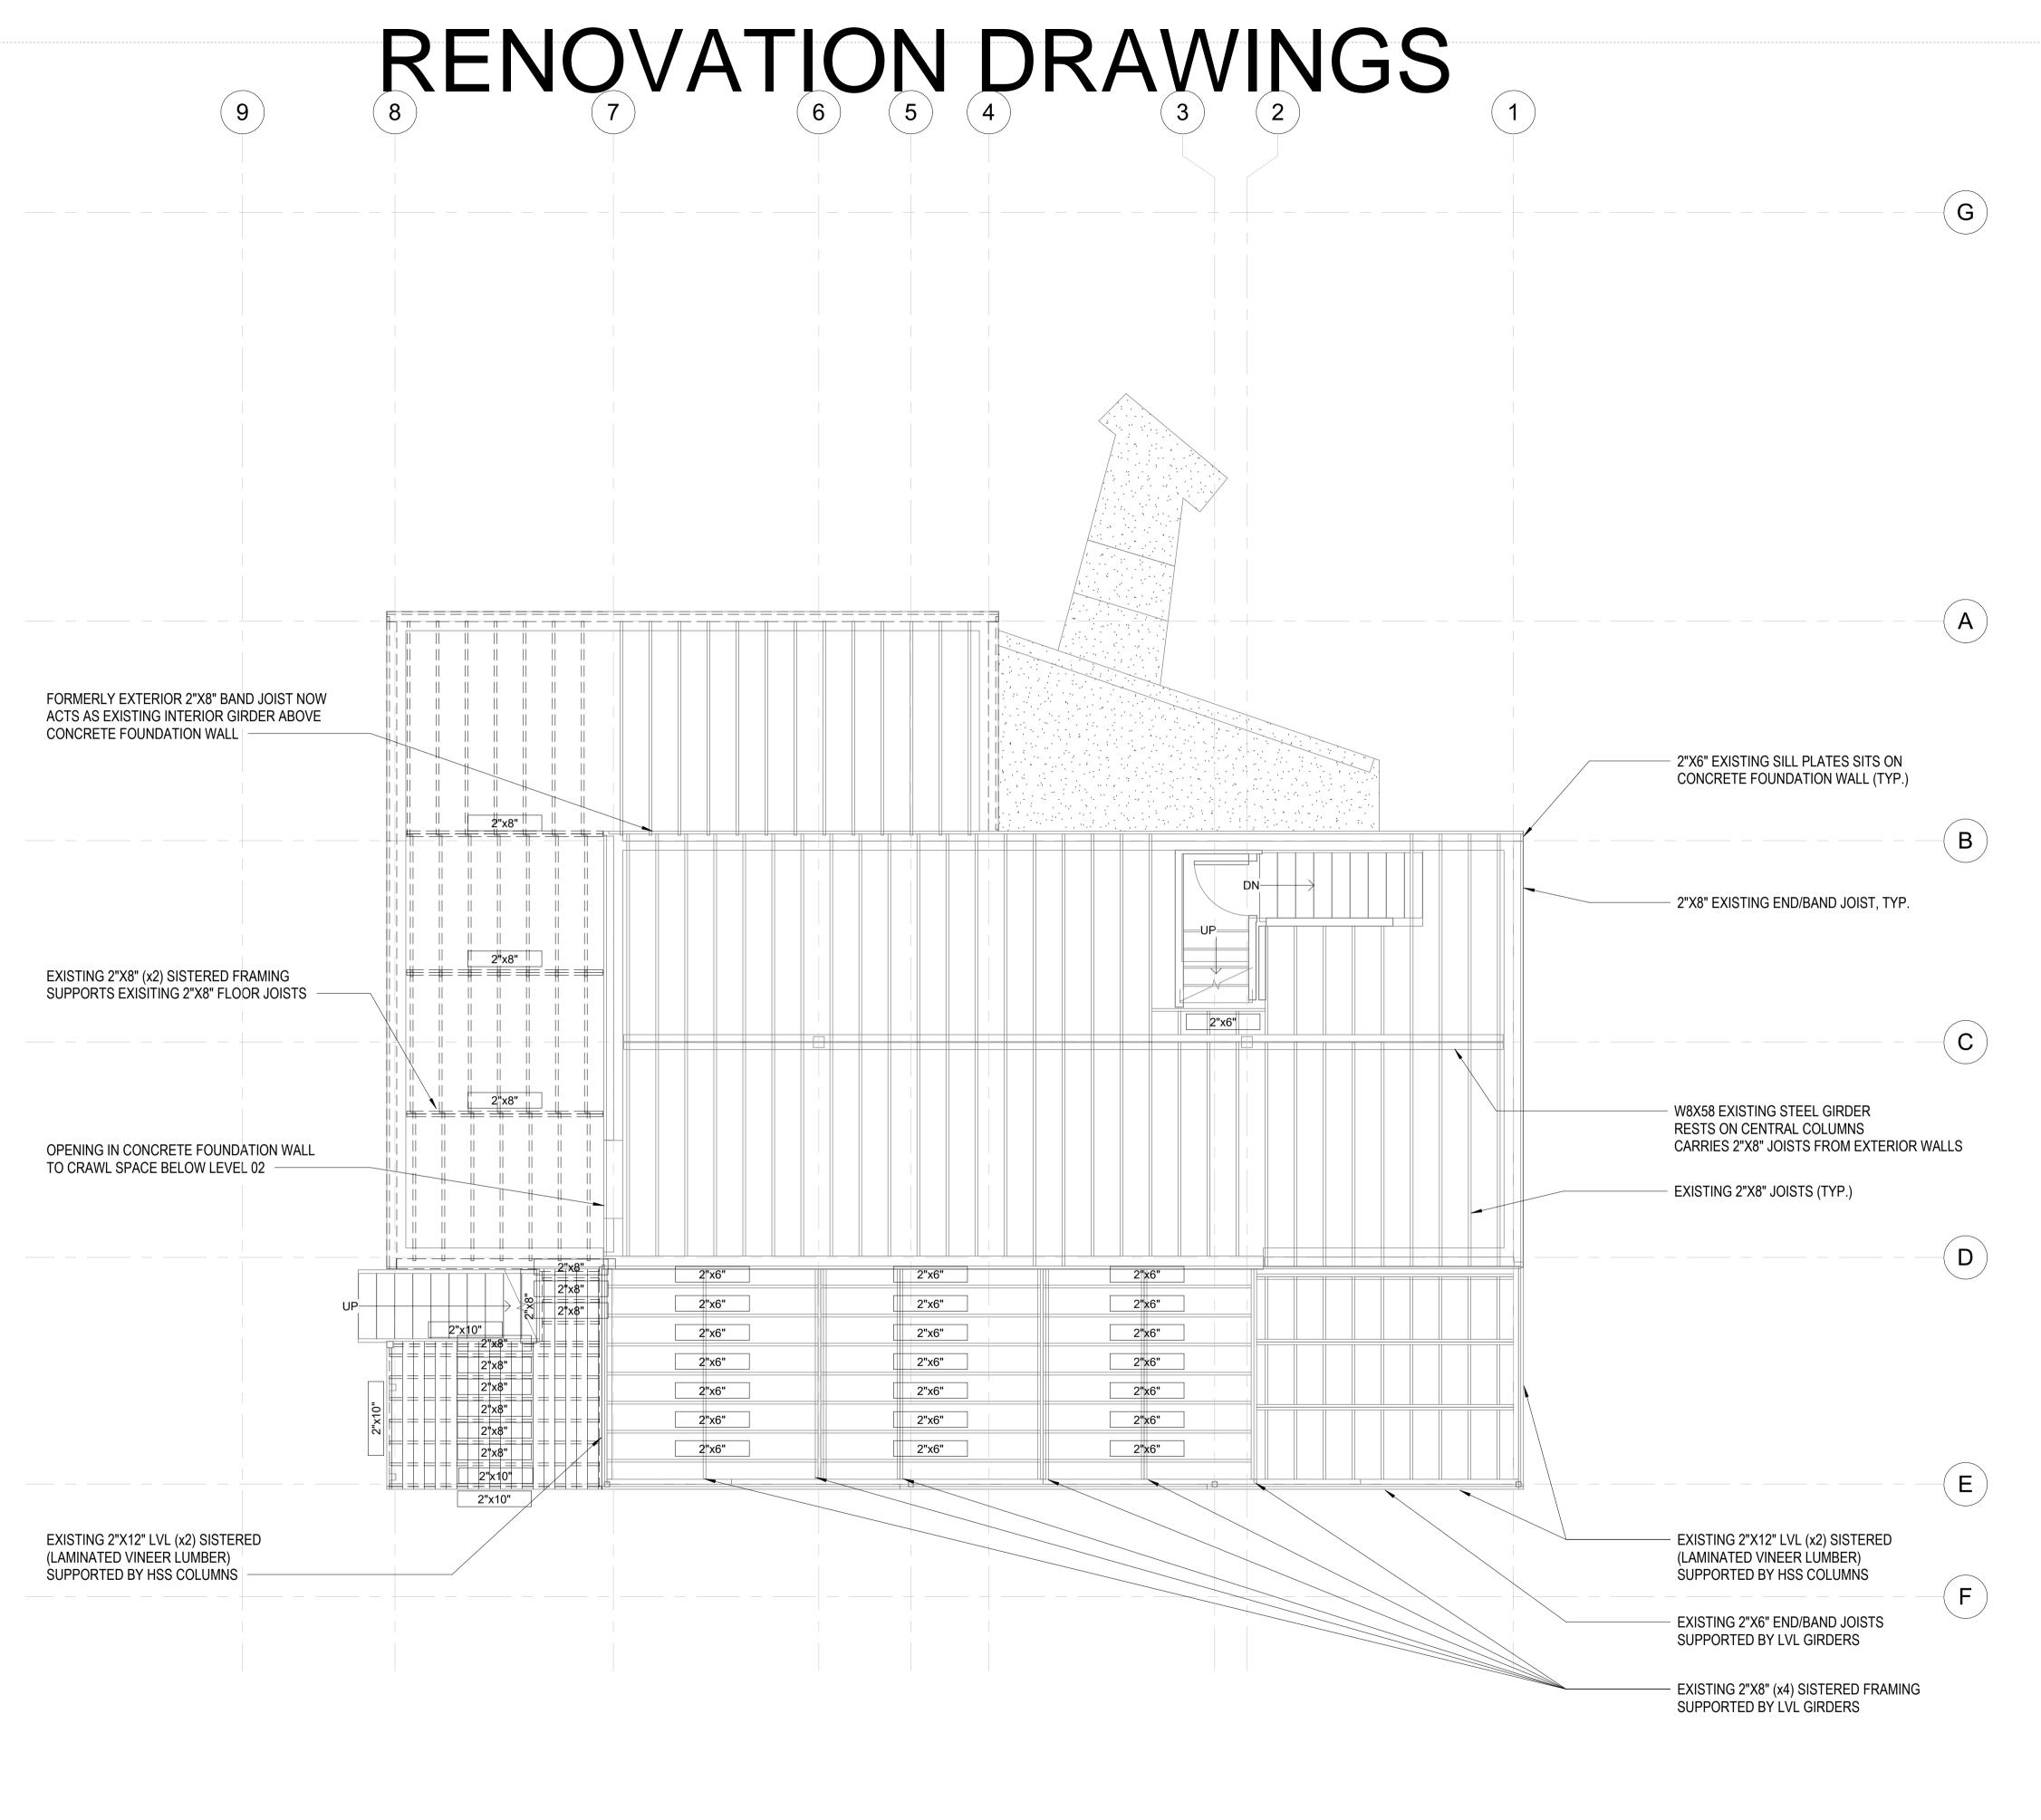

1 L02 - Framing 1/4" = 1'-0"

Robert & Sally Griffin 2712 N Magnolia Ave, Chicago, IL 60614

architectural designer: Patrick Griffin 2712 N Magnolia Ave, Chicago, IL 60614

structural engineer:

civil engineer:


consultant:

project name:

Griffin Residence 7655 Lilly Lake Rd. Burlington, WI 53105

project number: PG-2023-001

seal & signature:

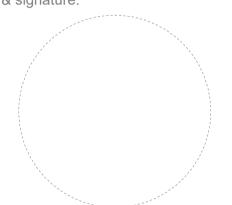

Not For Construction

Rennovation Drawings V5

sheet number:

34 of 35

sheet revisions:

No. Date Description


key plan:

Level 2 Framing Plan

Patrick G drawn by: 1/4" = 1'-0" 24 in × 36 in

12/19/2023 12:54:04 PM Do not scale. Check all dimensions on site.

S-102.00

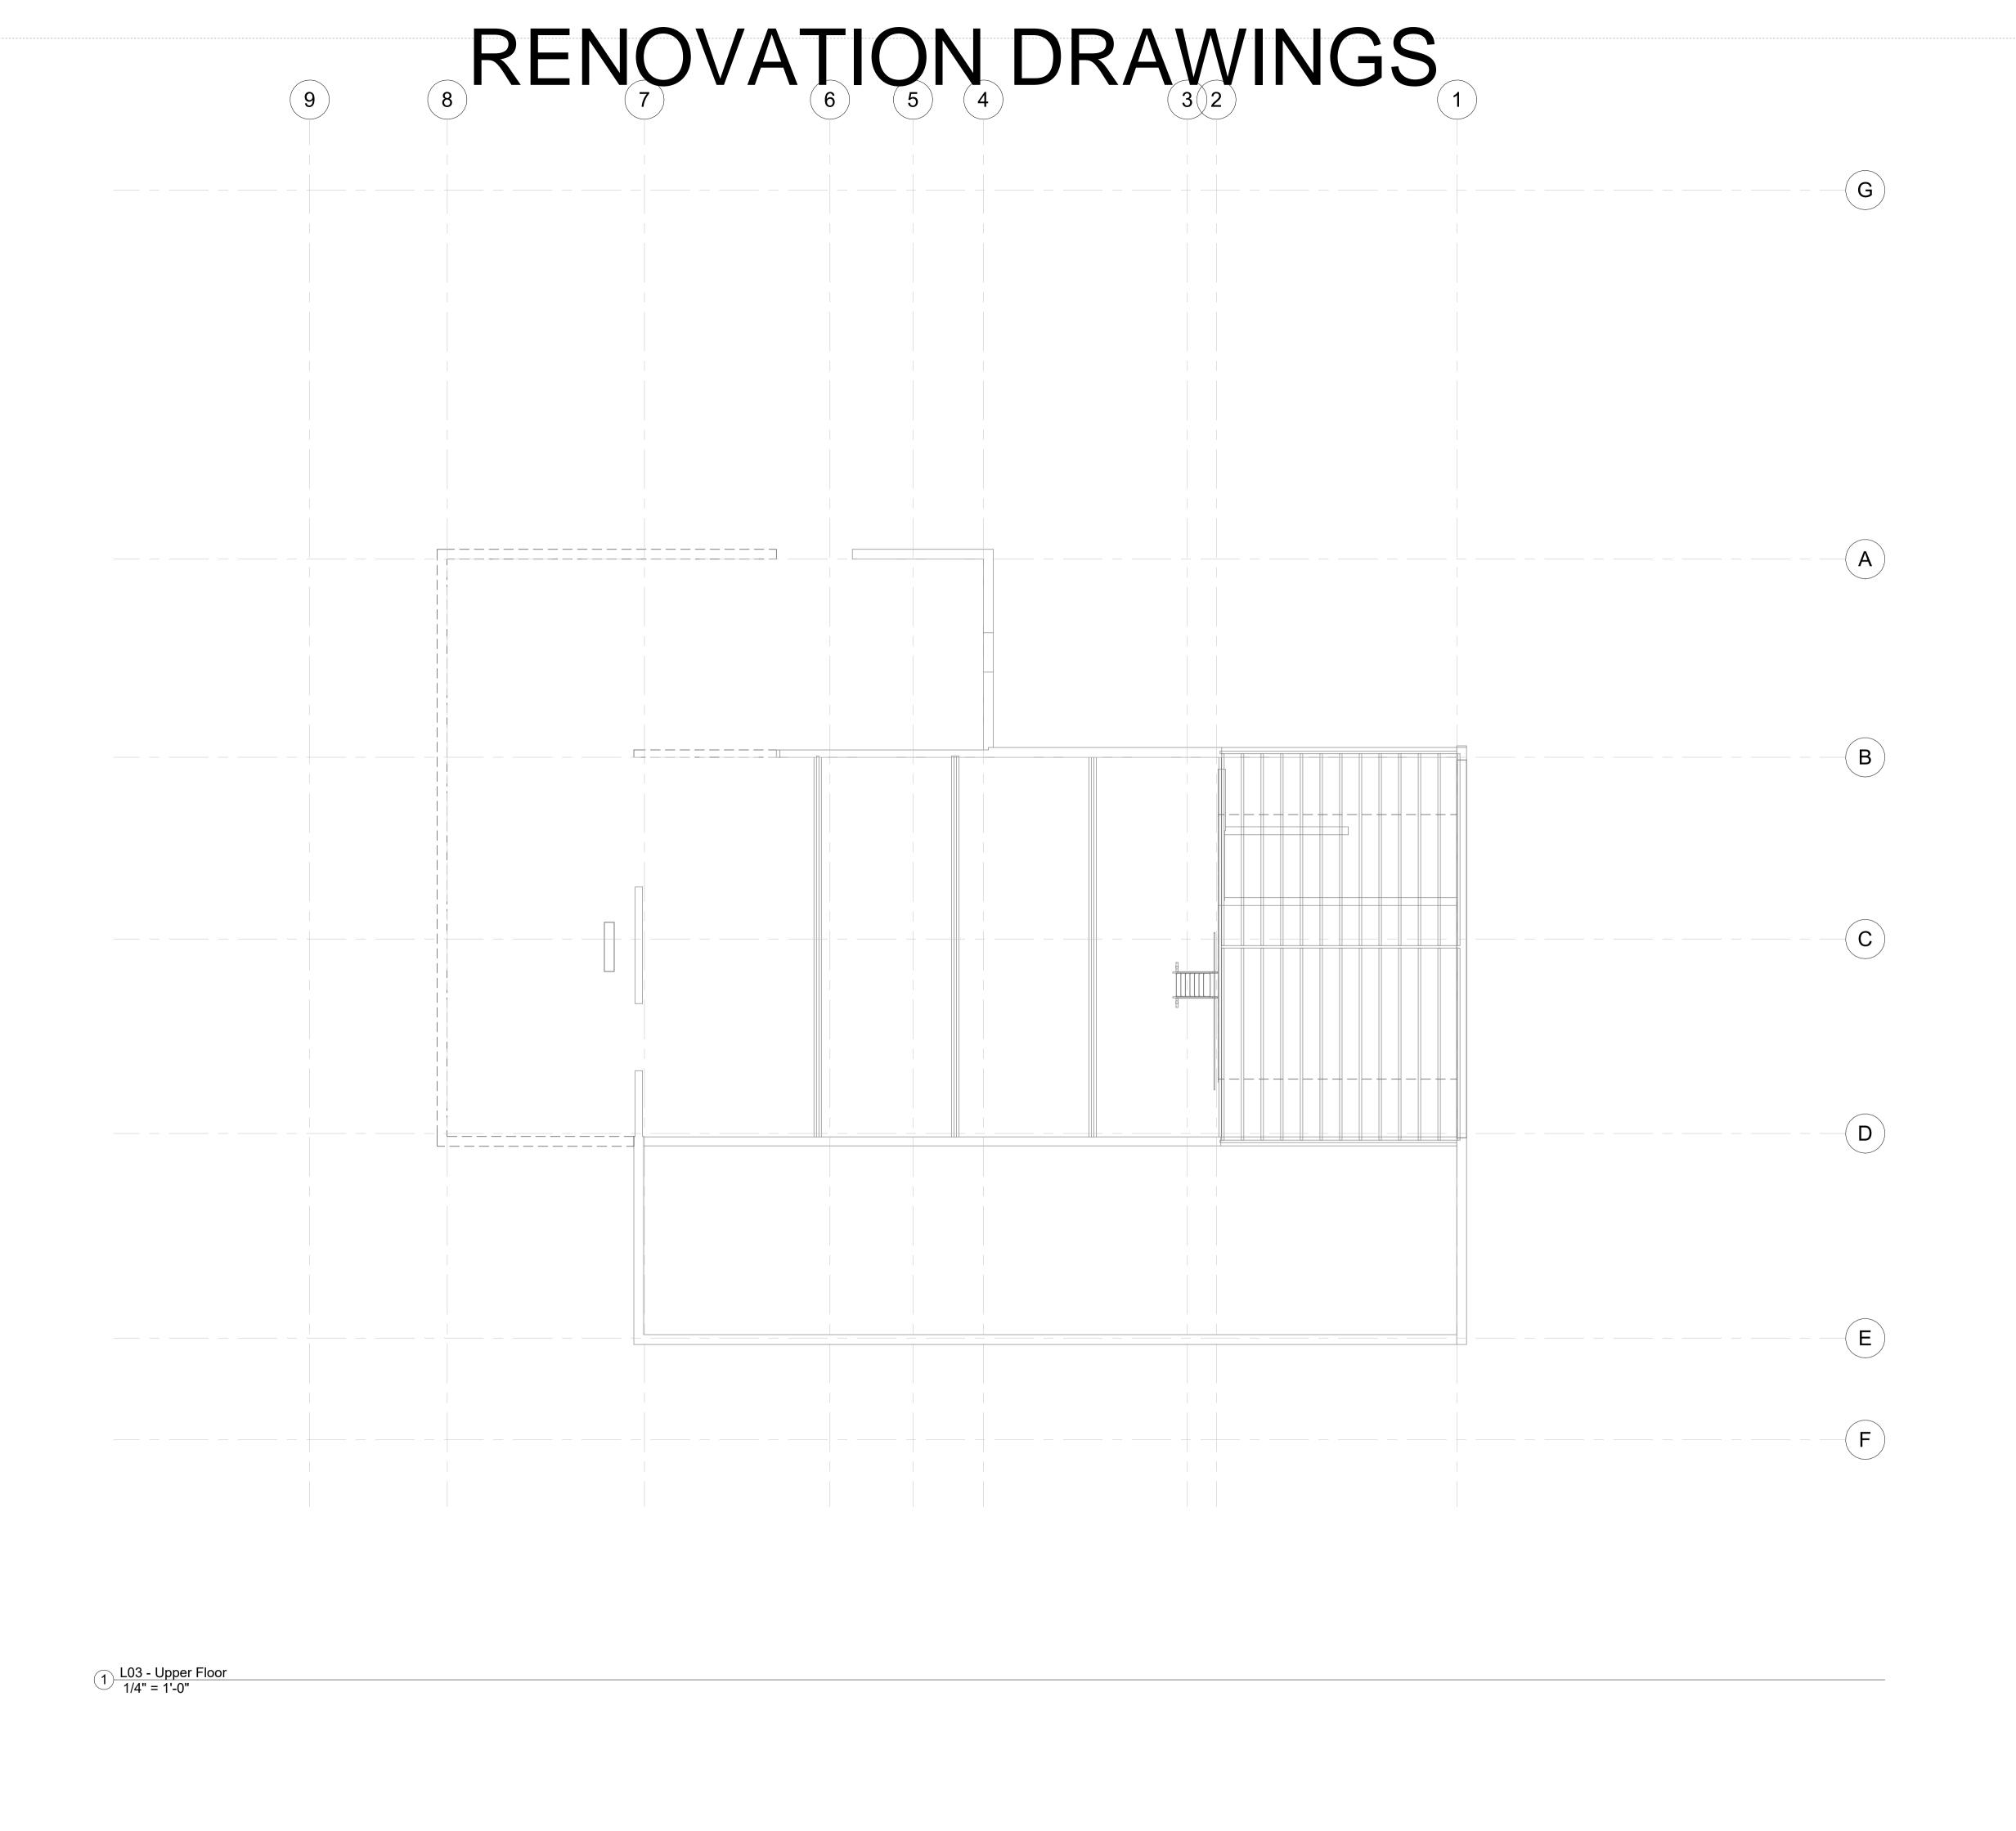

Robert & Sally Griffin 2712 N Magnolia Ave, Chicago, IL 60614

architectural designer:
Patrick Griffin 2712 N Magnolia Ave, Chicago, IL 60614


structural engineer:

civil engineer:

consultant:

project name: Griffin Residence 7655 Lilly Lake Rd. Burlington, WI 53105

project number: PG-2023-001

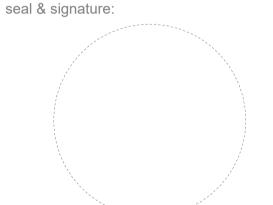

Not For Construction

Rennovation Drawings V5

sheet number: 35 of 35

sheet revisions:

No. Date Description

key plan:


Level 3 Framing Plan


Patrick G 1/4" = 1'-0" 24 in × 36 in

12/19/2023 12:54:05 PM Do not scale. Check all dimensions on site.

S-103.00

IMPERVIOUS SURFACE CALCULATIONS

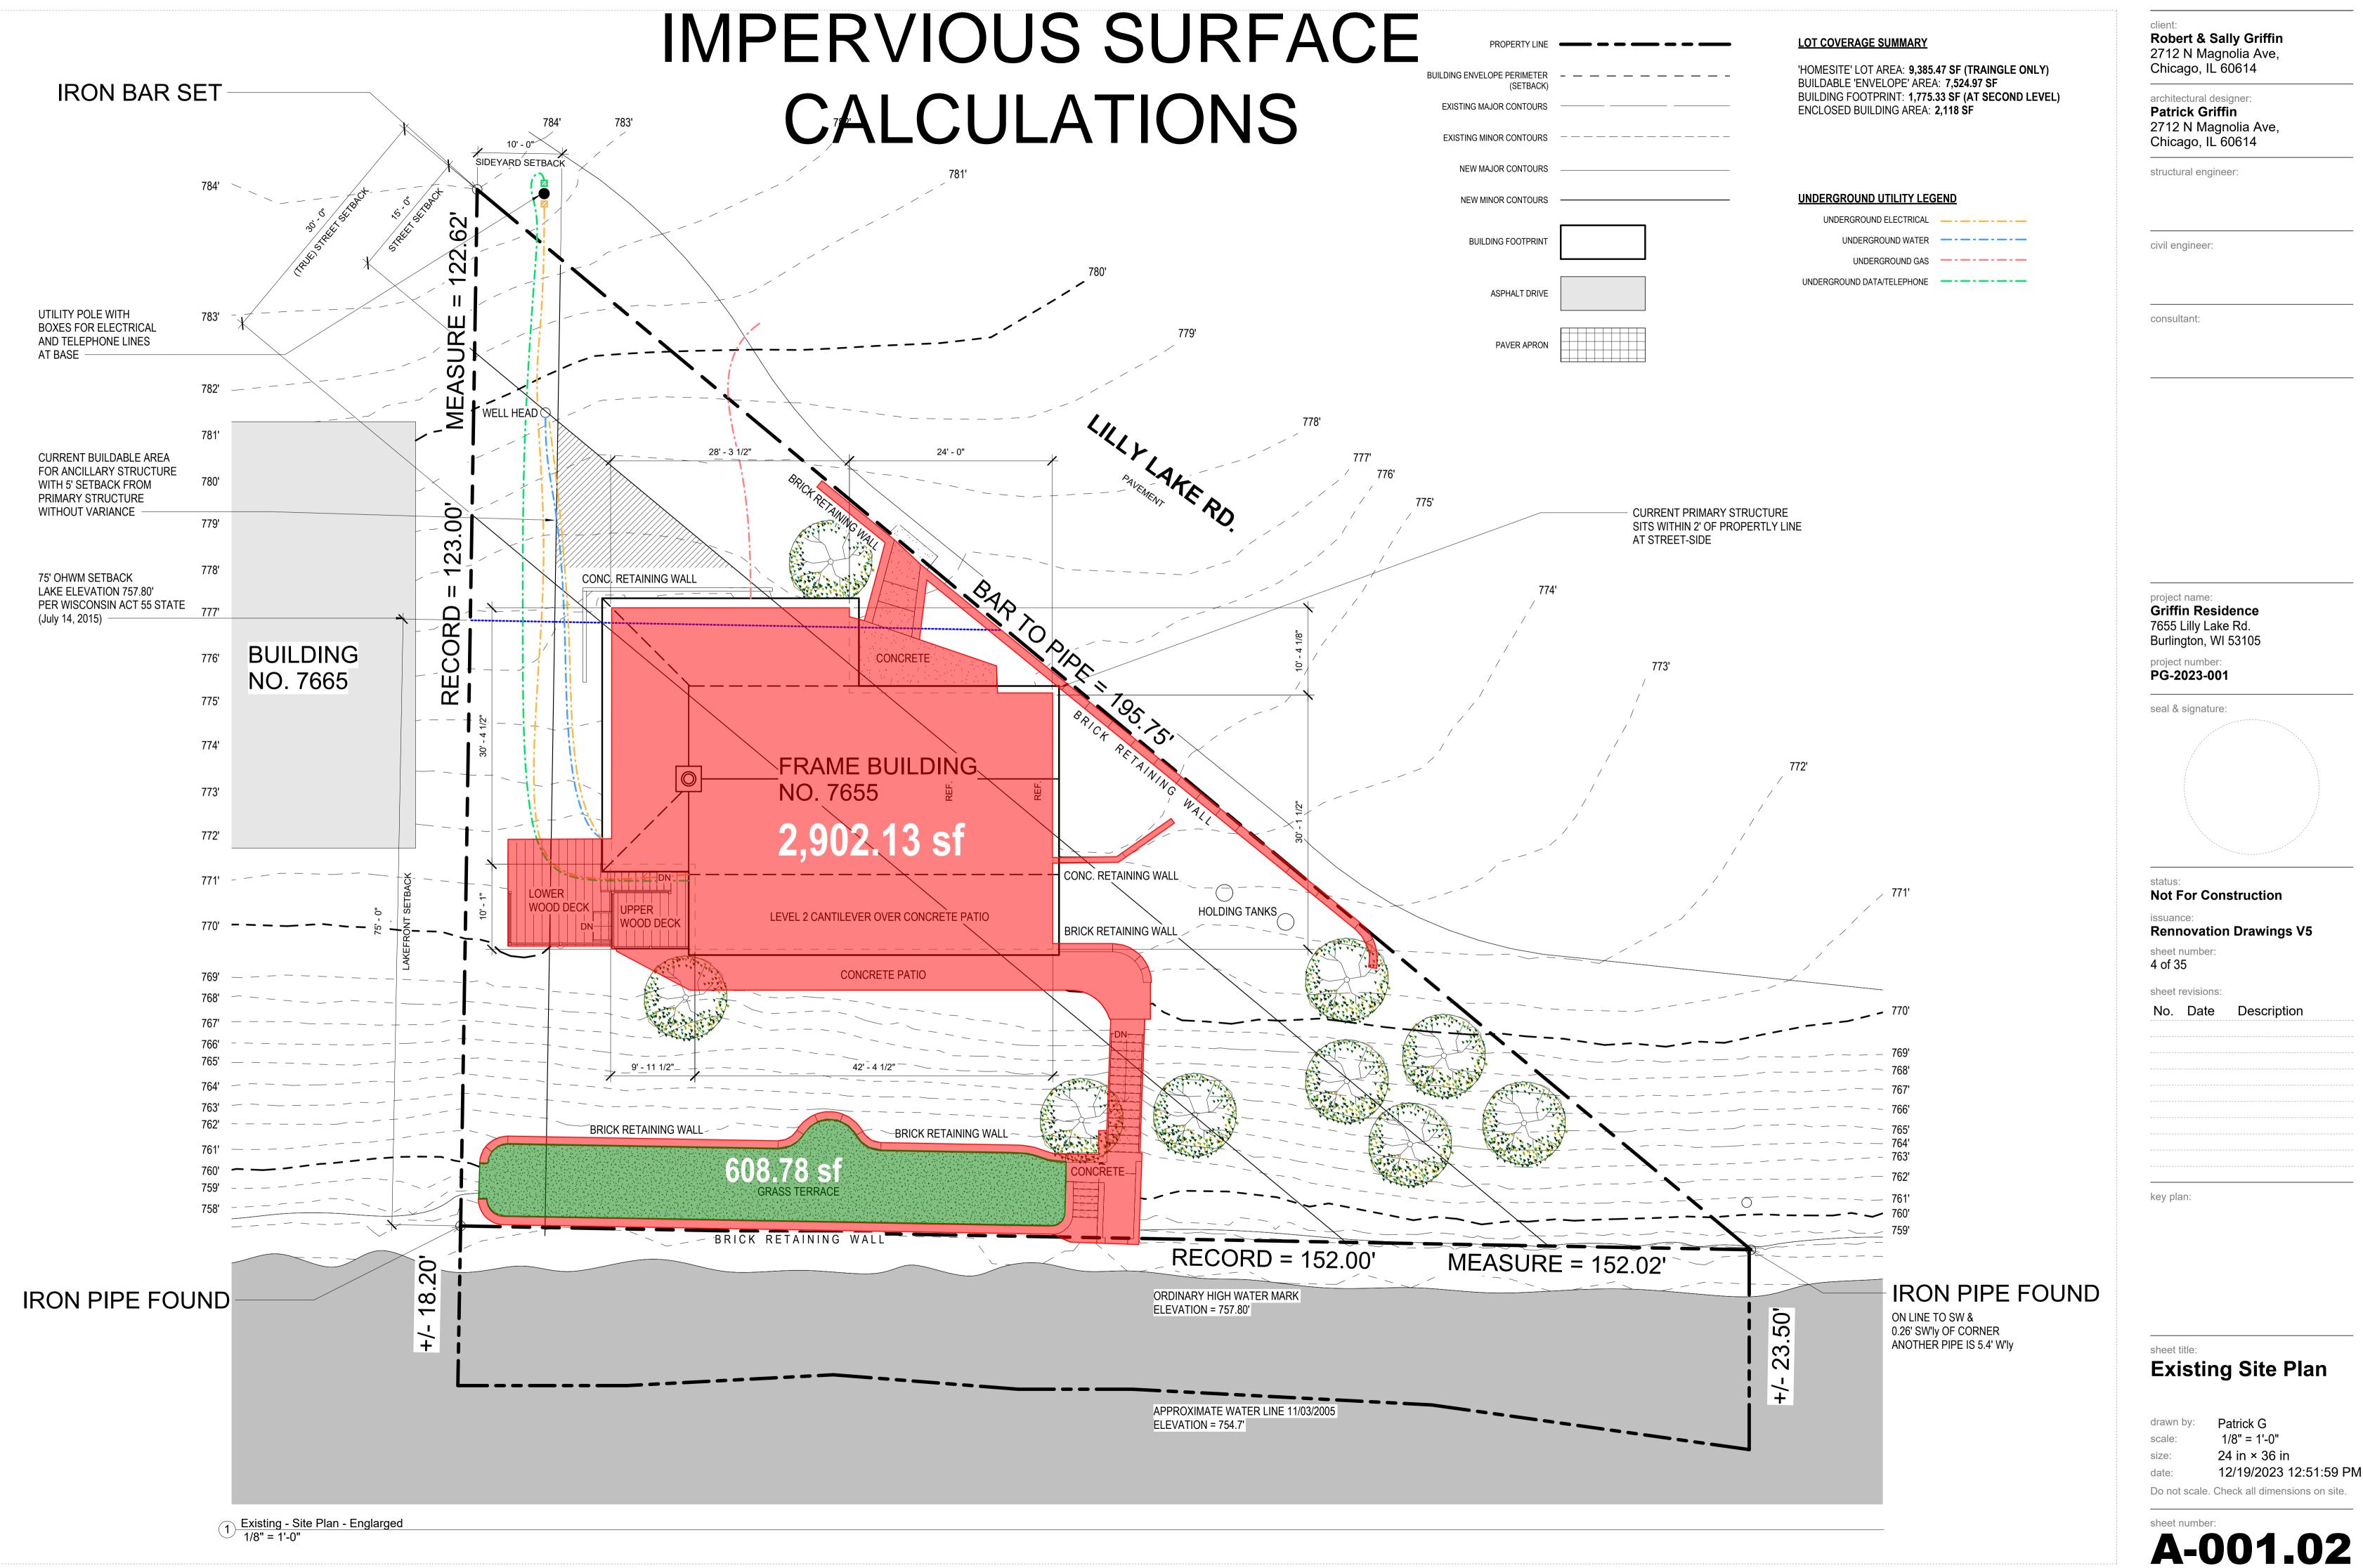

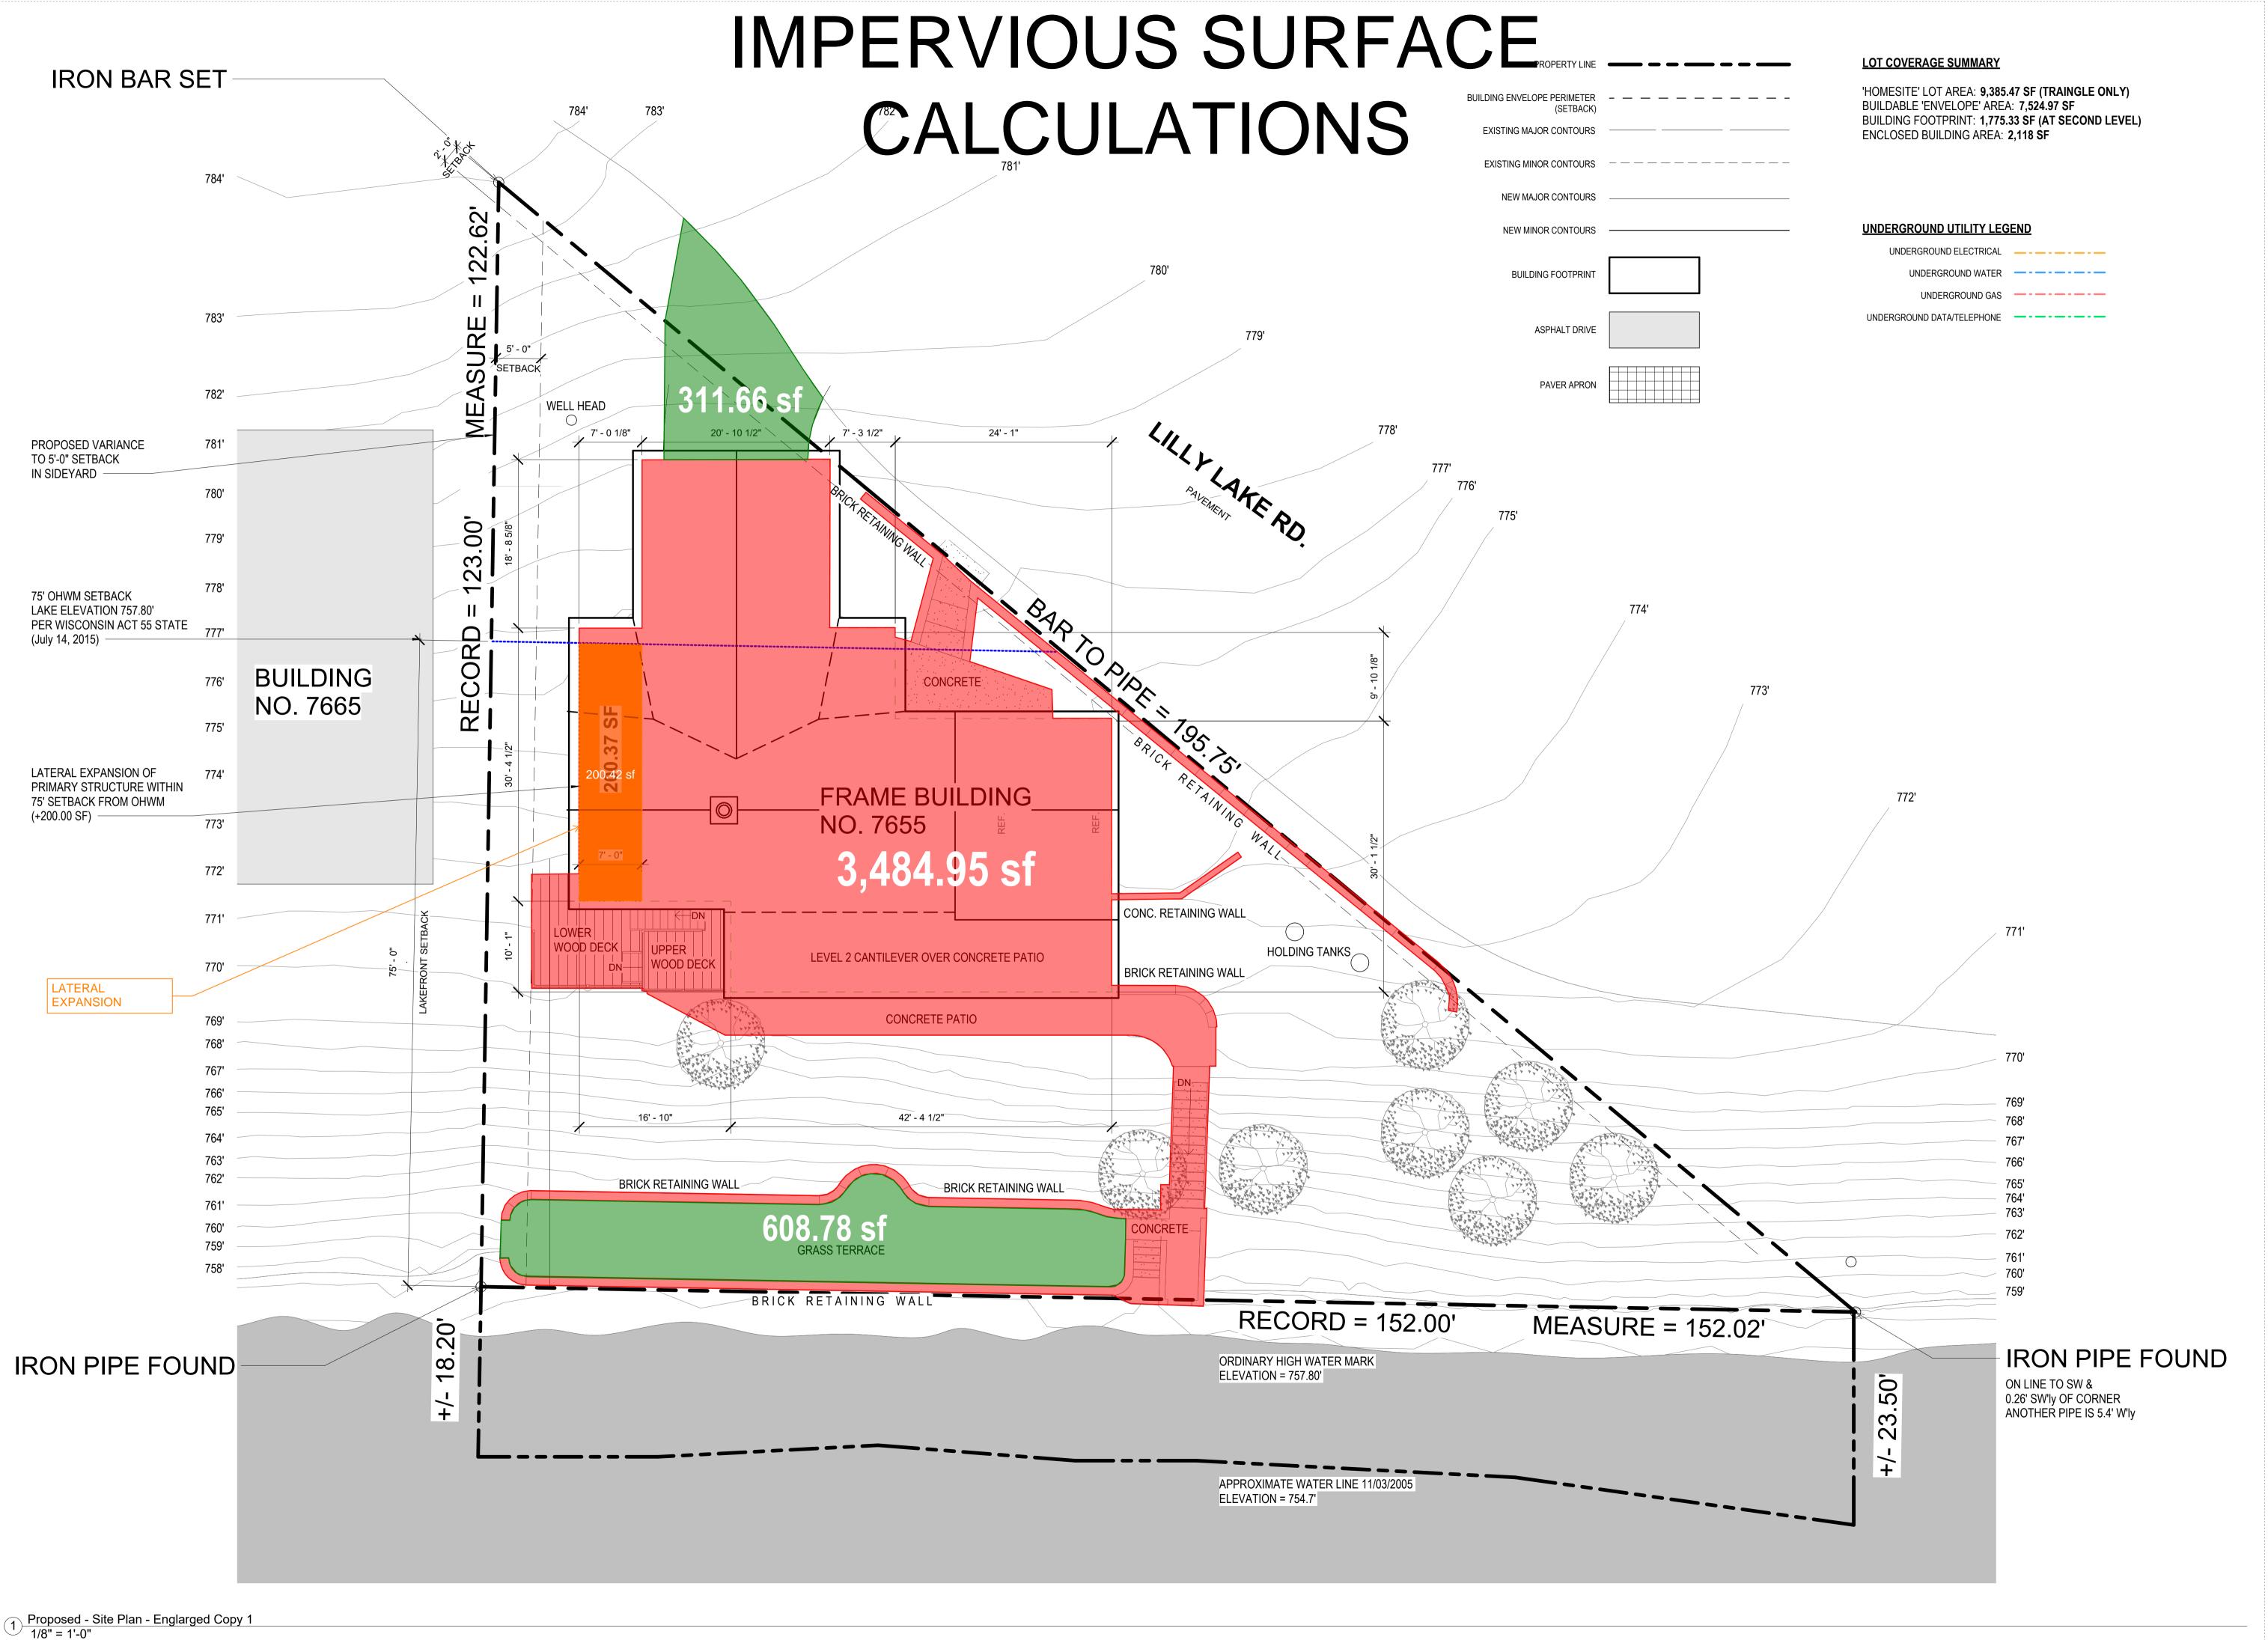

Robert & Sally Griffin 2712 N Magnolia Ave, Chicago, IL 60614 architectural designer: Patrick Griffin 2712 N Magnolia Ave, Chicago, IL 60614 structural engineer: civil engineer: consultant: project name: **Griffin Residence** 7655 Lilly Lake Rd. Burlington, WI 53105 project number: PG-2023-001 seal & signature: **Not For Construction** Rennovation Drawings V5 sheet number: 6 of 35 sheet revisions: No. Date Description

key plan:

sheet tit

Rennovated Site Plan

drawn by: Patrick G
scale: 1/8" = 1'-0"
size: 24 in × 36 in
date: 12/19/2023 12:52:03 PM

Do not scale. Check all dimensions on site.

et number:


CLOSET 105 CRAWLSPACE MECHANICAL CRAWLSPACE 103 **STORAGE BASEMENT** 101 102 CLOSET 106 **CRAWLSPACE BATHROOM COVERED PATIO** LOWER WOOD 104 108 110 **EXPOSED PATIO** CLOSET 109 **GRASS TERRACE** 112 STAIRS & CONCRETE

TERRACE


111

1 Existing - L01 - Basement Room Plan 1/8" = 1'-0"

MPERVIOUS SURFACE CALCULATIONS

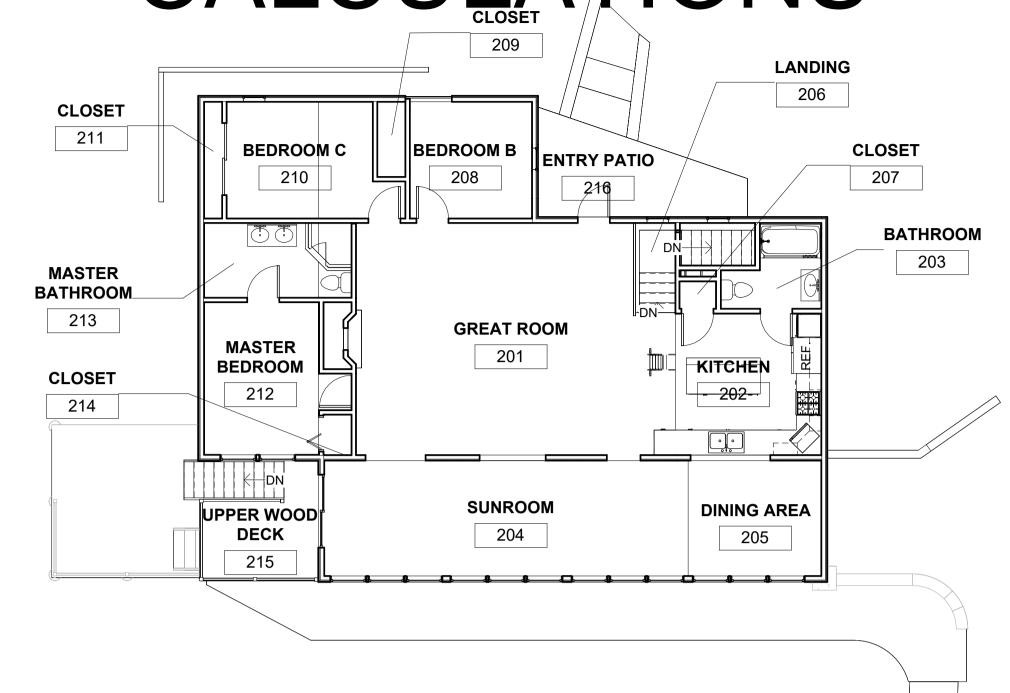

2 Existing - L02 - Main Floor Room Plan 1/8" = 1'-0"

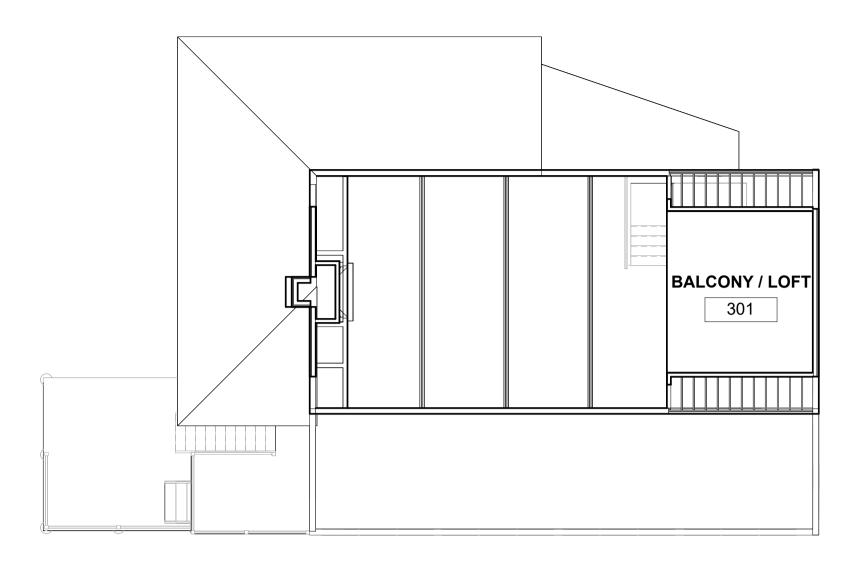

3 Existing - L03 - Balcony Room Plan 1/8" = 1'-0"

EXTERIOR AREA SCHEDULE

NAME	NUMBER	AREA	PERIMETER	NOTES
OUTDOOR CLOSET	107	19 SF	18' - 4"	(BELOW OR ABOVE OTHER)
COVERED PATIO	108	386 SF	105' - 6"	(BELOW OR ABOVE OTHER)
UPPER WOOD DECK	215	100 SF	42' - 0"	(BELOW OR ABOVE OTHER)
(BELOW OR ABOVE OTHER): 3		506 SF		
EXPOSED PATIO	109	393 SF	162' - 9"	IMPERVIOUS SURFACE
LOWER WOOD DECK	110	159 SF	50' - 3"	IMPERVIOUS SURFACE
STAIRS & CONCRETE TERRACE	111	157 SF	73' - 11"	IMPERVIOUS SURFACE
ENTRY PATIO	216	148 SF	66' - 5"	IMPERVIOUS SURFACE
IMPERVIOUS SURFACE: 4		857 SF		
GRASS TERRACE	112	747 SF	158' - 0"	PURVEOUS SURFACE
PURVEOUS SURFACE: 1		747 SF		'
GRAND TOTAL: 8		2109 SF		

LOT SURFACE COVERAGE

'HOMESITE' LOT AREA: 9,385.47 SF (TRAINGLE ONLY) BUILDABLE 'ENVELOPE' AREA: 7,524.97 SF

MAX. UMITIGATED IMPERVIOUS SURFACE AREA: (9,385.47x0.30) = 2,815.5 SF MAX. MITIGATED IMPERVIOUS SURFACE AREA: (9,384.47x0.40) = 3754.1 SF

EXISTING BUILDING FOOTPRINT: 1,775.33 SF (AT SECOND LEVEL) EXISTING IMPERVIOUS SURFACE AREA: 857 SF (OUTSIDE OF BUILDING FOOTPRINT) EXISTING RETAINING WALL SURFACE AREA: 270 SF

GRAND TOTAL IMPERVIOUS SURFACES: 2901 SF

ROOM SCHEDULE

NAME	NUMBER	AREA	PERIMETER	NOTES
BASEMENT	101	393 SF	125' - 10"	
STORAGE	102	160 SF	54' - 1"	
MECHANICAL	103	43 SF	29' - 10"	
BATHROOM	104	62 SF	39' - 9"	
CLOSET	105	14 SF	18' - 3"	
CLOSET	106	4 SF	8' - 7"	
L01 - Basement: 6		677 SF		
GREAT ROOM	201	485 SF	94' - 7"	
KITCHEN	202	147 SF	51' - 4"	
BATHROOM	203	47 SF	31' - 0"	
SUNROOM	204	291 SF	79' - 9"	
DINING AREA	205	106 SF	41' - 5"	
LANDING	206	26 SF	21' - 11"	
CLOSET	207	7 SF	10' - 8"	
BEDROOM B	208	Not Enclosed	Not Enclosed	
CLOSET	209	15 SF	17' - 2"	
BEDROOM C	210	126 SF	49' - 2"	
CLOSET	211	15 SF	22' - 5"	
MASTER BEDROOM	212	130 SF	49' - 11"	
MASTER BATHROOM	213	76 SF	37' - 0"	
CLOSET	214	8 SF	11' - 5"	
L02 - Main Floor: 14		1478 SF		
BALCONY / LOFT	301	163 SF	51' - 2"	
L03 - Upper Floor: 1	'	163 SF	'	
GRAND TOTAL: 21		2319 SF		

Robert & Sally Griffin 2712 N Magnolia Ave, Chicago, IL 60614 architectural designer: Patrick Griffin 2712 N Magnolia Ave,


Chicago, IL 60614

structural engineer: civil engineer:

consultant:

project name: **Griffin Residence** 7655 Lilly Lake Rd. Burlington, WI 53105

project number: PG-2023-001

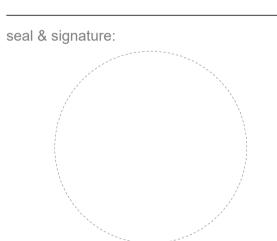

Not For Construction

Rennovation Drawings V5 sheet number:

7 of 35

sheet revisions: No. Date

Description

sheet title:


key plan:

Existing Area Calculations

drawn by: Patrick G 1/8" = 1'-0" 24 in × 36 in 12/19/2023 12:52:07 PM


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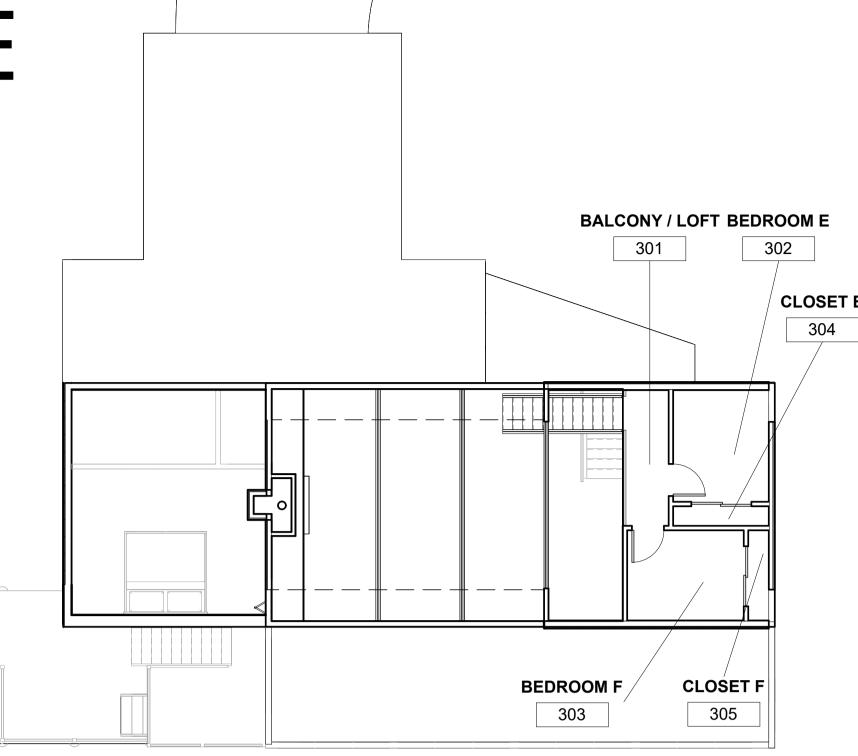


1 Proposed - L01 - Basement Room Plan 1/8" = 1'-0"

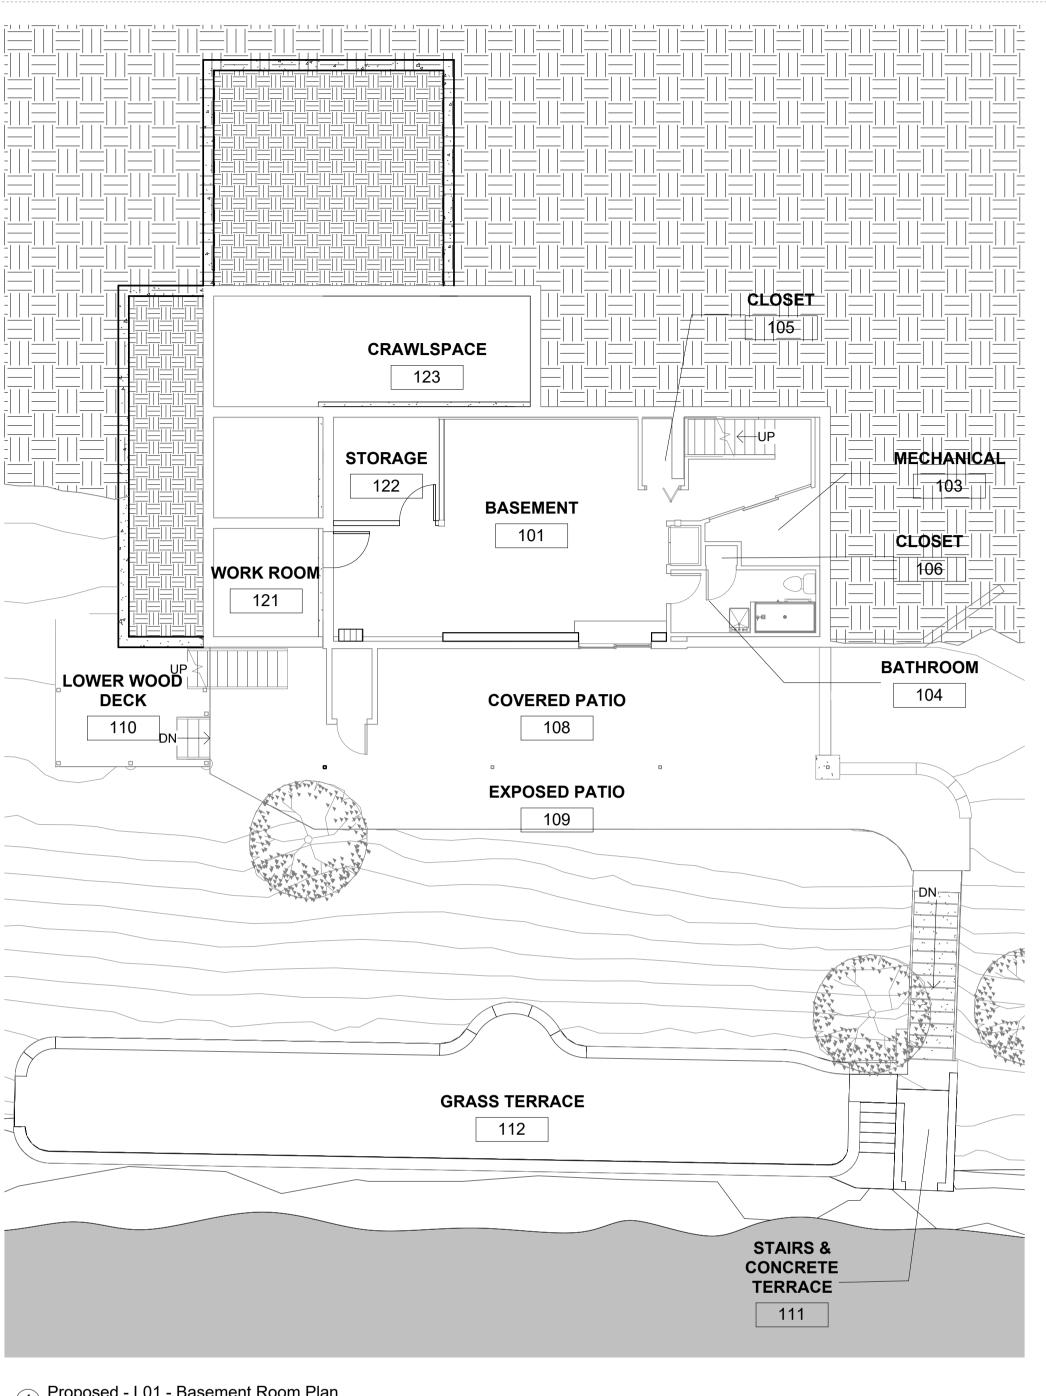IMPERIOUS SURFACE CARAGE OULATIONS 2 ANGE OULATIONS



Proposed - L02 - Main Floor Room Plan 1/8" = 1'-0"

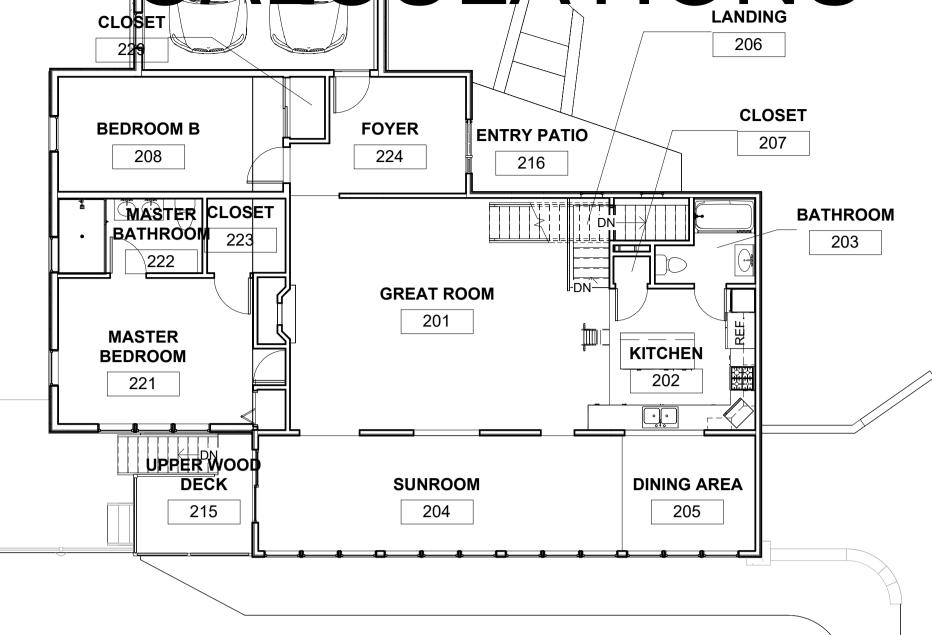

Proposed - L03 - Balcony Room Plan
1/8" = 1'-0"

EXTERIOR AREA SCHEDULE (RENOVATED)

		'	\	
NAME	NUMBER	AREA	PERIMETER	NOTES
COVERED PATIO	108	386 SF	105' - 6"	(BELOW OR ABOVE OTHER)
UPPER WOOD DECK	215	74 SF	39' - 8"	(BELOW OR ABOVE OTHER)
(BELOW OR ABOVE OTHER): 2		459 SF		
EXPOSED PATIO	109	393 SF	162' - 9"	IMPERVIOUS SURFACE
LOWER WOOD DECK	110	124 SF	45' - 0"	IMPERVIOUS SURFACE
STAIRS & CONCRETE TERRACE	111	157 SF	73' - 11"	IMPERVIOUS SURFACE
ENTRY PATIO	216	148 SF	66' - 5"	IMPERVIOUS SURFACE
IMPERVIOUS SURFACE: 4		822 SF		
GRASS TERRACE	112	747 SF	158' - 0"	PURVEOUS SURFACE
DRIVEWAY	230	314 SF	70' - 8"	PURVEOUS SURFACE
PURVEOUS SURFACE: 2		1061 SF		
GRAND TOTAL: 8		2343 SF		

LOT SURFACE COVERAGE

'HOMESITE' LOT AREA: 9,385.47 SF (TRAINGLE ONLY) BUILDABLE 'ENVELOPE' AREA: 7,524.97 SF

MAX. UMITIGATED IMPERVIOUS SURFACE AREA: (9,385.47x0.30) = 2,815.5 SF MAX. MITIGATED IMPERVIOUS SURFACE AREA: (9,384.47x0.40) = 3754.1 SF

RENOVATED BUILDING FOOTPRINT: 2371.25 SF (AT SECOND LEVEL) RENOVATED IMPERVIOUS SURFACE AREA: 849 SF (OUTSIDE OF BUILDING FOOTPRINT) EXISTING RETAINING WALL SURFACE AREA: 270 SF

GRAND TOTAL IMPERVIOUS SURFACES: 3485 SF

WATER MITIGATION REQUIREMENT: 670

ROOM SCHEDULE (RENOVATED)

IAWIAIT	HOMBEK	ANLA	L CIVIIAIC I CIV	NOTES
BASEMENT	101	476 SF	144' - 9"	
MECHANICAL	103	43 SF	29' - 10"	
BATHROOM	104	62 SF	39' - 9"	
CLOSET	105	14 SF	18' - 3"	
CLOSET	106	4 SF	8' - 7"	
WORK ROOM	121	83 SF	36' - 10"	NEW
STORAGE	122	76 SF	34' - 10"	NEW
L01 - Basement: 7		759 SF		
GREAT ROOM	201	486 SF	95' - 0"	
KITCHEN	202	147 SF	51' - 4"	
BATHROOM	203	47 SF	31' - 0"	
SUNROOM	204	291 SF	79' - 9"	
DINING AREA	205	106 SF	41' - 5"	
LANDING	206	26 SF	21' - 11"	
CLOSET	207	7 SF	10' - 8"	
BEDROOM B	208	179 SF	56' - 7"	
UPPER WOOD DECK	215	74 SF	39' - 8"	(BELOW OR ABOVE OTHER)
MASTER BEDROOM	221	205 SF	63' - 2"	NEW
MASTER BATHROOM	222	74 SF	36' - 5"	NEW
CLOSET	223	40 SF	25' - 5"	RENOVATION
FOYER	224	125 SF	49' - 1"	RENOVATION
ATTACHED GARAGE	228	352 SF	75' - 1"	NEW
CLOSET	229	15 SF	16' - 2"	NEW
L02 - Main Floor: 15		2174 SF		
BALCONY / LOFT	301	43 SF	30' - 3"	
BEDROOM E	302	74 SF	34' - 6"	NEW
BEDROOM F	303	73 SF	34' - 5"	NEW
CLOSET E	304	13 SF	19' - 2"	NEW
CLOSET F	305	13 SF	18' - 5"	NEW
L03 - Upper Floor: 5	1	216 SF		
GRAND TOTAL: 27		3149 SF		


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Not For Construction

Rennovation Drawings V5

sheet number: 8 of 35

NOTES

sheet revisions:

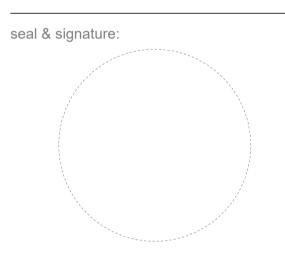Description No. Date

key plan:

Rennovated Area **Calculations**

drawn by: Patrick G 1/8" = 1'-0" 24 in × 36 in 12/19/2023 12:52:09 PM

Do not scale. Check all dimensions on site.

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ATTACH TO-SCALE SET OF CONSTRUCTION DRAWINGS

BOARD OF ADJUSTMENTS SCHEDULE FOR 2023 PUBLIC HEARINGS

Third Thursday of each month at 6:00 p.m.
Kenosha County Center, 19600 75th Street, Bristol, Wisconsin
Conference Room A (unless published otherwise)

This schedule includes all areas under general zoning regulations in the following townships: BRIGHTON, PARIS, RANDALL, SOMERS, WHEATLAND

HEARING DATES

JANUARY 19	Filing Date: Published:	December 19 Jan. 4 & Jan. 11	JULY 20	Filing Date: Published:	June 20 July 5 & July 12
FEBRUARY 16	Filing Date: Published	January 16 Feb. 1 & Feb. 8	AUGUST 17	Filing Date: Published:	July 17 Aug. 2 & Aug. 9
MARCH 16	Filing Date: Published:	February 16 March 1 & March 8	SEPTEMBER 21	Filing Date: Published:	August 21 Sept. 6 & Sept. 13
APRIL 20	Filing Date: Published:	March 20 April 5 & April 12	OCTOBER 19	Filing Date: Published:	September 19 Oct. 4 & Oct. 11
MAY 18	Filing Date: Published:	April 18 May 3 & May 10	NOVEMBER 16	Filing Date: Published:	October 16 Nov. 1 & Nov. 8
JUNE 15	Filing Date: Published:	May 15 May 31 & June 7	DECEMBER 21	Filing Date: Published:	November 21 Dec. 6 & Dec. 13

CHAPTER 12, KENOSHA COUNTY GENERAL ZONING AND SHORELAND/FLOODPLAIN ZONING ORDINANCE STATES:

12.06-4 LEGAL NOTICE REQUIREMENTS AND TIME LIMITS: Any petition or other matter requiring the publication of a legal notice must be submitted at least one month prior to the requested hearing date as scheduled by the Planning, Development & Extension Education Committee or Board of Adjustments. For purposes on this section, "one month prior to the requested hearing date" shall be defined to mean not later than 4:30 p.m. on the same calendar date of the month preceding the scheduled hearing, or the last day county offices are open prior to the aforementioned deadline. For purposes of the Open Meetings Law, the Planning and Development Administrator shall be delegated the responsibility of informing the county clerk of both scheduled open and closed meetings so that proper notices may be given.

VARIANCE PROCEDURES BEFORE THE BOARD OF ADJUSTMENTS

□ 1.	Contact the Department of Planning & Development and schedule a pre-application meeting. Bring the following for your pre-application meeting:
	☐ Completed variance application.
	☐ If you are in the process of purchasing the property and have yet to close, you need to provide a signed letter of agent status signed by the current property owner authorizing you to apply for the variance on their behalf.
	☐ A to-scale survey of the property with the following information provided.
	Size and location of all existing structures on the property and their distances from property lines (any street yard setback should be taken from the edge of the road right of way), environmental features such as an ordinary high water mark (lake or stream) or wetland, and any onsite septic tank and associated septic field (if applicable).
	Location and dimensions of the proposed structure(s) and their resulting setback distances from property lines (any street yard setback should be taken from the edge of the road right of way), environmental features such as an ordinary high water mark (lake or stream) or wetland, and any onsite septic tank and associated septic field (if applicable).
	☐ Construction plans
	☐ A filing fee of \$550 (non-refundable) is required at the time of application submittal time to cover the costs agenda preparation, public hearing notification, site visits, etc
□ 4.	Submit the above information by the filing deadline (see Board of Adjustment Schedule handout) with the Department of Planning and Development. Once Planning & Development staff have confirmed the application is substantially completed, Planning & Development will provide you with a date-stamped copy of your variance application.
□ 5.	Submit a copy of your date-stamped variance application to your local Township for placement on the agenda of the Town Planning Commission and/or the Town Board.
□ 6.	Your first meeting will be with the Town Planning Commission, except for the Town of Wheatland. The Town of Somers has a Board of Appeals.

NOTE: You must attend, or the Commission/Board will not be able to act on your request.

7. Your second meeting will be with the Town Board.

NOTE: You must attend, or the Board will not be able to act on your request.

■ 8. Your third meeting will be with the County Board of Adjustments.

NOTE: You must attend, or the Board of Adjustments will not be able to act on your request. At this meeting you will be asked to brief the Board on your request for a variance and state your reasons for hardship (see Public Hearing Variance Standards handout).

9. If the Board of Adjustments grants your variance request you may obtain your zoning permit from the Office of Planning and Development. The permit will be issued if all requirements from this office have been addressed, including sanitation and if you are the current owner of the property.

Expiration: Variances granted by the Board that require issuance of a zoning permit shall expire within one year of approval unless the zoning permit is issued. Zoning permits issued in accordance with Board of Adjustments approval are valid for 18 months and may not be renewed without Board of Adjustment approval. Variances are approved for specific sizes and dimensions. No additions shall be approved which affect the area for which the variance was granted unless approved by the Board of Adjustments.

No zoning permits issued for work approved by a variance shall be renewed unless "substantial construction" – the value of such work that has commenced equivalent to 25% of the projected cost of the project as noted on the application for the zoning permit, has commenced.

Appeals: Any person or persons jointly or severally, aggrieved by any decision of the Board of Adjustment, or any taxpayer, or any officer, department, board or bureau of the municipality, may present to a court of record a petition, duly verified, setting forth that such decision is illegal, in whole or in part, specifying the ground of illegality. Such petition shall be presented to the court within thirty days after the filing of the decision in the office of the Board.

Any work the property owner commences with the window for appeal is at their own risk.

□ 10. If the Board of Adjustments denies your variance you have thirty (30) days to file an appeal with circuit court if you so choose.

VARIANCE PROCEDURES & PUBLIC HEARING VARIANCE STANDARDS

IMPORTANT TELEPHONE NUMBERS

Kenosha County Center
Department of Planning & Development
19600 - 75th Street, Post Office Box 520
Bristol, Wisconsin 53104-0520

Briston, Wilderick Co. 20	
Division of County Development (including Sanitation & Land Conservation)	857-1895
Facsimile #	857-1920
Public Works Division of Highways	857-1870
Administration Building	
Division of Land Information	653-2622
Brighton, Town of	878-2218
Paris, Town of	859-3006
Randall, Town of	877-2165
Somers Town of	
Wheatland, Town of	537-4340
Wisconsin Department of Natural Resources - Sturtevant Office	
Wisconsin Department of Transportation - Waukesha Office	548-8722

PUBLIC HEARING VARIANCE STANDARDS

YOUR PUBLIC HEARING WILL BE BASED ON THE FOLLOWING STANDARDS FROM
THE KENOSHA COUNTY GENERAL ZONING AND SHORELAND/FLOODPLAIN
ZONING ORDINANCE.

CHAPTER 12.36-1 INTENT

It is the intent of this section of the Ordinance to recognize that under certain conditions and circumstances, it may be necessary to obtain a variance from the terms of this Ordinance so long as said variance will not be contrary to the public interest, and where, owing to special conditions, a literal enforcement of the provisions of the Ordinance will result in unnecessary hardship or practical difficulties and where the granting of such variance will uphold the spirit of this Ordinance and contribute to the justice of the particular case in question. Any variance granted under the terms of this ordinance shall, however, relate only to area requirements and not to use. Furthermore, it is the intent of this section to establish a Board of Adjustments for the purpose of reviewing applications for variances as well as reviewing orders and decisions made by the Office of Planning and Development.

CHAPTER 12.36-13 STANDARDS AND GUIDELINES

- In determining whether a variance is to be granted, the following standards and guidelines must be met in view of the evidence presented and in making its decision, these standards and guidelines shall be addressed by the board of adjustment:
 - 1. The existence of special conditions or exceptional circumstances on the land in question.
 - 2. The experiencing of unnecessary hardships or practical difficulties on the land in question either presently or in the future.
 - 3. That these hardships or difficulties are the result of the aforementioned special conditions existing on the land and are not self-inflicted.
 - 4. That the existence of these special conditions will restrict the use of the land if the Ordinance is applied literally so as to render the land useless.
 - 5. That the limitation on the use of the land does not apply generally to other properties in the district.
 - 6. That limiting the use of the property does not afford compensating gains to the public health, safety and welfare.
 - 7. That the variance(s) requested are the minimum variance(s) needed to alleviate difficulties or hardships.
 - 8. That the use of the parcel in question presently does conform to the ordinance.

- 9. That granting the variance applied for will not affect the public health, safety, morals and welfare of the community and other properties in the area.
- 10. That with respect to those areas located within the floodland districts, a variance would not permit a change in the boundaries of the FPO Floodplain Overlay District; would not permit a lower degree of flood protection in the floodland districts than the floodplain elevation; would not allow any residential, commercial, institutional, or park basement or crawlway to be located below the 100-year recurrence interval flood elevation; would not allow a change or alteration of an historic structure, including its use, which would result in the structure losing its designation as an historic structure; further, that the variance for the proposed action would not require an amendment to the floodplain zoning ordinance; and furthermore, that the variance would not have the effect of granting or increasing a use property which is prohibited in the floodland districts or any action contrary to the provisions of Chapter NR 116 of the Wisconsin Administrative Code.
- 11. In addition to the criteria in subd. (10) above to qualify for a variance under FEMA regulations, the following criteria must be met:
 - a. The variance shall not cause any increase in the regional flood elevation;
 - b. Variances can only be granted for lots that are less than one-half acre and are contiguous to existing structures constructed below the RFE; and
 - c. Variances shall only be granted upon a showing of good and sufficient cause, shall be the minimum relief necessary, shall not cause increased risks to public safety or nuisances, shall not increase costs for rescue and relief efforts and shall not be contrary to the purpose of the ordinance.
- protection or where permitted by state statute but in no event may a variance be granted where the primary reason for obtaining a variance is to obtain a more profitable use of the property, personal inconvenience, construction errors, economic reasons, self-created hardships, or where the property is presently a non-conforming use. Furthermore, variances may not be granted for the purpose of altering the sanitary requirements of this ordinance except for existing structures.

 The Board of Adjustments in considering the propriety of granting a variance shall not consider the number of persons for or against the granting of a variance but shall base their decision solely upon the equities of the situation involved.

Variances may be granted for example for reasons of topography, environmental

When a floodplain variance is granted the Board shall notify the applicant in writing that it may increase risks to life and property and flood insurance premiums could increase up to \$25.00 per \$100.00 of coverage. A copy shall be maintained with the variance record.

variances shall be specifically prohibited under this Ordinance.

Variances may be granted in the form of an area or distance variance, however, use

A variance within any floodland district shall not:

use of a property.

- 1. Damage the rights or property values of other persons in the area;
- 2. Allow actions without the amendments to this ordinance or map(s) required in 12.60.040 Amendments; and
- 3. Allow any alteration of an historic structure, including its use, which would preclude its continued designation as an historic structure.

Statutory Standards

	The applicant for a variance must clearly show the Board of Adjustments that three statutory standards that govern granting a variance will be met. These three standards require the existence of an unnecessary hardship, the presence of a unique property limitation, and the protection of the public interest.
0	 Unnecessary Hardship A situation where, in the absence of a variance, an owner can make no feasible use of a property, or strict conformity is unnecessarily burdensome. The hardship or difficulty must be peculiar to the zoning parcel in question and different from that of other parcels, not one which affects all parcels similarly.
	 Unique Property Limitation Unique physical characteristics of the property must prevent the applicant from developing in compliance with the zoning ordinance.
	 Protection of the Public Interest Granting of a variance must neither harm the public interest nor undermine the purposes of the ordinance. The public interest includes the interests of the public at large, not just that of nearby property owners. Conditions may be attached to a variance to protect adjoining properties and to preserve the essential character of the neighborhood. A variance should include only the minimum relief necessary to allow reasonable.
	A variance should include only the minimum relief necessary to allow reasonable

VARIANCE WORKSHEET

YOUR THREE STATUTORY STANDARDS TO PROVE BEFORE THE BOARD OF ADJUSTMENTS. (BE READY TO DISCUSS AT THE MEETING)

UNNECESSARY HARDSHIP -

The current property has no parking. As the primary structure is located, there is no space for a car between the house and the street. Given the current zoning, there is no conceivable way for an addition to be constructed that is in compliance with the municipal code as it is written; largely due to the shape and size of the property, which the code does not seem designed for.

Parking for an owner's vehicle is a permitted use for a residential property, and there is no way to achieve this within the current code. We believe this constitutes a hardship.

Additionally, there is a provision in the Shoreland Regulations for a lateral expansion to the structure; in order to achieve this, the side-yard setback requires a variance (reduction) to allow for the lateral expansion to occur.

This lateral expansion is to address concerns with a trench footing on the south side of the house, and allow for an expansion to the bedroom so it is accessible for those with access impairments.

UNIQUE PROPERTY LIMITATION -

The shape of the property, size of the property, and the property's relationship to the road are very unique; which make compliance with setbacks that have been established since the primary structure was constructed in 1936 impossible.

The existing structure is within 2' of the street; a street which is excessively wide for the traffic it bares. Moreover, not all of the width of the street is plowed in the winter, frequently burrying cars and access to the house from residents.

We do not believe modifying this 2' setback to 0' will have any impact on the neighborhood, and instead will infact improve the use of the road and ability for pedestrians around the lake to stay away from cars.

Additionally, the combined slope of the site and street in the winter time is dangerous with snow and ice for walking. (Increasingly so as the owners age.)

PROTECTION OF THE PUBLIC INTEREST -

All 'compliant' alternatives for a 900SF addition require a modification to three aspects of the site's zoning per Chapter 12, Section 32.040 of Kenosha's Municipal Code.

- (G1) Street Setback: The current structure is within 2FT of the road, an addition will reduce this to 0FT.
- (G2) Shore Setback: The current structure is within 75FT of the water, an addition will maintain this dist.
- (G3) Sideyard Setback: The current structure adheres to the 10FT sideyard setback, we propose reducing this to 5' to allow space to create the addition.

12.09.100(b)2: The current site must maintain existing retaining walls, patio, & secondary structures; this is essential to protecting the dwelling from erosion and maintaining current drainage strategies - which includes dispering rain water from the patio into the hill, rather than allowing it to flow into the lake.

The effect on Drainage and Visual Impact would be marginal. Given that this is a private residence, there is very (if any) public interest in the land or project.